

ADDENDUM

Client: V.I.T. CUSD #2

Project Name: New Industrial Arts Building

Project Number: 6528 Addendum Number: 1 Issued: 05/02/2024

This addendum becomes a part of the bidding and contract documents and modifies the drawings and specifications dated April 19, 2024. Acknowledge receipt of this addendum by noting such on the Contractor's Proposal (Bid) Form.

FAILURE TO DO SO MAY SUBJECT BIDDER TO DISQUALIFICATION

This addendum and all future addenda with a Plan Holders List will be also be posted on the website of Architechnics and updated daily. Check the Current Projects tab on the site: www.architechnicsinc.com

THIS ADDENDUM DOES NOT CHANGE THE BID DATE

ITEM	DESCRIPTION	NOTES
GENERAL		
Electrical	Clarify	All conduit can be surface mounted on metal panels. Min 3/4".
Site	Add	Contractor is responsible for chain link style portable safety fencing for project safety.
		Contractors shall patch gravel roads, bituminous pavement, concrete sidewalks with like materials as required for utility and other site work. Utility infrastructure can be trenched or bored.
		No tapping fees for extending water service from existing building.
		All gas/electric connection fees will be paid by the owner. Not in Contract. See plans for additional information.
		ROE Building Permit By Owner

SPECIFICATIONS Section 00 0110	Delete	Delete Section 02 4119 "Selective Demolition" from the Project Manual.
Section 07 2119 2.01(A)	Add	Holcim is an approved manufacturer.
Section 07 2119 2.02(A)	Clarify	Insulation shall be open cell, not closed cell.
Section 08 3613 2.01(A)	Add	Wayne-Dalton is an approved manufacturer.
Section 09 5100	Add	Acoustical Ceilings section is attached and shall be added to the Project Manual.
Section 13 3418	Add	Post Frame Building System supplier shall belong to the National Frame Building Association and can meet or exceed any warranties listed.
		·
DRAWINGS		·
DRAWINGS Drawing C101	Replace	See new revised sheet.
	Replace Replace	See new revised sheet. See new revised sheet.
Drawing C101	·	
Drawing C101 Drawing A202	Replace	See new revised sheet.
Drawing C101 Drawing A202 Drawing A401	Replace Replace	See new revised sheet. See new revised sheet. Added foundation detail marks relating to foundation
Drawing C101 Drawing A202 Drawing A401 Drawing S101	Replace Replace Replace	See new revised sheet. See new revised sheet. Added foundation detail marks relating to foundation details. Replace entire sheet with new S101 Added foundation details. Replace entire sheet with
Drawing C101 Drawing A202 Drawing A401 Drawing S101 Drawing S300	Replace Replace Replace	See new revised sheet. See new revised sheet. Added foundation detail marks relating to foundation details. Replace entire sheet with new S101 Added foundation details. Replace entire sheet with new S300

Drawing E301

Add

All fire alarm wiring shall be installed in conduit. Coordinate with district FA vendor listed on plan for a complete fire alarm system.

This addendum consists of 3 pages; current Plan Holders List; Pre-Bid Attendance Record, Specifications 09 5100, Revised Drawings C101, A202, A401, S101, S300, P101, Captiveaire Hood and Fan specs, Revised Drawings E101, E201.

					PAGE NO. One						
NAME OF PROJECT	VIT Industrial Arts Building										
PROJECT NO. 6528	_DATE	BIDS DUE	Tuesday, May 7, 202	4 DEPOSIT	\$50.00						
TIME AND PLACE OF LETTING			3:30	PM							
	VIT CUSD										
*** Indicates Potential Bidding Cont	ractor										
CONTRACTOR NAME	COPY	DATE	DATE	DEPOSIT	DEPOSIT						
ADDRESS/PHONE/EMAIL	NO.	RECEIVED	RETURNED	RECEIVED	RETURNED						
Architect	#1										
Owner	#2										
Peters Heating & A/C 4520 Broadway											
Quincy, IL 62305											
217-222-1368	D	4/24/2024									
Fax 217-222-1088											
jhoward@petershvac.net											
Hein Construction											
9130 N Industrial Road Peoria, IL 61615											
309-691-4774	D	4/24/2024									
309-691-4673											
jstaggs@heinconstruction.com											
Batson Ace Hardware											
426 E Main St											
Bushnell, IL 61422 309-772-3700	D	4/24/2024									
003-112-0100											
batsonsacehardware@yahoo.com											
SDM Construction											
11393 Old Macomb Rd											
Rushville, IL 62681 217242880-9	D	4/24/2024									
217242860-9											
sdmconstruction08@gmail.com											
Arnold Bros. Heating Cooling											
1729 West Jackson St.											
Macomb, IL 61455	D	4/24/2024									
309-833-2852 Fax: 309-833-1523											
Info@arnbros.com											
Rupp Masonry											
2001 Jefferson St #111											
Quincy, IL 62301	D	4/24/2024									
217 257-0367											
mail@rupp1.com											
Fabcon Precast											
3373 Busch Dr.											
Grandville, MI 49418	D	4/24/2024									
616-224-6186		- -									
matt.vantol@fabconprecast.com											
Laverdiere Construction	+										
4055 W. Jackson											
Macomb, IL 61455	D	4/24/2024									
309-837-1258											
Fax 309-833-4993											
janderson@lavconinc.com											

PAGE NO. Two

NAME OF PROJECT VIT Industrial Arts Building

PROJECT NO. 6528				DEPOSIT:	\$50.00
CONTRACTOR NAME	COPY	DATE	DATE	DEPOSIT	DEPOSIT
ADDRESS/PHONE/EMAIL	NO.	RECEIVED	RETURNED	RECEIVED	RETURNED
*** CAD Construction	1101				
508 East Pearl Street #A1					
Tremont, IL 61568					
309-925-2092	D	4/24/2024			
Fax: 309-925-2091					
nate@cadconstructioninc.com					
*** Trotter General Contracting, Inc					
900 Doran Drive					
Macomb, IL 61455	D	4/24/2024			
309-836-5040					
Fax: 309-836-3756					
tgci820@yahoo.com					
St. Louis Prestress					
16 Commercial Ct.					
Glen Carbon, IL 62034	D	4/24/2024			
618-656-8934		4/24/2024			
kyle.varble@stlprestress.com					
Otto Baum Company, Inc.					
866 N. Main Street					
Morton, Illinois 61550		410410004			
309-266-7114	D	4/24/2024			
Fax: 309-263-1050					
estimating@ottobaum.com					
Kelly Glass			 		
2400 S.W. Adams St.					
Peoria, IL 61602					
309-676-3573	D	4/24/2024			
fax: 309.676.3722					
Sales@kellyglass.com Southern Illinois Builders Association			+		
	7				
1468 Green Mount Road					
O'Fallon IL 62269	D	4/24/2024			
618-624-9055					
Fax: 618-624-9065					
projects@siba-agc.org					
RJI Sales					
221 Chesterfield Industrial Blvd					
Chesterfield, MO 63005	D	4/24/2024			
636-532-1050	'	4/24/2024			
Fax: 636-532-5464					
norman.rhea@rji-sales.com					
*** Leander Construction					
24472 North County Highway 6					
Canton, IL 61520		410410004			
309-647-7400	D	4/24/2024			
Fax: 309 647-7401					
ryan@leanderconstructioninc.com					
Mid-States Concrete Industries	1				
500 South Park Avenue					
South Beloit, IL 61080					
800-236-1072	D	4/25/2024			
000-200-1072					
t voun@monrocot com					
t.yaun@msprecast.com	+ +				
Dragoo Painting					
PO Box 722					
Peoria, IL 61652	D	4/25/2024			
309-686-0782	-				
Fax: 309-383-4364					
dragoopt@mtco.com					

PAGE NO. Three

NAME OF PROJECT VIT Industrial Arts Building

PROJECT NO. 6528				DEPOSIT:	\$50.00
CONTRACTOR NAME	COPY	DATE	DATE	DEPOSIT	DEPOSIT
ADDRESS/PHONE/EMAIL	NO.	RECEIVED	RETURNED	RECEIVED	RETURNED
Johnson Plumbing Inc.					
295 East Penn. Ave					
Roseville, IL 61473		4/05/0004			
309-426-7586	D	4/25/2024			
johnsonplumbing99@hotmail.com					
Menards - Quincy					
monardo Quinoy					
217-228-5112	D	4/25/2024			
Fax: 217-228-1333					
QNCYBuildingmaterials@menards.c	3				
*** Midwest Construction Professionals	S				
520 E Highland					
Morton, IL 61550	D	4/25/2024			
309-291-0913		7/23/2027			
jeff@midconpro.com					
Montefusco HVAC, Inc.					
2200 W Altorfer Dr D					
Peoria, IL 61615					
309-691-7400	D	4/25/2024			
wes@montefuscohvac.com					
*** Conley Concrete Construction	<u> </u>				
703 E North St					
Knoxville, IL 61448					
309-368-0143	D	4/25/2024			
309-366-0143					
jlorenzen@conleyconcreteconstruc	CI .				
Standard Heating & Cooling					
906 S.W. ADAMS					
PEORIA, ILLINOIS 61602	D	4/25/2024			
309-671-5417		4/23/2024			
Fax: 309-671-5405					
bewalt@standardheat.com					
Construction.com					
	1 _ 1	41001000			
	D	4/26/2024			
darlene.baker-mann@construction.					
*** Veterans Construction	1				
219 N Jackson St					
Rushville, IL 62681					
217-248-9055	D	4/26/2024			
217-240-9000					
dovtorgoddord2000@=====!! -===					
dextergoddard2008@gmail.com	+ +				
*** Blunier Builders					
97 Eastgate Dr					
Washington, IL 61571	D	4/26/2024			
309-467-4847		71 E 01 E 0 E 7			
jake.bond@blunierbuilders.com					
United Contractors Midwest					
121 W. Park Street					
Tremont, Illinois 61568		410010004			
309-925-2711	D	4/29/2024			
309-925-7131					
brandon.beck@ucm.biz					
prandon.peck@dcin.blz					

PAGE NO. Four

NAME OF PROJECT VIT Industrial Arts Building

PROJECT NO. 6528 CONTRACTOR NAME	COPY	DATE	DATE	DEPOSIT:	\$50.00 DEPOSIT
ADDRESS/PHONE/EMAIL	NO.	RECEIVED	RETURNED	RECEIVED	RETURNED
Commercial Mechanical Inc.	NO.	RECEIVED	KETOKNED	RECEIVED	KETOKNED
50 N 1st St					
Dunlap, IL 61525	D	4/29/2024			
309-243-7768		4/29/2024			
jessica@cmipiping.com Morton Buildings, Inc					
252 W Adams					
Morton, IL 61550	_				
309-263-6486	D	5/1/2024			
Fax: 309-263-3600					
Steve.Hamm@mortonbuildings.com					
Accu Air					
851 E South St					
lpava, IL 61441 309-303-6141	D	5/1/2024			
309-303-6141					
mwoodsaa@gmail.com					
Construct Connect					
3825 Edwards Road, STE. 800					
Cincinnati, OH 45209	D	5/2/2024			
800-364-2059		O/L/LUL4			
content@constructconnect.com Johnco Construction, Inc					
107 W First St					
Mackinaw, IL 61755	_	=1010001			
309-359-3000	D	5/2/2024			
Fax: 309-359-3900					
bobberns@johncoconstruction.com					
			1	i	i l



ATTENDANCE RECORD

Project No.: 6528

Project Name: VIT Industrial Arts Building

Tabler Grove, IL

Meeting Description: Pre-Bid

Date: April 30, 2024 Time: 10:00 AM Place: VIT CUSD

Attendant

Name & Title	Representing	Phone Number/email
1. <u>Isaac Miller</u>	Architechnics 217-2	222-0554 imiller@architechnicsinc.com
2. Brian Spencer	Architechnics 217-222-055	4 bspencer@architechnicsinc.com
3. Matt Klashe	VIT	mhlasha Q vitz.org
4. Jeff Pfleden	MCP	Jeffemidconpro. com
5. AARON AJEN	auxa Electric	AQQQUICICELECTRIC. NET
6. Billy Cramer	Lavediere	became @ Javeonine. com
7. RYAN PHIPPS	CAD CONST. INC	RYAN @ CAD CONSTRUCTION/ILIC.COM
8. DAVID STAGES	HEIN CONSTRUCTION	JSTAGGG @HEENCONSMUCTSON. 6M
9,		
10		
11		
12		
13		
16		
17.	A.	

SECTION 09 5100 ACOUSTICAL CEILINGS

PART 1 GENERAL

1.01 SECTION INCLUDES

- A. Suspended metal grid ceiling system.
- B. Acoustical units.

1.02 REFERENCE STANDARDS

- ASTM A653/A653M Standard Specification for Steel Sheet, Zinc-Coated (Galvanized) or Zinc-Iron Alloy-Coated (Galvannealed) by the Hot-Dip Process; 2023.
- B. ASTM C635/C635M Standard Specification for Manufacture, Performance, and Testing of Metal Suspension Systems for Acoustical Tile and Lay-in Panel Ceilings; 2022.
- C. ASTM E1264 Standard Classification for Acoustical Ceiling Products; 2023.

1.03 SUBMITTALS

- A. See Section 01 3000 Administrative Requirements for submittal procedures.
- B. Product Data: Provide data on suspension system components and acoustical units.

1.04 QUALITY ASSURANCE

- A. Suspension System Manufacturer Qualifications: Company specializing in manufacturing the products specified in this section with minimum three years documented experience.
- B. Acoustical Unit Manufacturer Qualifications: Company specializing in manufacturing the products specified in this section with minimum three years documented experience.

1.05 FIELD CONDITIONS

A. Maintain uniform temperature of minimum 60 degrees F, and maximum humidity of 40 percent prior to, during, and after acoustical unit installation.

PART 2 PRODUCTS

2.01 MANUFACTURERS

- A. Acoustic Tiles/Panels:
 - 1. Armstrong World Industries, Inc: www.armstrongceilings.com/#sle.
 - 2. Certainteed Architectural: www.certainteed.com/ceilings-and-walls/#sle.
 - 3. USG Corporation: www.usg.com/ceilings/#sle.
 - 4. Substitutions: See Section 01 6000 Product Requirements.
- B. Suspension Systems:
 - 1. Same as for acoustical units.

2.02 ACOUSTICAL UNITS

- A. Acoustical Units General: ASTM E1264, Class A.
- B. Acoustical Panels: Painted mineral fiber, with the following characteristics:
 - 1. Classification: ASTM E1264 Type III.
 - 2. Size: 24 by 24 inches.
 - 3. Thickness: 3/4 inch.
 - 4. Panel Edge: Square.
 - 5. Color: As selected by Architect.
 - Suspension System: Exposed grid.
- C. Acoustical Panels, Type ____: Mineral fiber with membrane-faced overlay, with the following characteristics:
 - 1. Application(s): Toilet rooms.

Acoustical Ceilings 09 5100 - 1

- 2. Classification: ASTM E1264 Type IV.
- 3. Size: 24 by 24 inches.
- 4. Thickness: 3/4 inch.
- 5. Panel Edge: Square.
- 6. Color: As selected by Architect.
- 7. Suspension System: Exposed grid.

2.03 SUSPENSION SYSTEM(S)

- A. Metal Suspension Systems General: Complying with ASTM C635/C635M; die cut and interlocking components, with perimeter moldings, hold down clips, stabilizer bars, clips, and splices as required.
- B. Metal Suspension Systems General: Complying with ASTM C635/C635M; die cut and interlocking components, with perimeter moldings, hold down clips, stabilizer bars, clips, and splices as required.
 - 1. Materials:
 - a. Steel Grid: ASTM A653/A653M, G30 coating, unless otherwise indicated.

2.04 ACCESSORIES

- A. Support Channels and Hangers: Galvanized steel; size and type to suit application, seismic requirements, and ceiling system flatness requirement specified.
- B. Hanger Wire: 12 gauge, 0.08 inch galvanized steel wire.
- C. Perimeter Moldings: Same metal and finish as grid.

PART 3 EXECUTION

3.01 EXAMINATION

- A. Verify existing conditions before starting work.
- B. Verify that layout of hangers will not interfere with other work.

3.02 PREPARATION

- A. Install after major above-ceiling work is complete.
- B. Coordinate the location of hangers with other work.

3.03 INSTALLATION - SUSPENSION SYSTEM

- Rigidly secure system, including integral mechanical and electrical components, for maximum deflection of 1:360.
- B. Perimeter Molding: Install at intersection of ceiling and vertical surfaces and at junctions with other interruptions.
 - Use longest practical lengths.
- C. Suspension System, Non-Seismic: Hang suspension system independent of walls, columns, ducts, pipes and conduit. Where carrying members are spliced, avoid visible displacement of face plane of adjacent members.
- D. Where ducts or other equipment prevent the regular spacing of hangers, reinforce the nearest affected hangers and related carrying channels to span the extra distance.
- E. Do not support components on main runners or cross runners if weight causes total dead load to exceed deflection capability.
- F. Support fixture loads using supplementary hangers located within 6 inches of each corner, or support components independently.
- G. Do not eccentrically load system or induce rotation of runners.

3.04 INSTALLATION - ACOUSTICAL UNITS

A. Install acoustical units in accordance with manufacturer's instructions.

Acoustical Ceilings 09 5100 - 2

- B. Fit acoustical units in place, free from damaged edges or other defects detrimental to appearance and function.
- C. Fit border trim neatly against abutting surfaces.
- D. Install acoustical units level, in uniform plane, and free from twist, warp, and dents.
- E. Cutting Acoustical Units:
 - 1. Make field cut edges of same profile as factory edges.

3.05 TOLERANCES


- A. Maximum Variation from Flat and Level Surface: 1/8 inch in 10 feet.
- B. Maximum Variation from Plumb of Grid Members Caused by Eccentric Loads: 2 degrees.

3.06 CLEANING

- A. See Section 01 7000 Execution and Closeout Requirements for additional requirements.
- B. Clean surfaces.
- C. Replace damaged or abraded components.

END OF SECTION

Acoustical Ceilings 09 5100 - 3

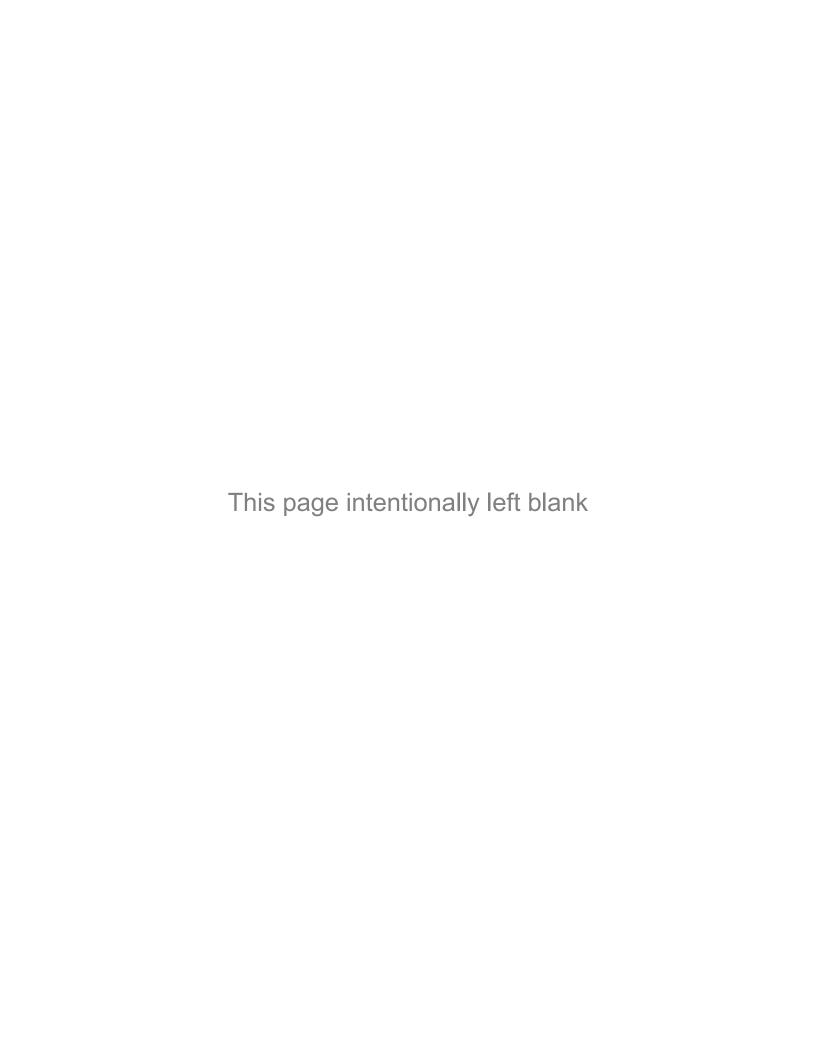

SITE KEYED NOTES

- 1. EXISTING TREES TO BE REMOVED BY OWNER. CONTRACTOR
- 2. EXISTING LIGHT POLE TO REMAIN
- 4. EXISTING COOLER AND SUPPORT PAD TO REMAIN
- 5. EXISTING SIDEWALK TO REMAIN, MATCH NEW PAVING ELEVATIONS
- TO EXISTING, SEE DETAIL 2/C101 6. NEW CONCRETE STOOP, SEE DETAIL 1/C101 - TURN DOWN EDGE OF
- 7. MATCH ELEVATIONS AT NEW DRIVEWAY PAVING, SEE DETAIL 2/C101
- 8. EXISTING MANHOLE TO REMAIN
- 9. NEW 4" SANITARY SEWER LINE TO BUILDING, CONNECT INTO EXISTING MANHOLE, FIELD VERIFY FLOW ELEVATIONS. ENCASE PIPING AS/WHERE REQUIRED
- 10. EXISTING BUILDING TO REMAIN
- 11. EXISTING TREES TO REMAIN
- 12. GRADE AND RESEED IN THIS AREA AS REQUIRED
- 13. NEW CONCRETE DRIVE, SEE DETAIL 1/C101
- 14. ELECTRICAL CONTRACTOR INSTALL EMPTY 4" SCHEDULE 80 CONDUIT WITH STAND-OFFS DOWN EXISTING POLE. EXTEND SCHEDULE 40 CONDUIT UNDERGROUND AS SHOWN TO NEW TRANSFORMER LOCATION. INSTALL PULL WIRE AS REQUIRED. COORDINATE WITH UTILITY COMPANY.
- 15. NEW 1" WATER SERVICE LINE WITH ISOLATION VALVE TO NEW BUILDING FROM EXISTING BUILDING, REMOVE AND PATCH CONCRETE FLOOR AS REQUIRED IN WATER SERVICE ROOM IN CORNER OF BUILDING. FIELD VERIFY CONNECTION LOCATION. ENCASE PIPING AS REQUIRED.
- 16. NEW NATURAL GAS SERVICE LINE, CONNECT TO EXISTING SERVICE, FIELD VERIFY LOCATION AND SIZE OF SERVICE REQUIRED
- 17. ELECTRICAL CONTRACTOR PULL SET OF 16/2 AND 18/2 FIRE ALARM WIRING IN EXISTING EMPTY CONDUIT FROM EXISTING FIRE ALARM PANEL IN BOILER ROOM (SEE NOTE 18) TO THIS LOCATION AT EXISTING SHED. INSTALL PULL BOX AND EXTEND NEW 2" CONDUIT AND FIRE ALARM WIRING TO CONNECT TO THE HIGH SCHOOL PANEL IN THE FUTURE.
- 18. EXISTING FIRE ALARM PANEL.

JOINT SEALER —

JOINT SEALER -

JOINT SEALER -

1/4" WIDE

#4 BARS x 24" LG.-

@ 30" O.C.

1/4" WIDE

19. INSTALL ~6'X6' CONCRETE TRANSFORMER PAD. COORDINATE WITH WITH UTILITY COMPANY.

TYPE A

TYPE B

LONGITUDINAL OR TRANSVERSE

CONSTRUCTION JOINT

TIED LONGITUDINAL OR TRANSVERSE CONSTRUCTION JOINT


EXPANSION JOINT

PREFORMED EXP.

JOINT FILLER


– 1/8" RADIUS

- 1/8" RADIUS

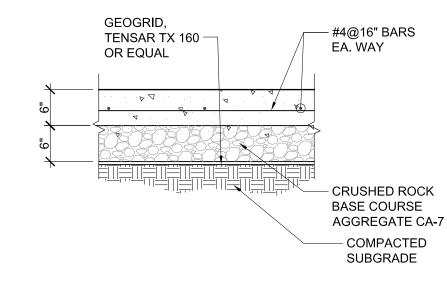


TYP. PARKING LOT/SIDEWALK

CONCRETE PAVING DETAILS 1 SCALE: 3/4" = 1'-0"

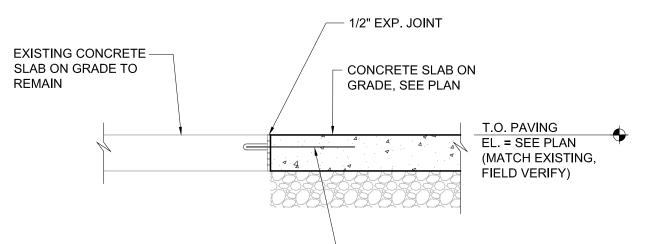


- #4@18" DOWELS INTO EXISTING CONC. SLAB, DEWALT 'AC200+' SYSTEM OR APPROVED EQUAL, MIN. 3 1/2" EMBED INTO EXISTING CONCRETE

CONCRETE PAVING DETAIL

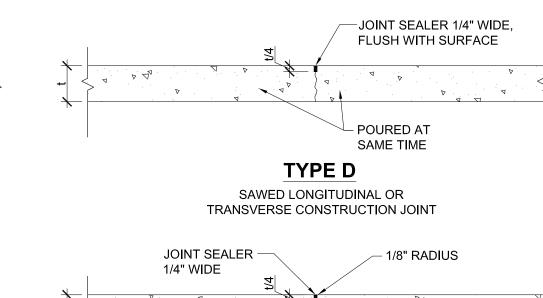

- LUBRICATE ONE END t/8 SMOOTH DOWEL BUTT JOINT FORMED BARS x 14" LG. @ 12" **BULK HEAD** ALTERNATE TRANSVERSE CONSTRUCTION JOINT AT NORMAL SPACING

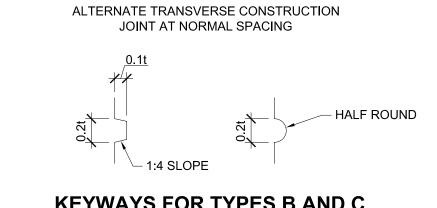

KEYWAYS FOR TYPES B AND C

CONSTRUCTION JOINTS

LICENSE EXPIRES: 11/30/24

CURRENT DATE: 4/19/2024

CONCRETE PAVING JOINT NOTES:

1. AT INLETS, MANHOLES AND OTHER STRUCTURES, TRANSVERSE JOINTS SHALL BE SHORTENED ONE OR MORE PANELS EITHER SIDE OF THE STRUCTURE TO PERMIT JOINTS TO FALL AT THE CORNERS OF THE BOX-OUT. ONE OR BOTH "L" DIMENSIONS OF THE BOX-OUT MAY BE ADJUSTED TO PROVIDE FOR INTERSECTION OF LONGITUDINAL JOINTS AT BOX-OUT CORNERS.

2. ALL TRANSVERSE JOINTS MUST EXTEND THROUGH CURBS AND MUST BE CONTINUOUS ACROSS PAVEMENT, EXCEPT TIED TRANSVERSE CONSTRUCTION JOINTS. EXPANSION JOINTS WILL BE REQUIRED AS SHOWN ON PLANS. 3. MAXIMUM TRANSVERSE JOINT SPACING SHALL BE 15 FEET, UNLESS

OTHERWISE SPECIFIED. 4. PAVEMENT JOINTS SHALL BE SEALED WITH HOT POUR MATERIAL MEETING THE REQUIREMENTS OF ASTM D3405. 5. DEFORMED BARS CONFORMING TO THE REQUIREMENTS OF AASHTO M-31 OR M-53 GRADE 40 SHALL BE USED FOR THE TIE BARS. 6. TYPE B JOINTS WHICH ARE TO BE COATED SHALL RECEIVE TWO COATS OF ASPHALTIC EMULSION PRIOR TO PLACEMENT OF THE

ADJACENT PAVEMENT. 7. TYPE D JOINTS MAY BE USED IN LIEU OF TYPES B OR C JOINTS WHEN SLABS ON BOTH SIDES OF THE JOINT ARE POURED INTEGRALLY. 8. SUPPORT PINS FOR THE TIE BARS, WHEN REQUIRED, SHALL BE OF

SIZE AND STRENGTH SUFFICIENT TO FIRMLY HOLD THE BAR IN PLACE. 9. THE ALTERNATE CONSTRUCTION OF INTEGRAL OR SEPARATE COMBINATION CURB AND GUTTER IS AT THE CONTRACTOR'S OPTION.

CONCRETE PAVEMENT JOINT DETAILS

CONC. PAVING, SEE -DETAIL 1/C501 - GRADE, SEE SITE PLAN TURN DOWN EDGE AT -PARKING LOT PERIMETER (TYP)

PAVING EDGE DETAIL

SCALE: 1" = 1'-0"

SITE PLAN GENERAL NOTES:

- 1. SITE CLEAN-UP SHALL BE PERFORMED ON A DAILY BASIS. SIDEWALKS, CLEAN AT ALL TIMES.
- 2. CONTROL DUST IN AND AROUND ALL WORK AND STAGING AREAS. ALL OPEN EXCAVATIONS SHALL BE PROTECTED.
- PROJECT DURATION.

LEGEND

ELEVATION
ATION
OUR LINE
LINE
INE
E
R LINE

PARKING LOTS, ROADWAYS, AND THE PROJECT SITE SHALL BE KEPT

3. MAINTAIN POSITIVE DRAINAGE ON THE SITE THROUGHOUT THE


PHASE **ISSUED FOR BIDDING** ISSUE DATE: 4/19/2024

CONSTRUCTION DOCUMENT

PARTIAL SITE PLAN

PROJECT NUMBER: 6528




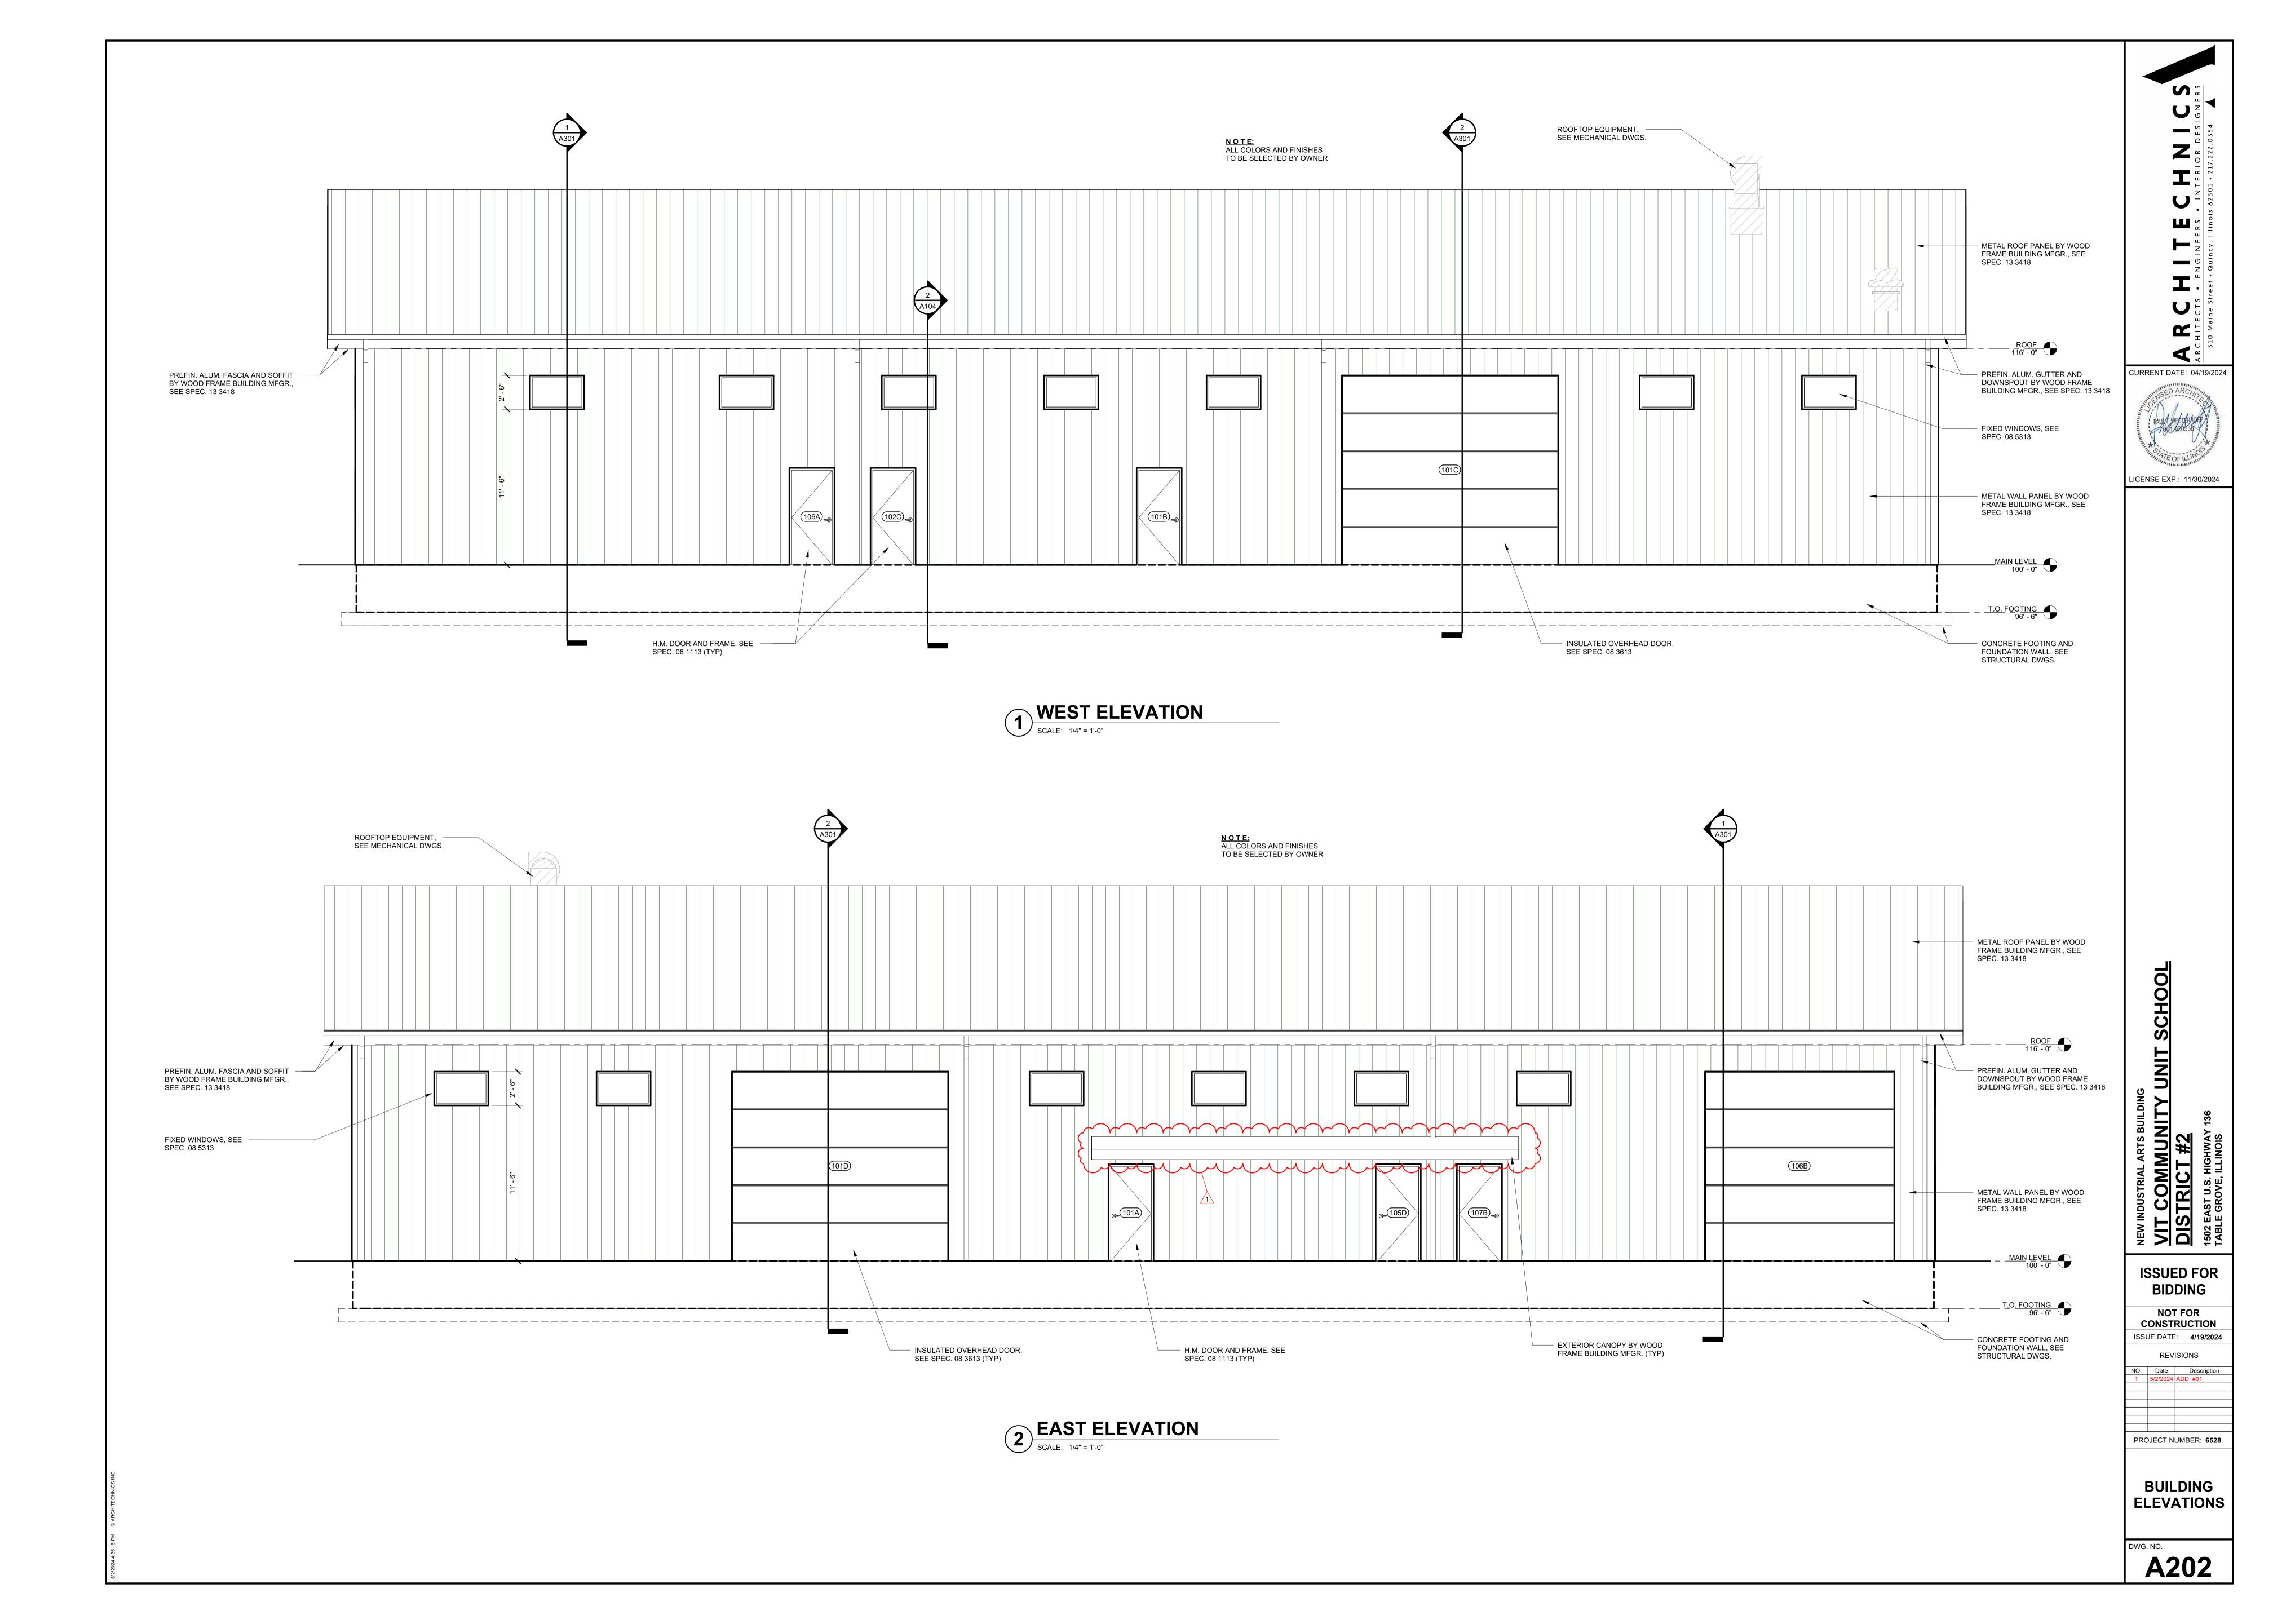


				I							
DOOR		SIZE			DOOR			FRAME		HARDWARE	COMMENTS
NUMBER	WIDTH	HEIGHT	THICKNESS	MATERIAL	FINISH	TYPE	MATERIAL	FINISH	TYPE	TIV II (BVV) II (E	JOHNNETTE
101A	3' - 0"	7' - 0"	1 3/4"	HM	PAINT	D1	HM	PAINT	F1	3	
101B	3' - 0"	7' - 0"	1 3/4"	НМ	PAINT	D1	НМ	PAINT	F1	3	
101C	16' - 0"	14' - 0"	2"	OH DOOR	PREFIN	D3					MOTORIZED OPERATION
101D	16' - 0"	14' - 0"	2"	OH DOOR	PREFIN	D3					MOTORIZED OPERATION
102A	10' - 0"	12' - 0"	2"	OH DOOR	PREFIN	D3					MANUAL OPERATION
102B	10' - 0"	12' - 0"	2"	OH DOOR	PREFIN	D3					MANUAL OPERATION
102C	3' - 0"	7' - 0"	1 3/4"	НМ	PAINT	D1	НМ	PAINT	F1	3	
103	3' - 0"	7' - 0"	1 3/4"	НМ	PAINT	D1	НМ	PAINT	F1	1	
104	3' - 0"	7' - 0"	1 3/4"	НМ	PAINT	D1	НМ	PAINT	F1	1	
105A	3' - 0"	7' - 0"	1 3/4"	НМ	PAINT	D2	НМ	PAINT	F1	2	
105B	3' - 0"	7' - 0"	1 3/4"	НМ	PAINT	D2	НМ	PAINT	F1	2	
105C	3' - 0"	7' - 0"	1 3/4"	НМ	PAINT	D2	НМ	PAINT	F1	2	
105D	3' - 0"	7' - 0"	1 3/4"	НМ	PAINT	D1	НМ	PAINT	F1	3	
106A	3' - 0"	7' - 0"	1 3/4"	НМ	PAINT	D1	НМ	PAINT	F1	3	
106B	14' - 0"	14' - 0"	2"	OH DOOR	PREFIN	D3					MOTORIZED OPERATION
106C	3' - 0"	7' - 0"	1 3/4"	НМ	PAINT	D1	НМ	PAINT	F1	3	
107A	3' - 0"	7' - 0"	1 3/4"	HM	PAINT	D2	HM	PAINT	F1	2	
107B	3' - 0"	7' - 0"	1 3/4"	НМ	PAINT	D1	HM	PAINT	F1	3	+

DOOR SCHEDULE NOTES:

1. HOLLOW METAL DOORS AND FRAMES - SEE SPEC. 08 1113 2. INSULATED OVERHEAD DOORS - SEE SPEC. 08 3613

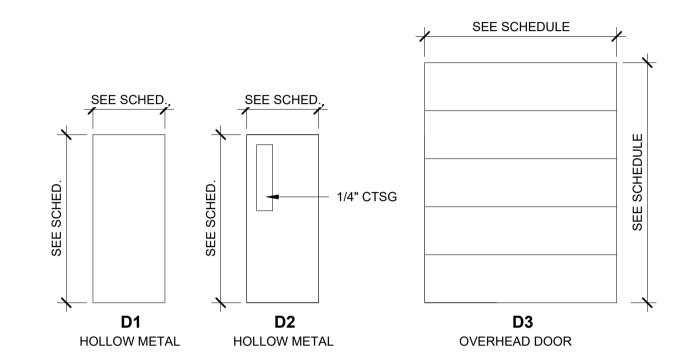


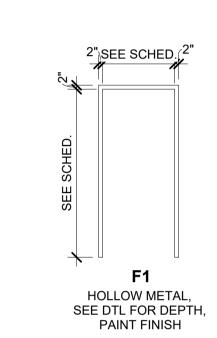





5 DOOR FRAME TYPES


SCALE: 1/4" = 1'-0"

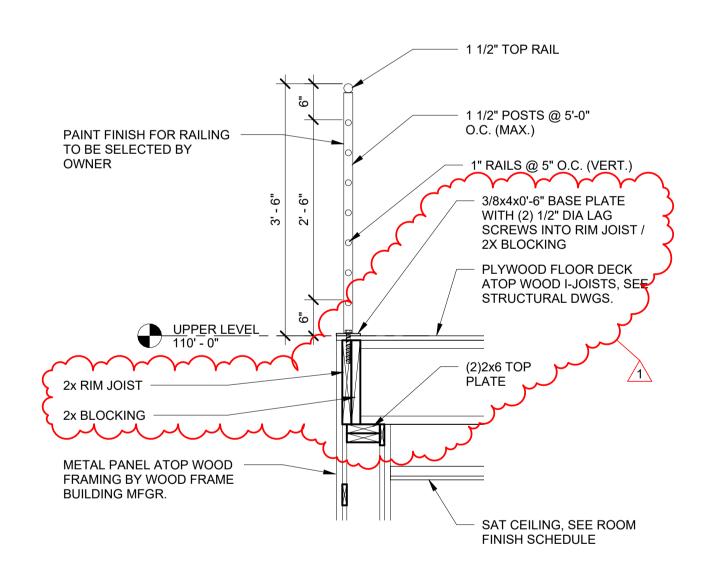

6 GUARDRAIL DETAIL
SCALE: 3/4" = 1'-0"

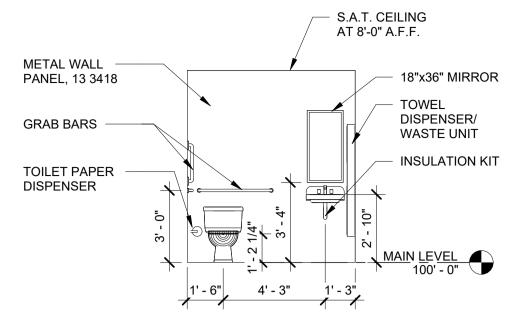

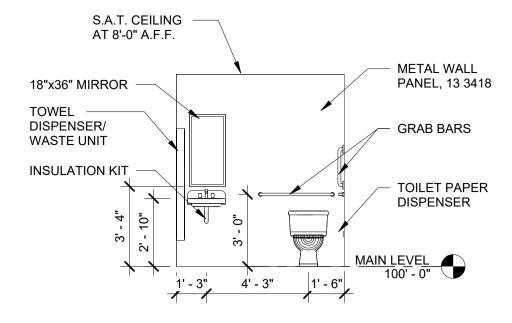

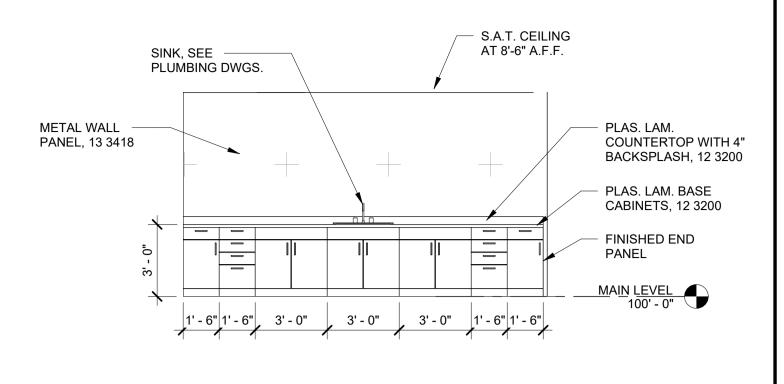

1 INTERIOR ELEVATION SCALE: 1/4" = 1'-0"



3 INTERIOR ELEVATION
SCALE: 1/4" = 1'-0"

INTERIOR ELEVATION NOTES:

SEE PLUMBING DRAWINGS FOR PLUMBING FIXTURES
 TOILET ROOM ACCESSORIES - SEE SPEC. 10 2800

	ROOM SCHEDULE											
Room Number	Room Name	Floor Finish	Base Finish	Wall Finish	Ceiling Finish	Ceiling Height	Comments					
101	SHOP	CONCRETE	NONE	METAL PANEL	METAL LINER PANEL	16' - 0"						
102	CNC	CONCRETE	NONE	METAL PANEL	METAL LINER PANEL	16' - 0"						
103	WOMEN	CONCRETE	NONE	METAL PANEL	SAT	8' - 0"						
104	MEN	CONCRETE	NONE	METAL PANEL	SAT	8' - 0"						
105	CLASSROOM	CONCRETE	NONE	METAL PANEL	SAT	8' - 6"	SEE DWG. A104 FOR ALT. BID FINISHES					
106	MAINTENANCE	CONCRETE	NONE	METAL PANEL	METAL LINER PANEL	16' - 0"						
107	CLASSROOM	CONCRETE	NONE	METAL PANEL	SAT	8' - 6"						
201	MEZZANINE	PLYWOOD	NONE	METAL PANEL	METAL LINER PANEL	16' - 0"	SEE DWG. A104 FOR ALT. BID FINISHES					
202	MEZZANINE	PLYWOOD	NONE	METAL PANEL	METAL LINER PANEL	16' - 0"						



CURRENT DATE: 04/19/2024

PAUL MESTRIOR

1001 020538

LICENSE EXP.: 11/30/2024

RIAL ARTS BUILDING
MMUNITY UNIT SCHOOL
CT #2

ISSUED FOR BIDDING

NOT FOR CONSTRUCTION

ISSUE DATE: 4/19/2024

REVISIONS

REVISIONS


Date Description
5/2/2024 ADD. #01

PROJECT NUMBER: 6528

SCHEDULES AND DETAILS

MG. NO. **A401**

5/2/2024 4:35:24 PM © ARCHITECHNICS IN

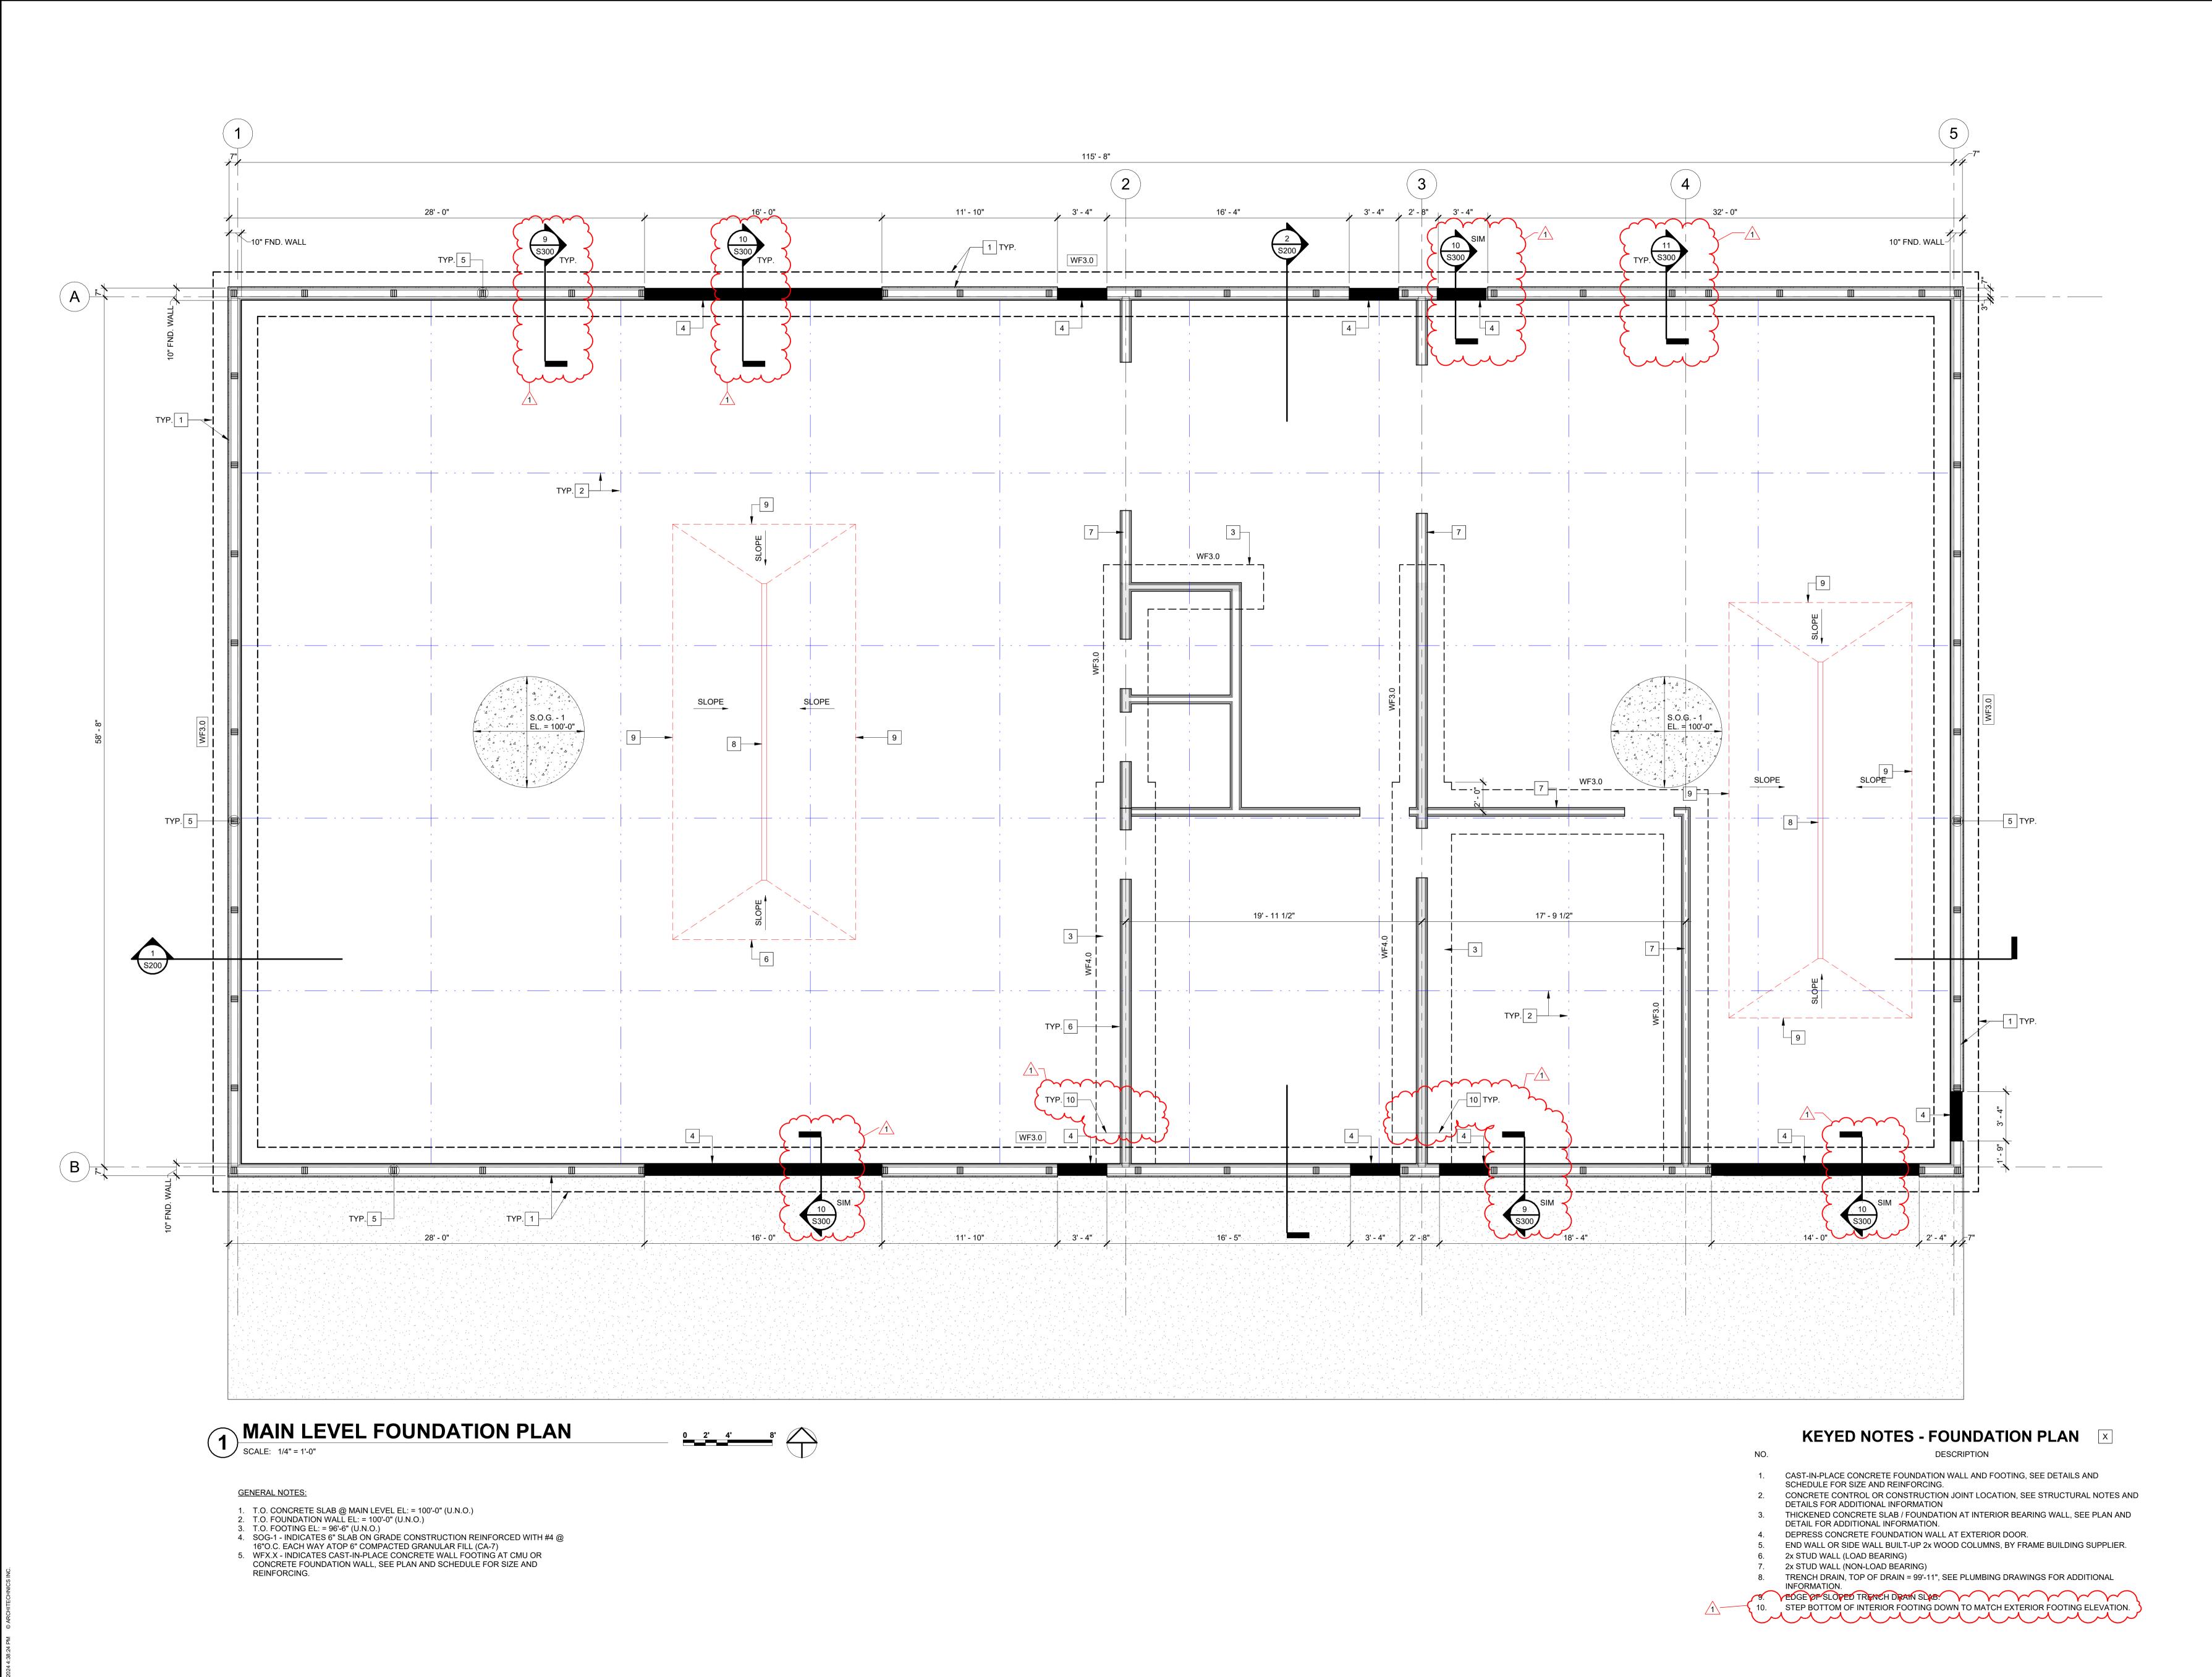

ARCHITECTS • ENGINEERS • INTERIOR DESIGNERS
510 Maine Street • Quincy, Illinois 62301 • 217.222.0554

CURRENT DATE: 04/19/2024

PAUL MEDIENO
PAUL

TRIAL ARTS BUILDING

| OMMUNITY UNIT SCHOOL

ISSUED FOR BIDDING

NOT FOR
CONSTRUCTION
ISSUE DATE: 4/19/2024

REVISIONS


Date Description
5/2/2024 ADD. #01


Date Description
5/2/2024 ADD. #01

PROJECT NUMBER: 6528

MAIN LEVEL FOUNDATION PLAN

DWG. NO.

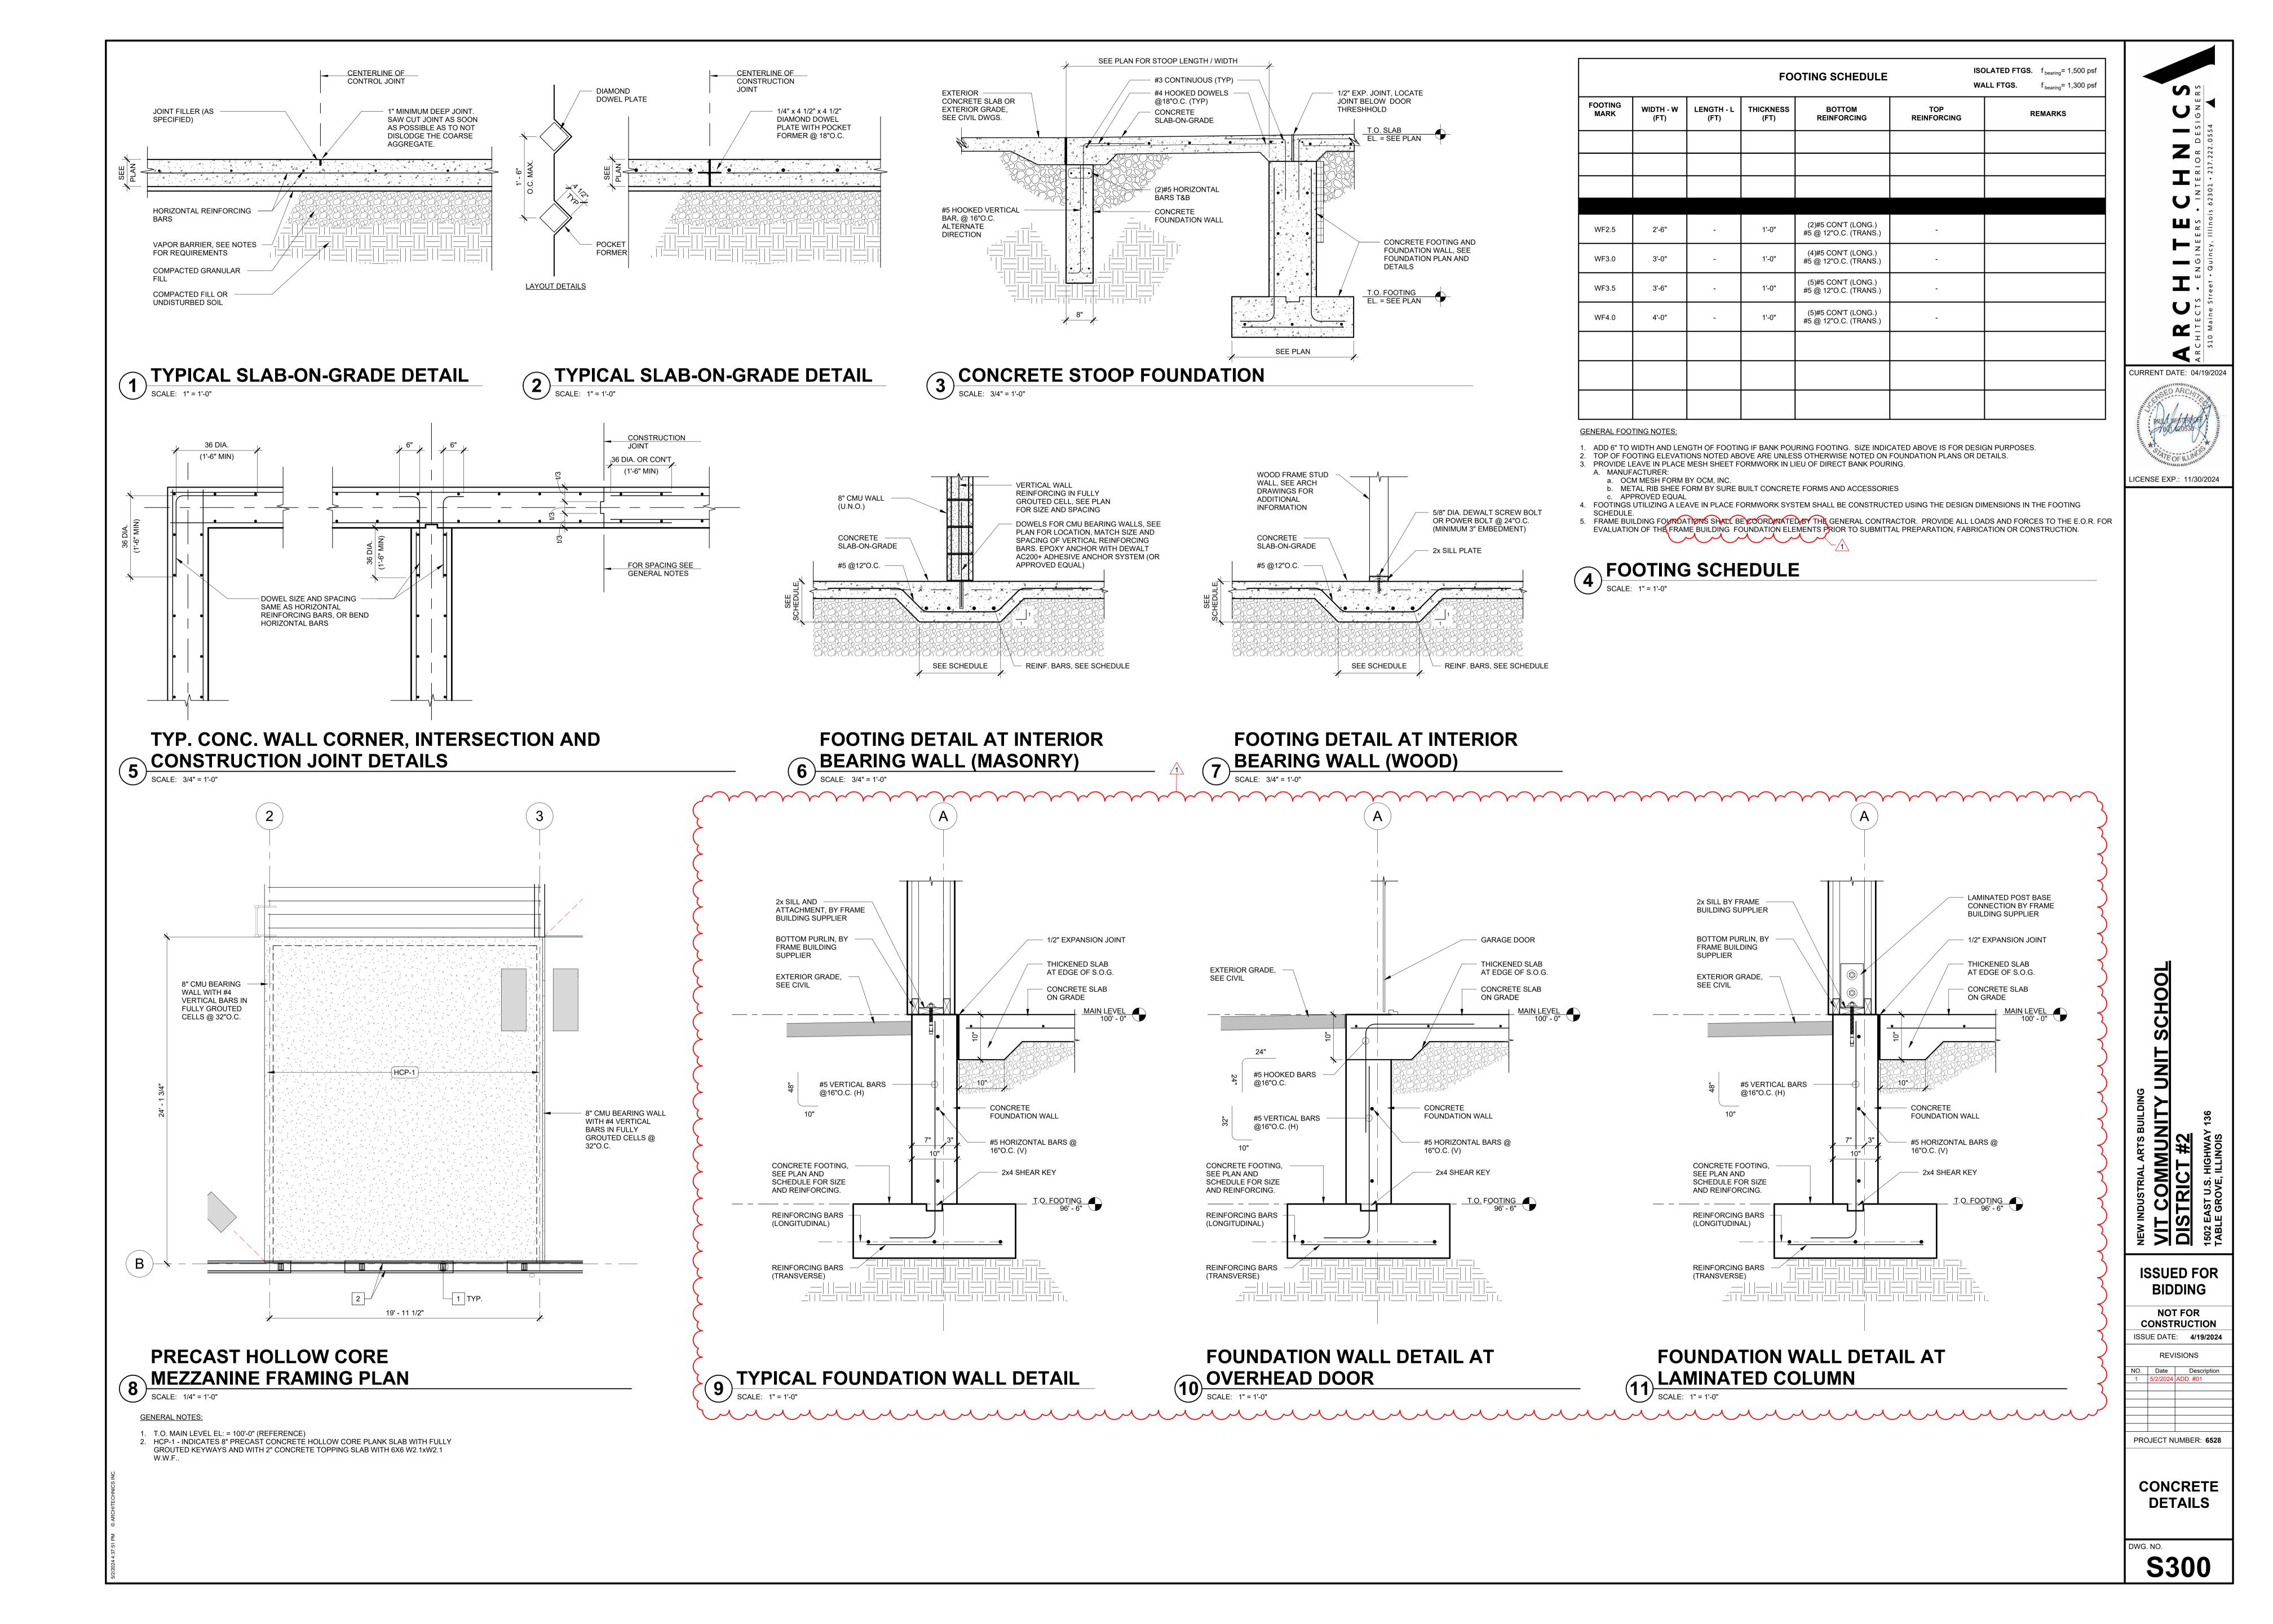


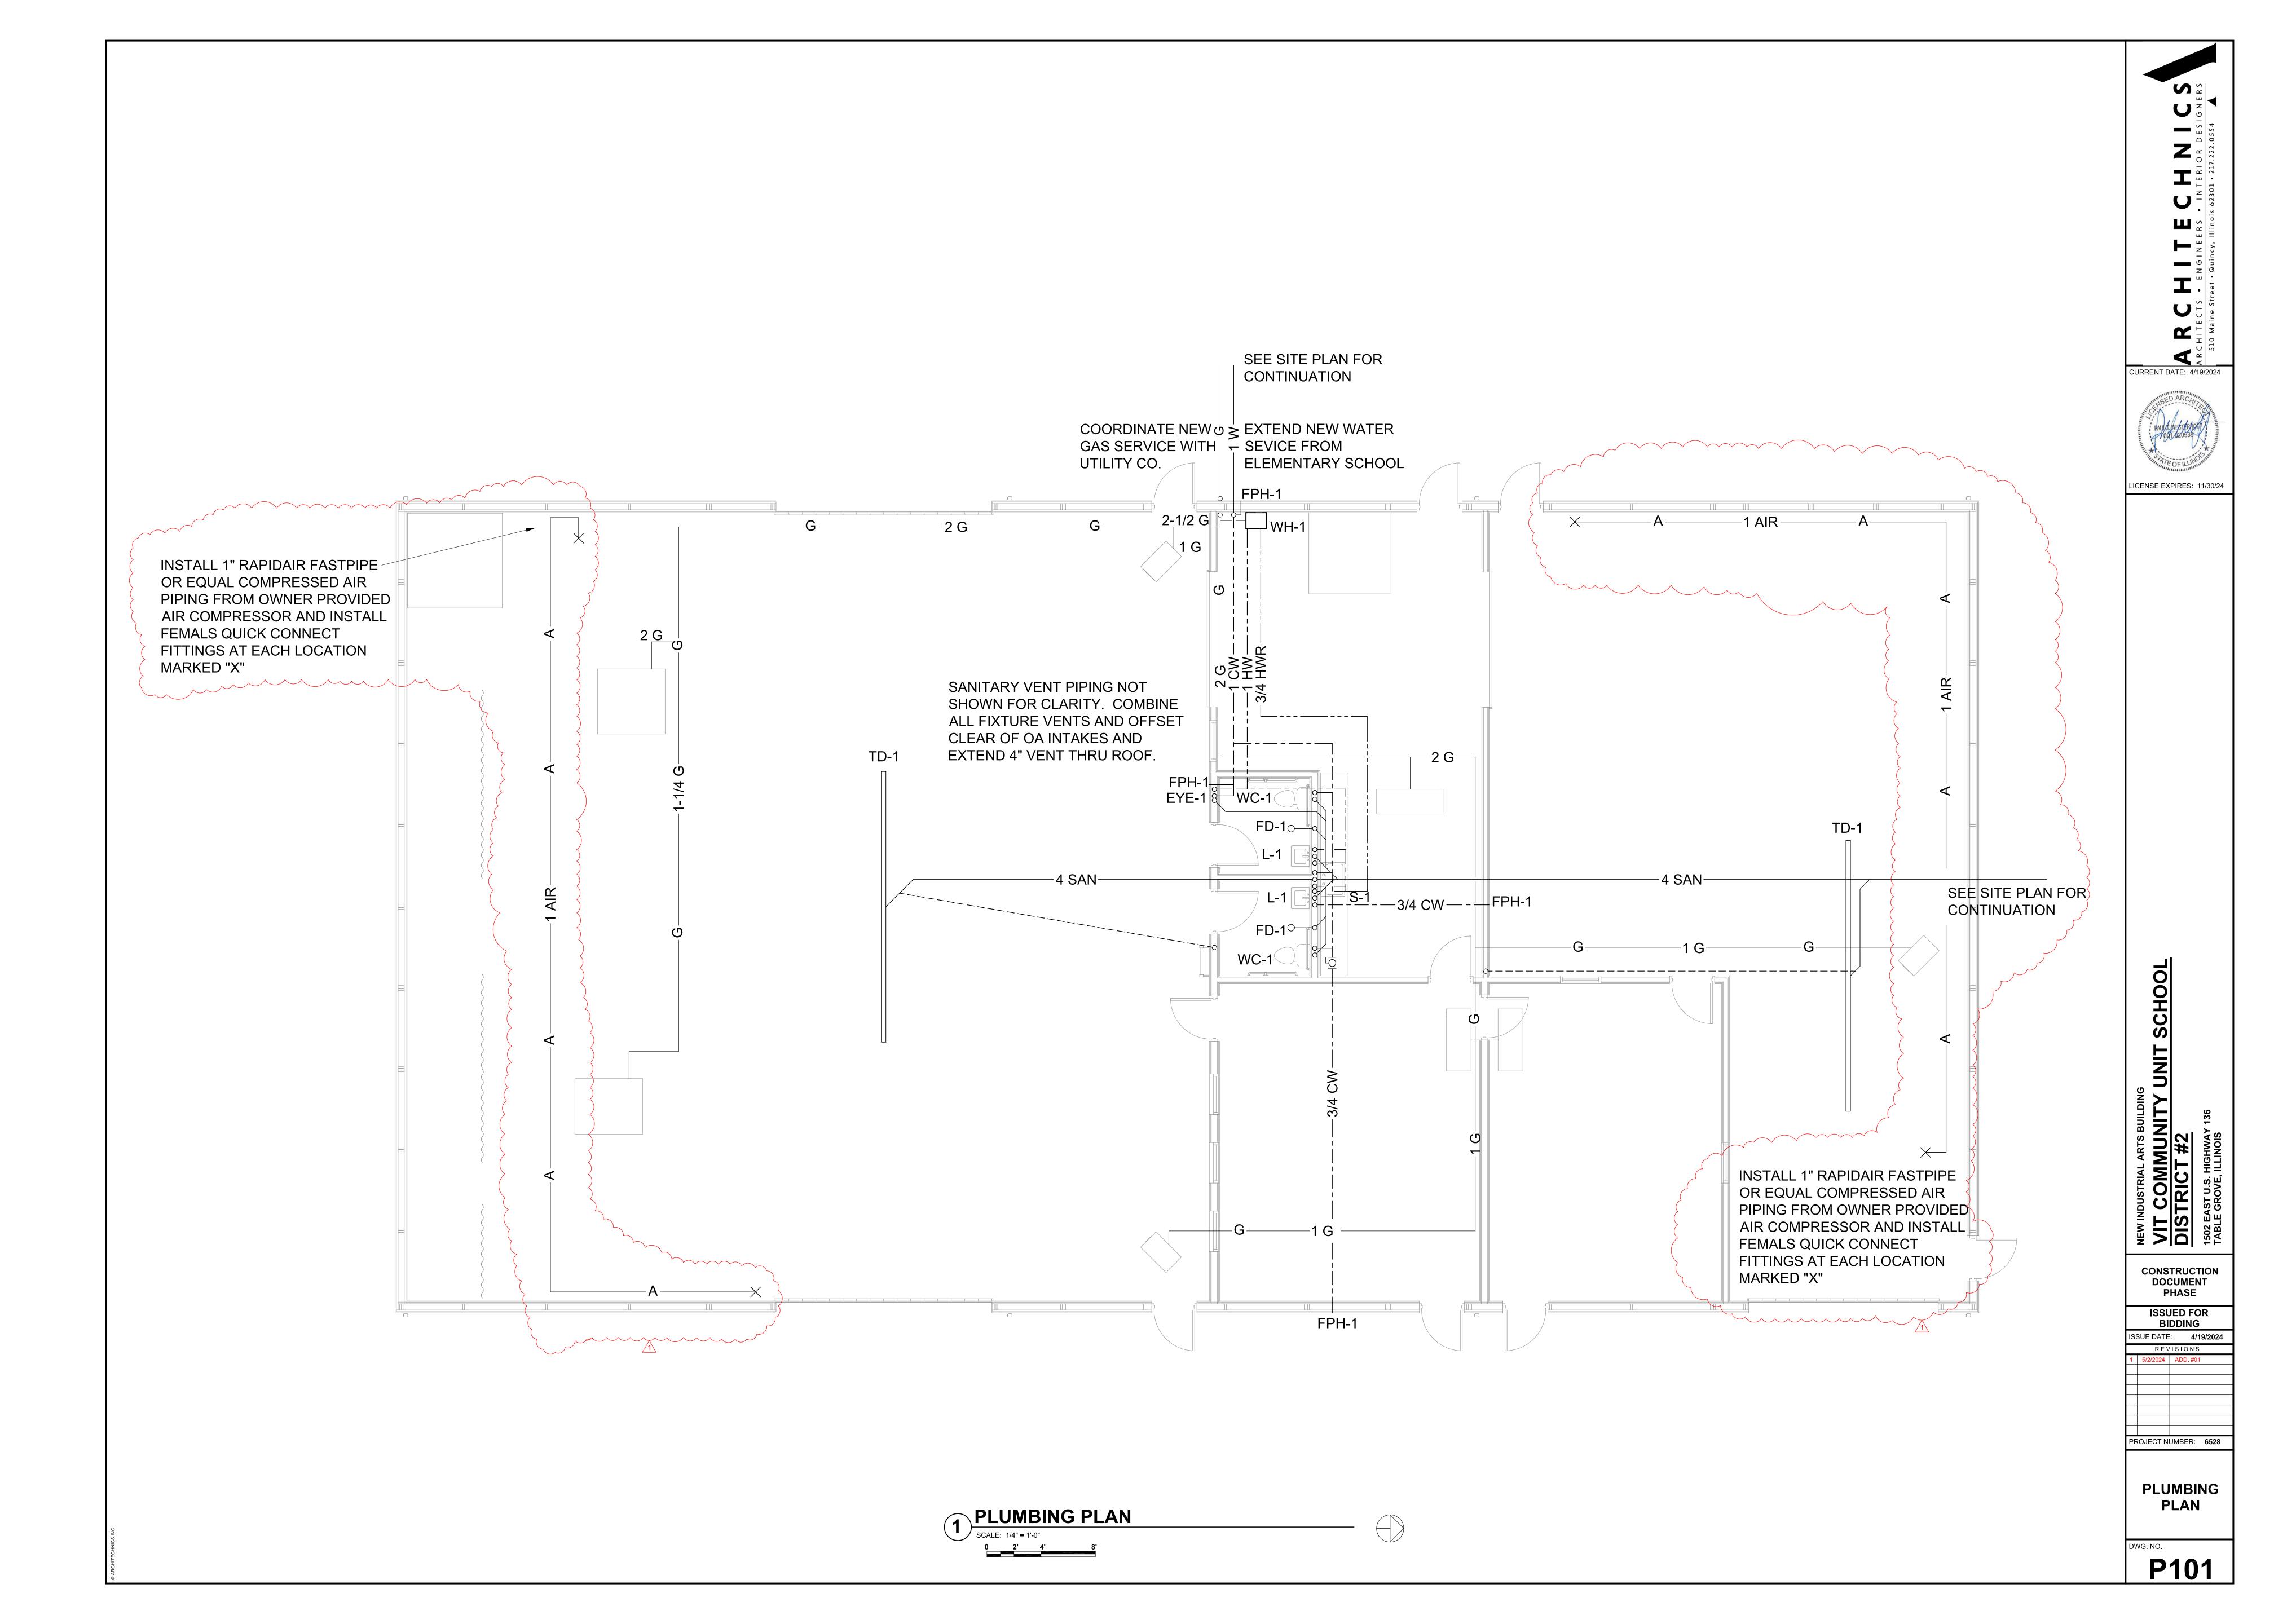



FOR QUESTIONS, CALL THE St. Louis Mechanical REGION 109 PHDNE: (636) 229 - 9777 EMAIL: reg109@captiveaire.com

HUU	U INF	<u>URMATIUN</u>		48576															
ноор	TAG	MODEL	 MANUFACTURER	LENGTH	MAX COOKING	TYPE	APPLIANCE		TOTAL			F	SISER(LENUM S>			НООО	END TO	CONFIG I
ND	140	MUDEL	PIRIO RETORER	LLINGTIT	TEMP	1111	DUTY	CFM/FT	EXH CFM	WIDTH	LENG	HEIGHT	DIA	CFM	VEL	SP	CONSTRUCTION	END	ROW
1		7224 ∨HB	CAPTIVEAIRE	6′ 0 ″	700 DEG	II	N/A	333	2000			4"	18"	2000	1132	-0.240*	430 SS 100%	ALONE	ALONE

HOOD INFORMATION UTILITY CABINET(S) FIRE HDDD ELECTRICAL TAG **WIRE** YSTEMHANGING TYPE QTY HEIGHT LENGTH € 7 MICR□NS TYPE LOCATION SIZE GUARI TYPE SIZE MODEL # QUANTITY PIPING WEIGHT 240 NΠ 1 0 LBS

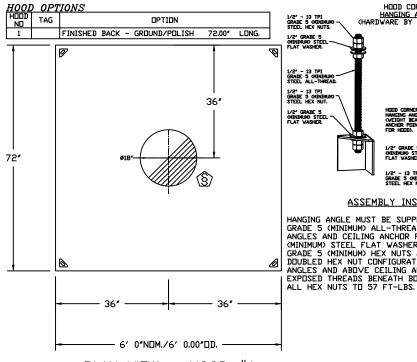

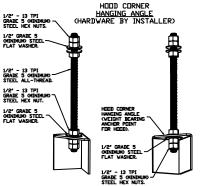

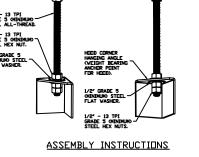

HANGING ANGLE MUST BE SUPPERTED WITH 1/2" - 13 TPI GRADE 5 (MINIMUM) ALL-THREAD, SANDWICH HANGING ANGLES AND CEILING ANCHOR POINTS WITH 1/2" GRADE 5 (MINIMUM) STEEL FLAT WASHERS AND 1/2" - 13 TPI GRADE 5 (MINIMUM) HEX NUTS AS SHOWN, MUST USE DOUBLED HEX NUT CONFIGURATION BENEATH HOOD HANGING DOUBLED HEX NUT CONFIGURATION ABOVE CEILING ANGLES AND ABOVE CEILING ANCHORS, MAINTAIN 1/4" OF EXPOSED THREADS BENEATH BOTTOM HEX NUT. TORQUE

FULL LENGTH HANGING ANGLE
(HARDWARE BY INSTALLER) 1/2" - 13 TPI GRADE 5 CHINIMUM STEEL HEX NUTS. 1/2' GRADE 5 (MINIMUM) STEEL FLAT WASHER. 1/2' - 13 TPI GRADE 5 (MINIMUM) STEEL HEX NUT. 1/2' GRADE 5 (MINIMUM) STEEL FLAT WASHER.

ASSEMBLY INSTRUCTIONS


HANGING ANGLE MUST BE SUPPORTED WITH 1/2' - 13 TPI GRADE 5 (MINIMUM) ALL-THREAD. SANDWICH HANGING ANGLES AND CEILING ANCHOR POINTS WITH 1/2' GRADE 5 (MINIMUM) STEEL FLAT WASHERS AND 1/2' - 13 TPI GRADE 5 (MINIMUM) HEX NUTS AS SHOWN, MUST USE ANCHORS, SINGLE HEX NUT BENEATH HANGING ANGLE IS ACCEPTABLE FOR FULL LENGTH HANGING ANGLES. MAINTAIN 1/4" OF EXPOSED THREADS BENEATH BOTTOM HEX NUT. TORQUE ALL HEX NUTS TO 57 FT-LBS.

PLAN VIEW - HOOD #1 0.00" LONG 7224VHB





JOB Plasma Table Hood									
LOCATION BRIDGETON, N	MD, 63044								
DATE 2/28/2024	<i>JOB #</i> 6648576								
DWG # 1	DRAWN BY WW-109								
REV.	SCALE 3/8" = 1'-0"								

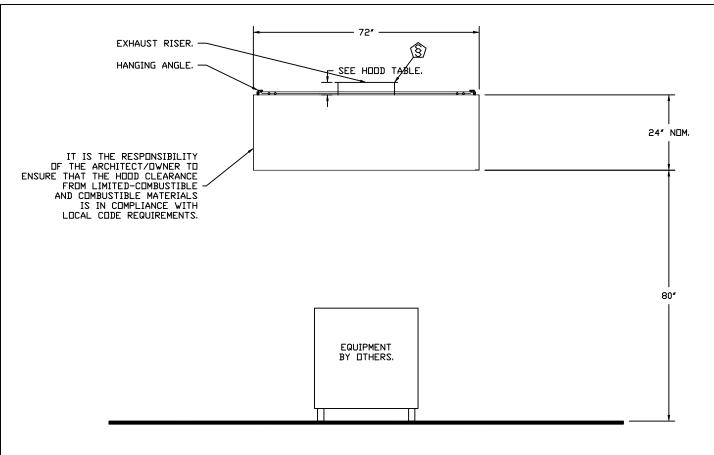

 $\frac{SECTION\ VIEW\ -\ MODEL\ 7224VHB}{HOOD\ -\ \#1}$





<i>JOB</i> Plasma Table Hood	JOB Plasma Table Hood							
LOCATION BRIDGETON, MD, 63044								
<i>DATE</i> 2/28/2024	<i>JOB #</i> 6648576							
<i>DWG #</i> 2	DRAWN BY WW-109							
REV.	SCALE 3/8" = 1'-0"							

EXHAUST FAN INFORMATION - JOB#6648576																	
	FAN UNIT ND	TAG	QTY	FAN UNIT MODEL #	MANUFACTURER	CFM	ESP	RPM	MOTOR ENCL	HP	BHP	PHASE	VOLT	FLA	DISCHARGE VELOCITY	WEIGHT (LBS)	SONES
	1		1	DU85HFA	CAPTIVEAIRE	2000	0.500	1384	TEAD-ECM	0.750	0.4710	1	115	8.9	633 FPM	88	13.1

FAN	OPTIC	NS
FAN		

FAN UNIT NO	TAG	QTY	DESCRIPTION					
		1	SCR-15 BIRD SCREEN					
1 I 19-BDD DAMPER								
1		1	ECM WIRING PACKAGE - EXHAUST - MANUAL OR 0-10VDC REFERENCE SPEED CONTROL -MSC- (TELCO), CCW ROTATION					
		1	2 YEAR PARTS WARRANTY					

FAN ACCESSORIES

	FAN UNIT	TAC	EXHAUST			SUPPLY				
	ND ONI I	TAG	GREASE CUP	GRAVITY DAMPER		SIDE DISCHARGE		MOTORIZED DAMPER	WALL MOUNT	
1	1			YES						

CURB ASSEMBLIES


ND	ON FAN	WEIGHT	ITEM	SIZE
1	# 1	32 LBS	CURB	23.000°W X 23.000°L X 20.000°H.





JOB Plasma Table Hood							
LOCATION BRIDGETON, MO, 63044							
DATE 2/28/2024	<i>JOB #</i> 6648576						
<i>DWG #</i> 3	DRAWN BY WW-109						
REV.	SCALE 3/8" = 1'-0"						

FAN #1 DU85HFA - EXHAUST FAN

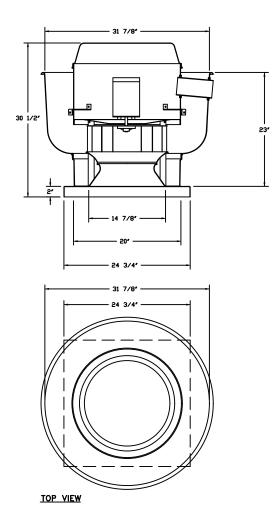


FEATURES:

- DIRECT DRIVE CONSTRUCTION (NO BELTS/PULLEYS).
- ROOF MOUNTED FANS.
- UL705.
- VARIABLE SPEED CONTROL.
- INTERNAL WIRING.
- THERMAL OVERLOAD PROTECTION (SINGLE PHASE).
- NEMA 3R SAFETY DISCONNECT SWITCH.


<u>OPTIONS</u>

- SCR-15 BIRD SCREEN. I 19-BDD DAMPER.
- ECM WIRING PACKAGE -EXHAUST - MANUAL DR 0-10VDC REFERENCE SPEED CONTROL
- -MSC- (TELCO), CCW ROTATION.
 2 YEAR PARTS WARRANTY.



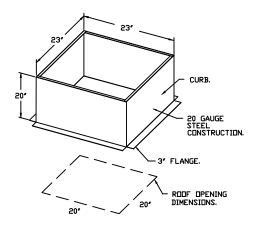

BACKDRAFT DAMPER INSTALLATION

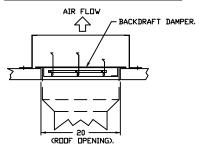





JOB Plasma Table Hood							
LOCATION BRIDGETON, N	1 □, 63044						
<i>DATE</i> 2/28/2024	<i>JOB #</i> 6648576						
DWG # 4	DRAWN BY WW-109						
REV.	SCALE 3/8" = 1'-0"						

© GREASE DUCT & CHIMNEY SPECIFICATIONS:

PROVIDE GREASE DUCT EQUAL TO CAPTIVEAIRE SYSTEMS MODEL "DW" ROUND 20 GAUGE 430 STAINLESS STEEL DUCTWORK. MODEL "DW" IS LISTED TO UL-1978 AND IS INSTALLED USING "V" CLAMP LOCKING CONNECTIONS SEALED WITH 3M FIRE BARRIER 2000 PLUS. MODEL "DW" DOES NOT REQUIRE WELDING PROVIDING IT HAS BEEN INSTALLED PER THE MANUFACTURES INSTALLATION GUIDE.

PROVIDE RATED ACCESS DOORS AT EVERY CHANGE IN DIRECTION AND EVERY 12' ON CENTER. PER MANUFACTURES LISTING MODEL "DW" HORIZONTAL RUNS LESS THAN 75 FT. CAN BE SLOPED 1/16" PER 12", HORIZONTAL RUNS MORE THAN 75 FT. CAN BE SLOPED 3/16" PER 12". DUCT SHOULD BE SLOPED AS MUCH AS POSSIBLE TO REDUCE THE CHANCE OF GREASE ACCUMULATION IN HORIZONTAL RUNS.


IF THE DUCT OR CHIMNEY IS WITHIN 18 INCHES OF COMBUSTIBLE MATERIAL, PROVIDE UL-2221 OR UL-103 HT LISTED DOUBLE WALL GREASE DUCT OR DOUBLE WALL CHIMNEY EQUAL TO CAPTIVEAIRE SYSTEMS MODEL "DW- 2R, 2R TYPE HT, 3R, OR 3Z" ROUND 20 GAUGE 430 STAINLESS INNER DUCT INSULATED WITH A 24 GAUGE 430 STAINLESS OUTER SHELL.


CUSTOMER APPROVAL TO MANUFACTURE: APPROVED AS NOTED APPROVED AS NOTED APPROVED WITH NO EXCEPTION TAKEN REVISE AND RESUBBIT SIGNATURE YOUR TITLE DATE THE INNER DUCT IS FULLY VELDED TO THE TRANSITION PLATE. THE INNER DUCT IS FULLY VELDED TO THE TRANSITION PLATE. VENTED CURB RIDGE TERMINATION. *NOTE: UL 762 INSTALL.





JOB Plasma Table Hood							
MD, 63044							
<i>JOB #</i> 6648576							
DRAWN BY WW-109							
SCALE 3/8" = 1'-0"							

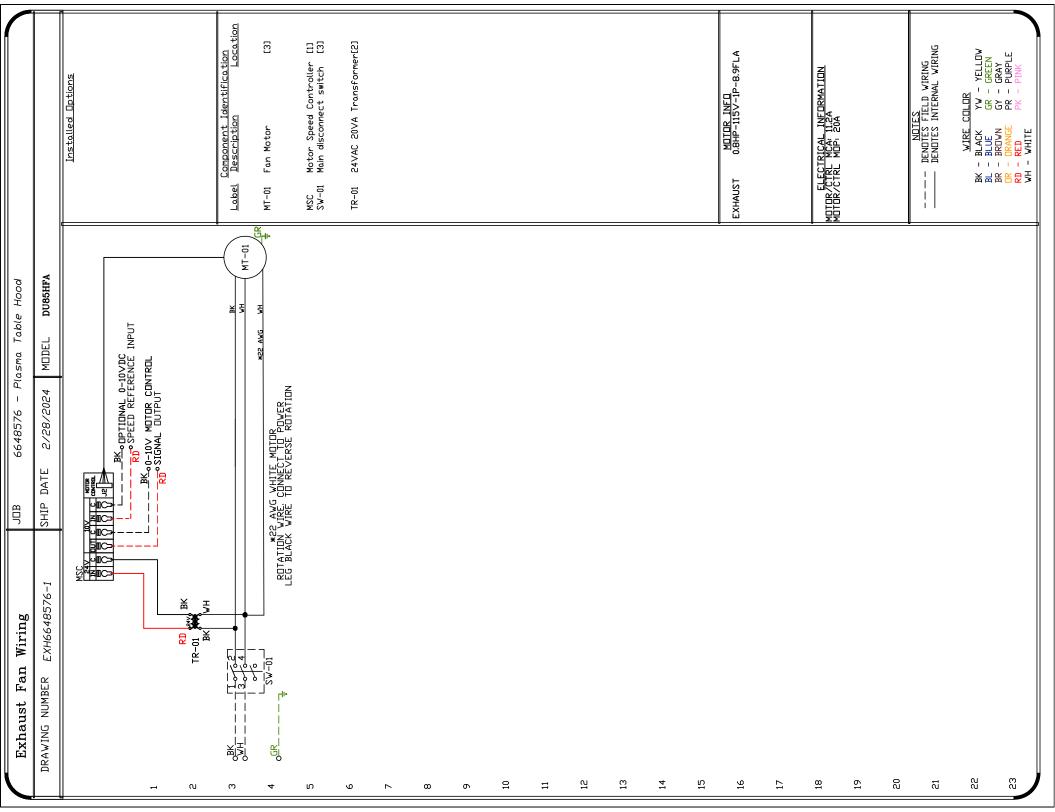

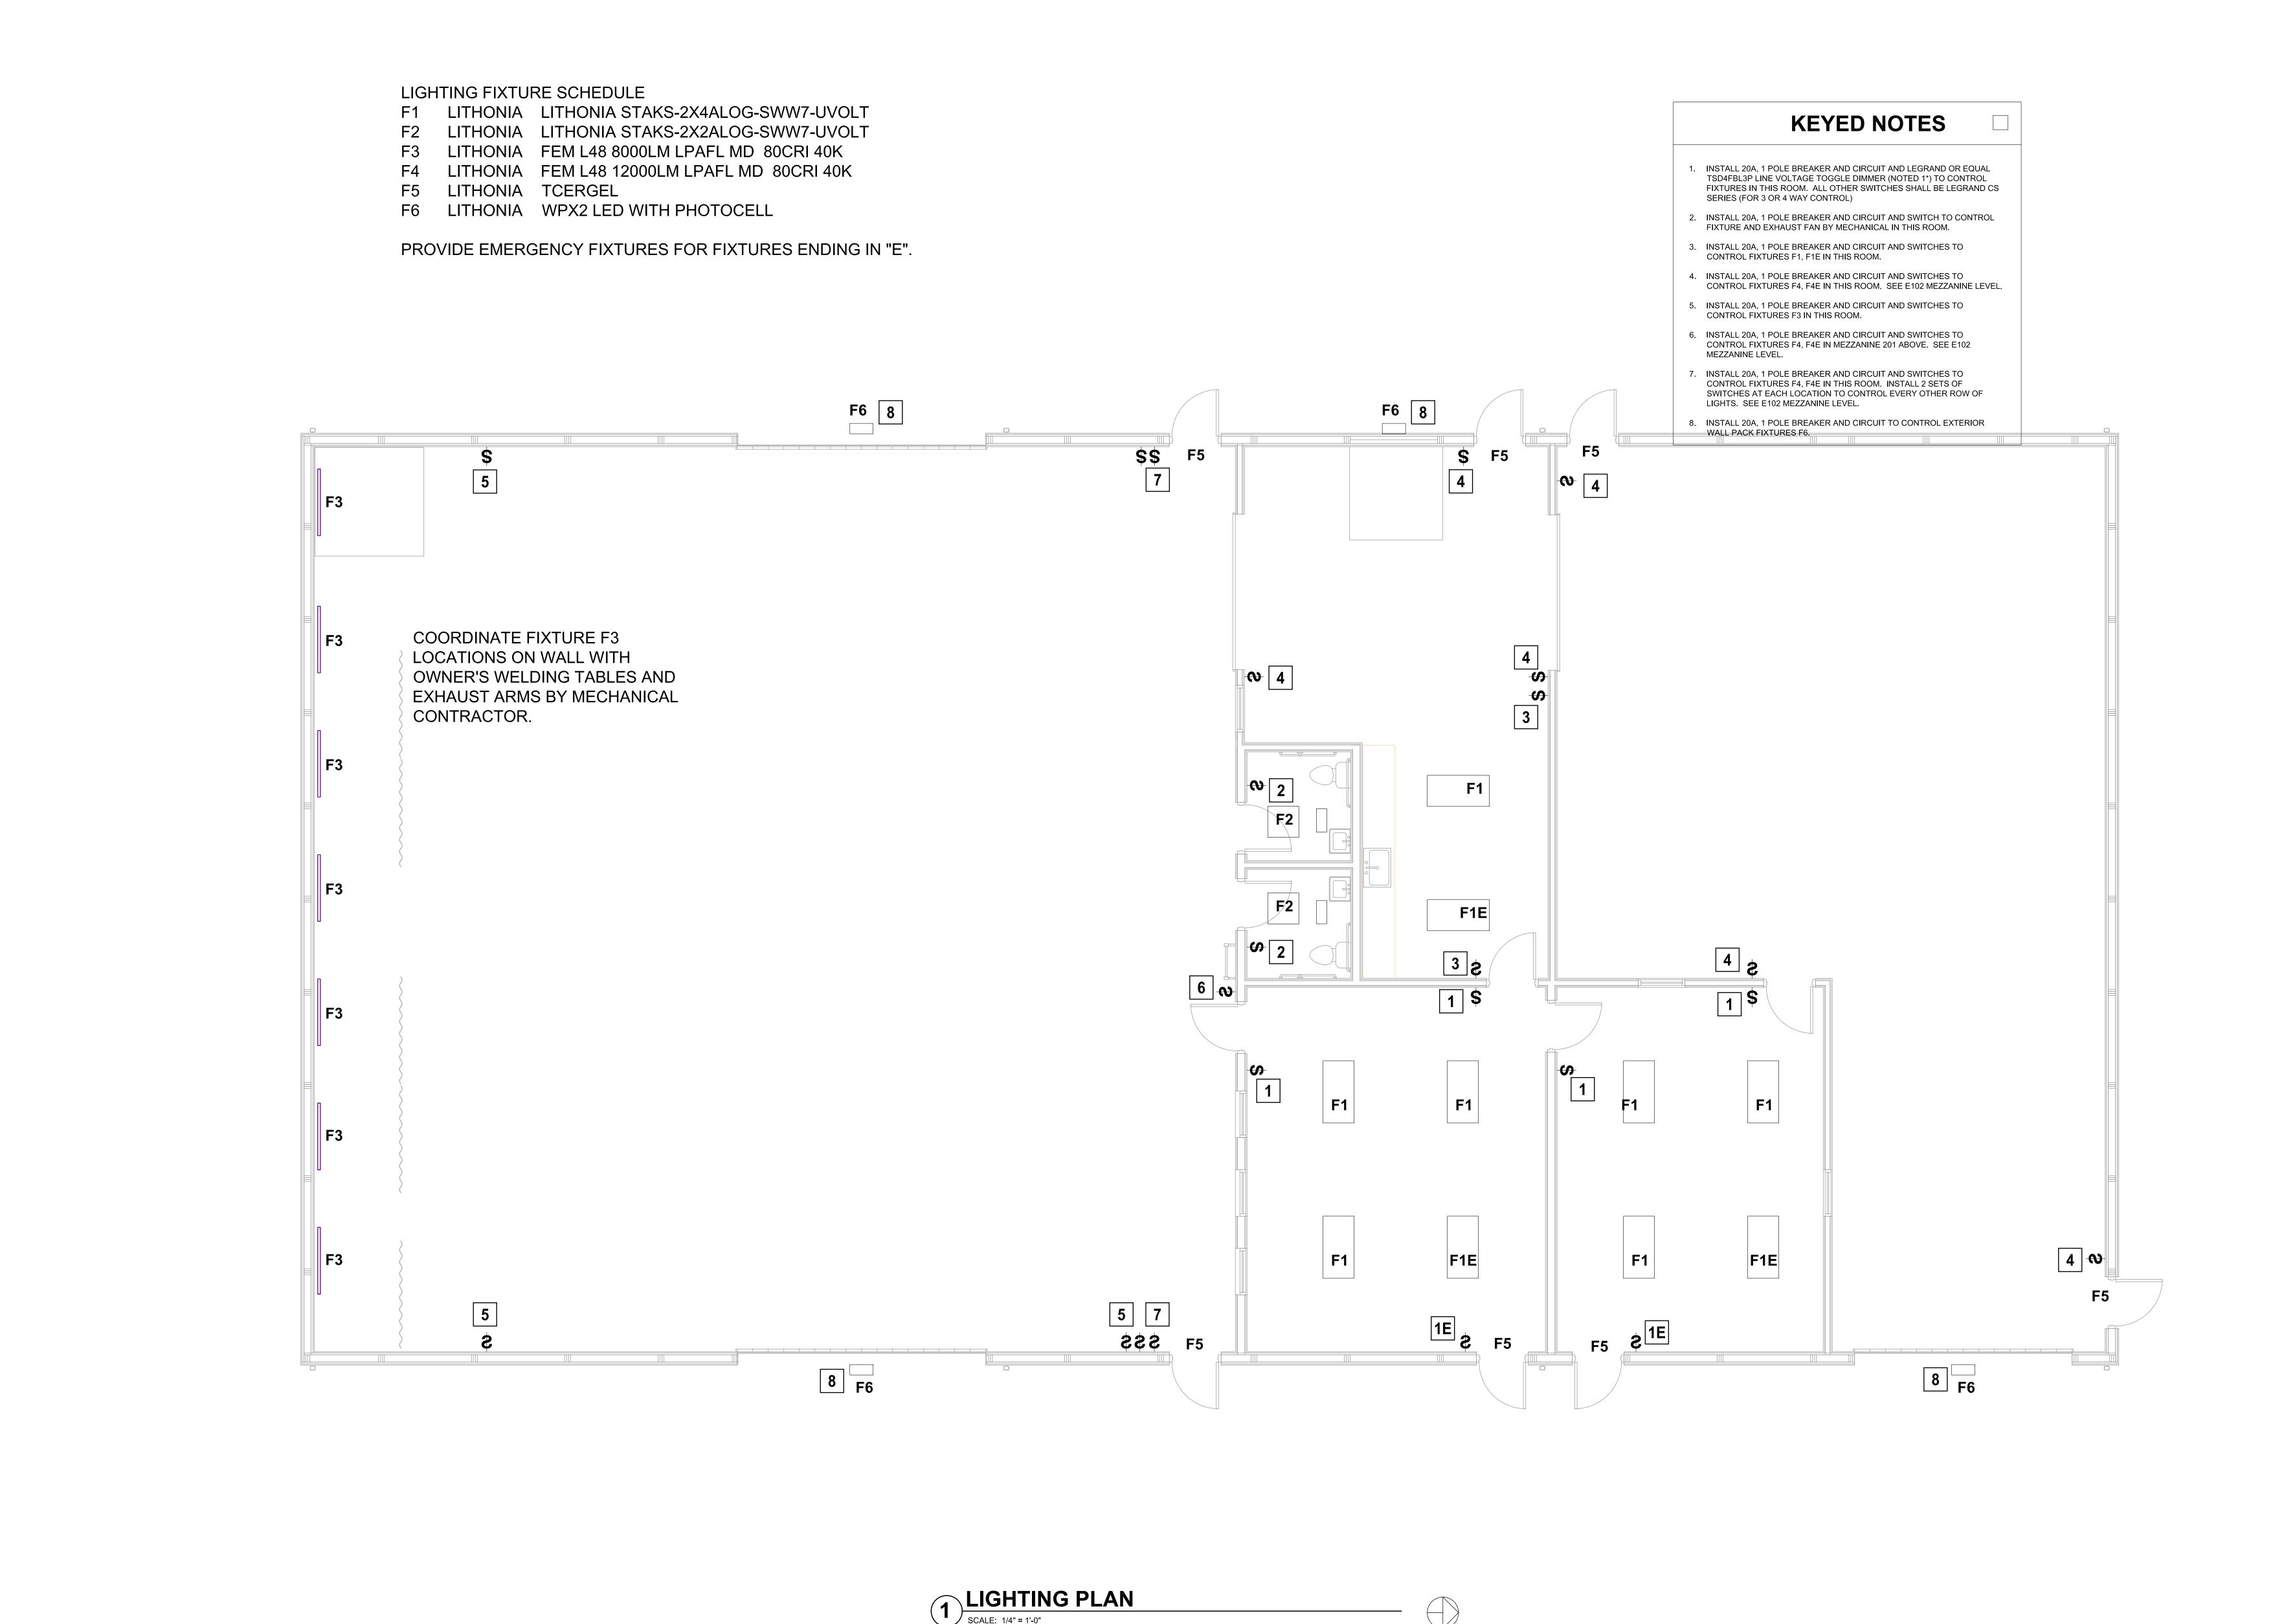

CURRENT DATE: 4/19/2024 LICENSE EXPIRES: 11/30/24

CONSTRUCTION DOCUMENT PHASE


ISSUED FOR BIDDING

ISSUE DATE: 4/19/2024

PROJECT NUMBER: 6528

LIGHTING **PLAN**

E101

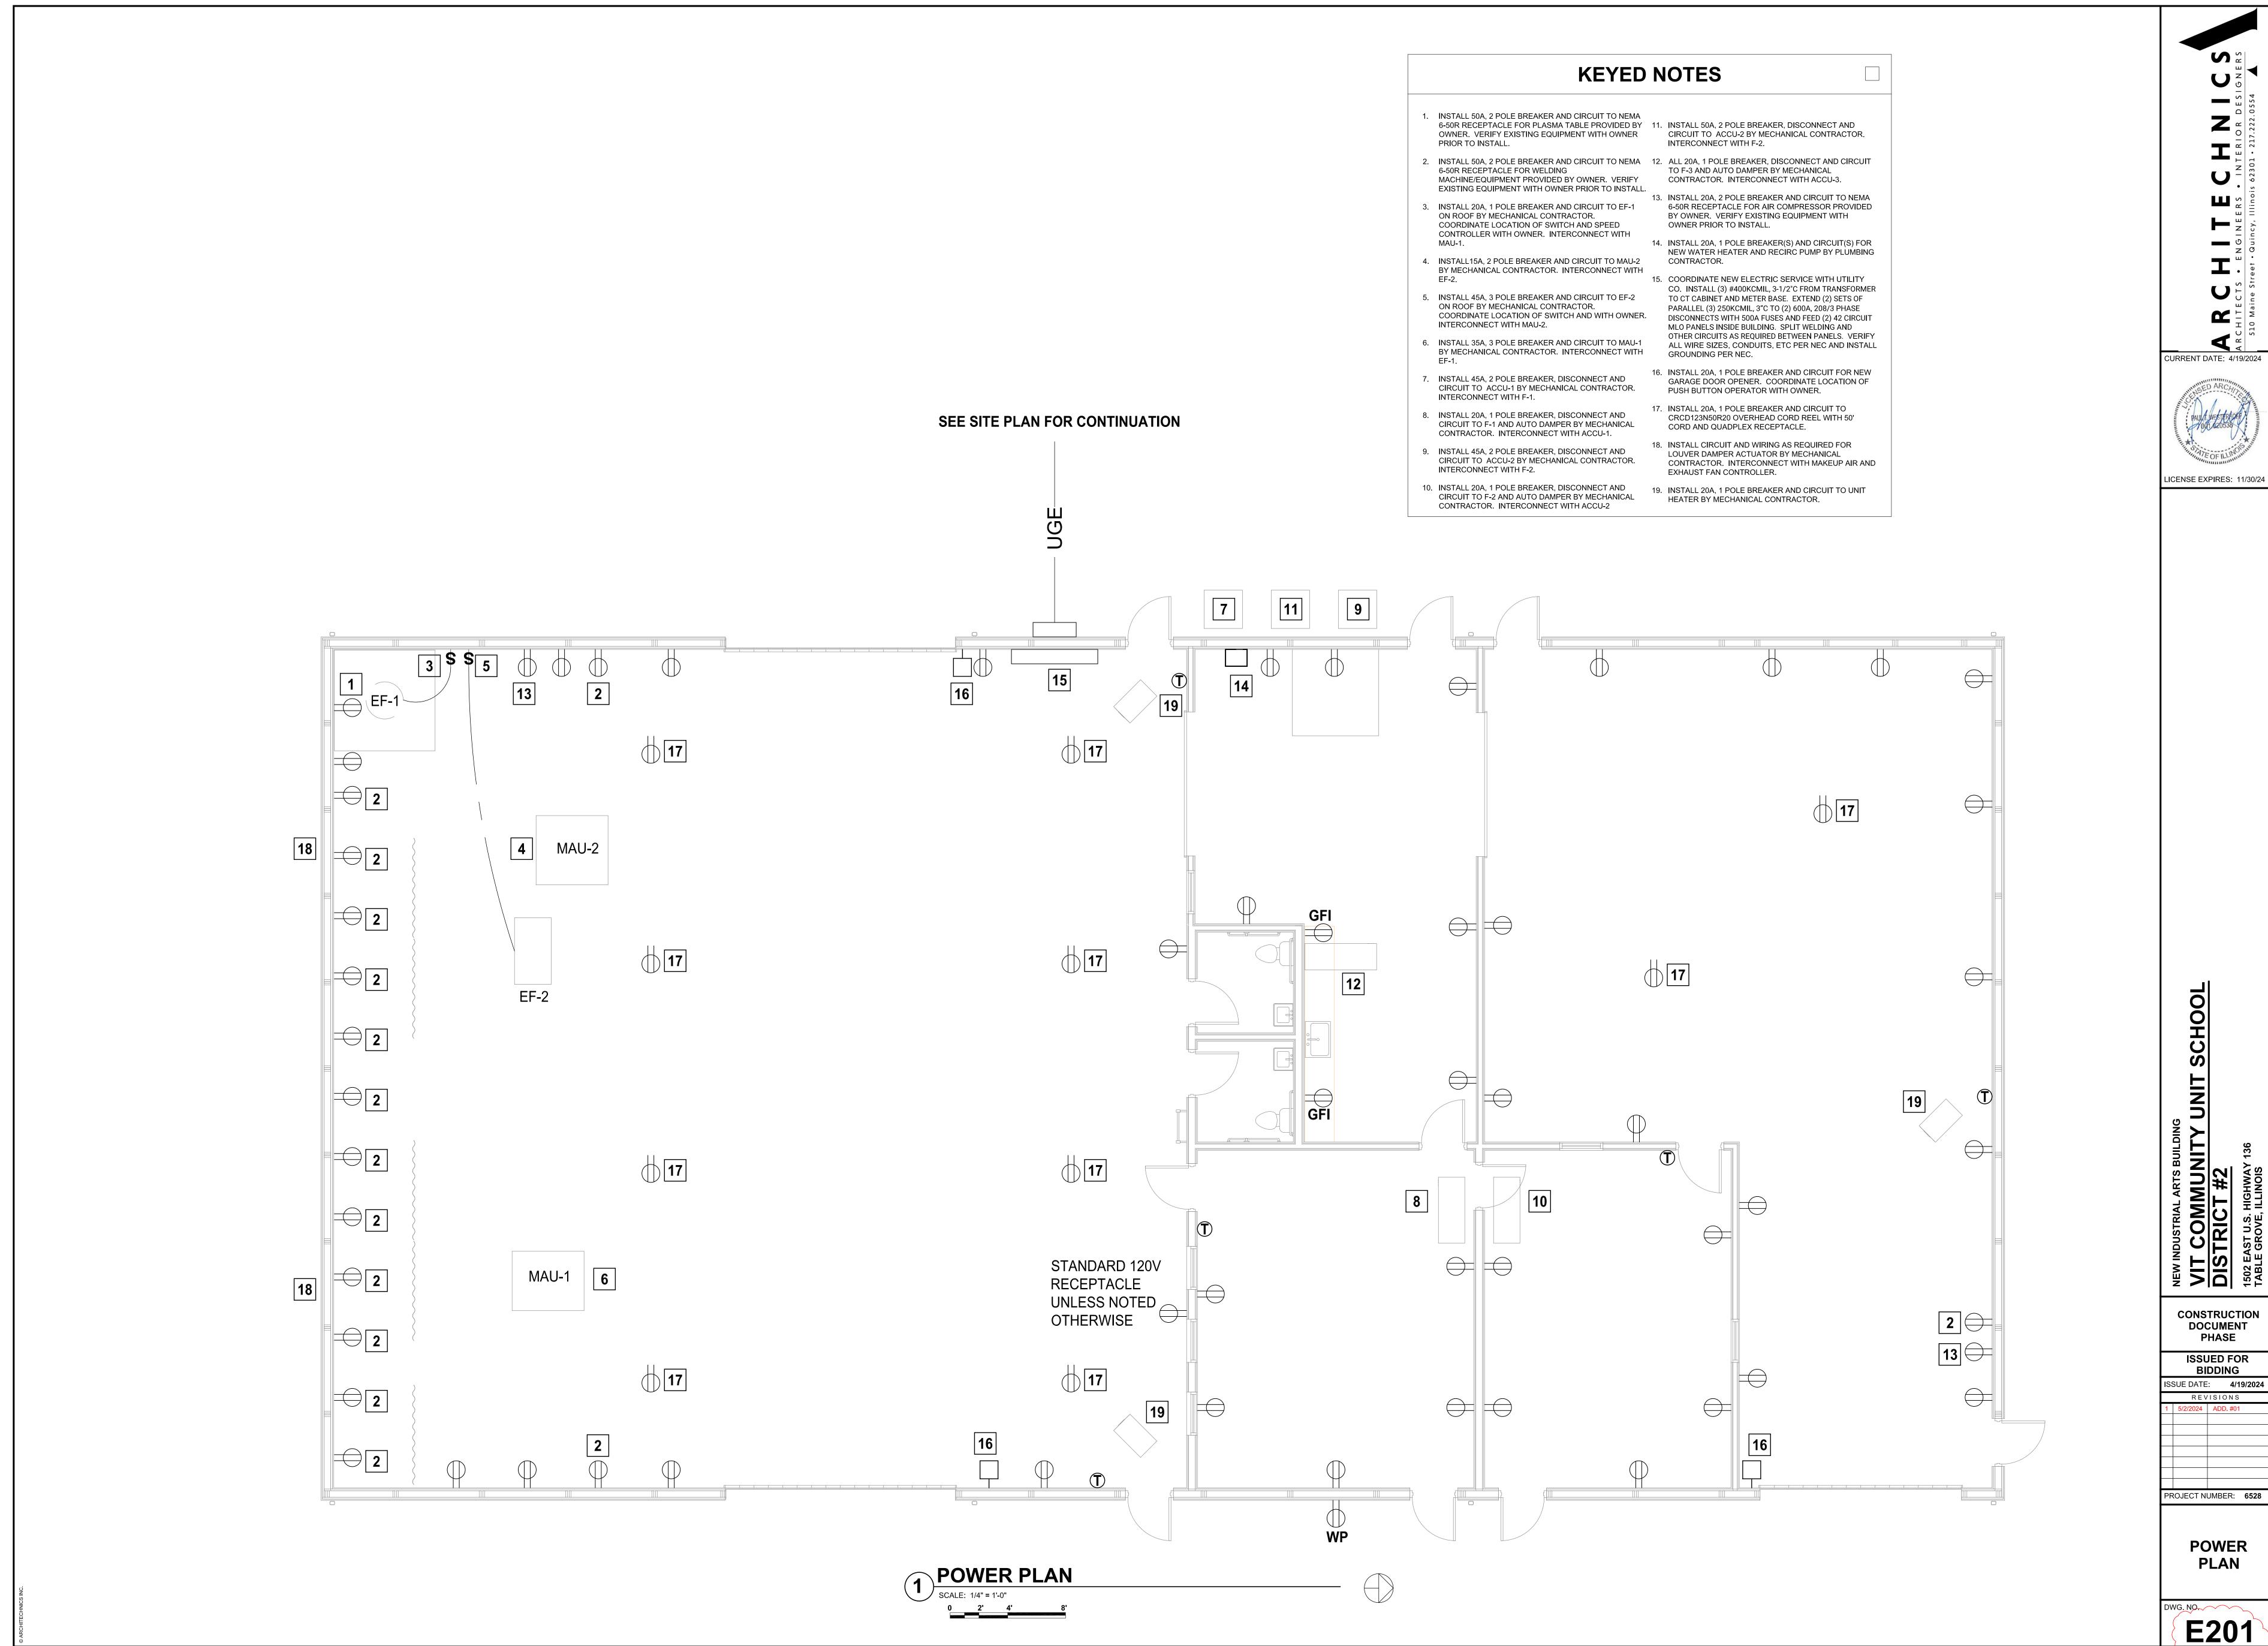

ISSUED FOR BIDDING