
EXTERIOR IMPROVEMENTS AT: 29TH & BROADWAY (IL 16-3)

QUINCY HOUSING AUTHORITY

540 HARRISON STREET QUINCY, ADAMS COUNTY, ILLINOIS JERRY GILLE EXECUTIVE DIRECTOR

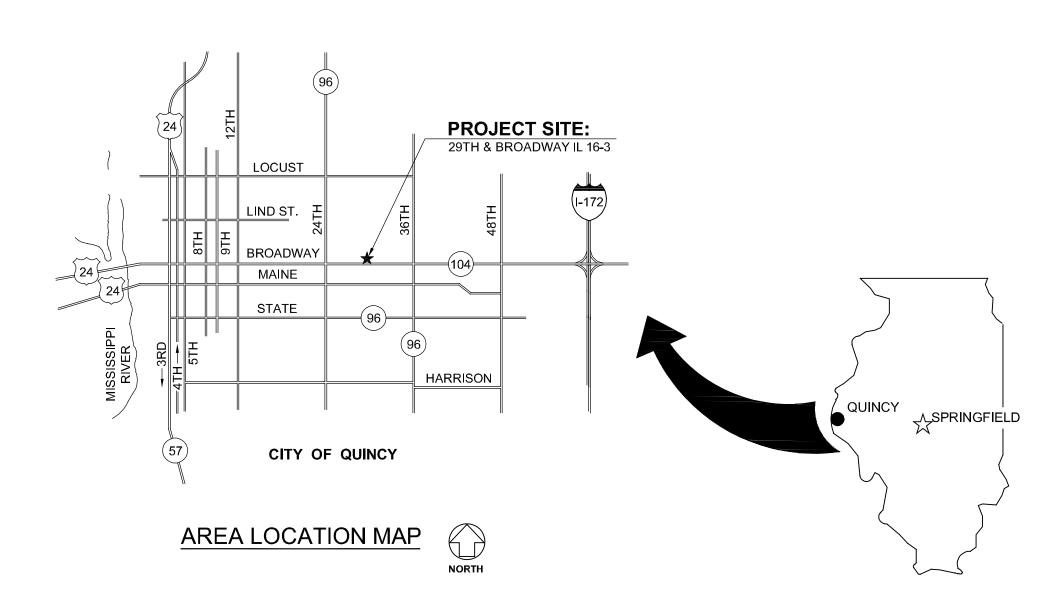

ILLINOIS

GENERAL NOTES

- 1. CONTRACTOR TO VERIFY ALL DIMENSIONS.
- 2. ANY DISCREPANCIES BETWEEN STATED AND EXISTING CONDITIONS SHALL BE REPORTED IMMEDIATELY TO THE ARCHITECT.
- 3. DISCREPANCIES OR CONFLICTS BETWEEN SPECIFICATIONS AND DRAWINGS SHALL BE MADE KNOWN TO THE ARCHITECT FOR CLARIFICATION.
- 4. THE CONTRACTOR SHALL BE RESPONSIBLE FOR PROTECTING THOSE AREAS TO REMAIN UNDISTURBED DURING CONSTRUCTION
- 5. THE CONTRACTOR SHALL TAKE NECESSARY PRECAUTIONS, AS PER THE WRITTEN SPECIFICATIONS, TO MAINTAIN SAFETY AT THE CONSTRUCTION SITE, AND HE IS SOLELY RESPONSIBLE FOR SAFETY MEASURES. THE CONTRACTOR IS ALSO SOLELY RESPONSIBLE FOR CONSTRUCTION MEANS, METHODS, AND TECHNIQUES REGARDING EXECUTION OF THE WORK
- THE CONTRACTOR SHALL CONFORM TO ALL LOCAL AND STATE CODES AND RECEIVE LOCAL AND STATE APPROVAL WHERE NECESSARY PRIOR TO CONSTRUCTION.
- 7. THE CONTRACTOR SHALL GIVE ALL NECESSARY NOTICES AND OBTAIN ALL PERMITS AND PAY ALL LEGAL FEES. HE SHALL ALSO COMPLY WITH ALL CITY, COUNTY, AND STATE BUILDING LAWS, ORDINANCES, OR REGULATIONS.
- 8. THE CONTRACTOR SHALL BE RESPONSIBLE FOR THE DAMAGE OR LOSS OF ANY REFERENCE POINTS, MONUMENTS, HUBS AND STAKED LOT CORNERS DURING THE CONSTRUCTION OF HIS WORK, AND SHALL BEAR THE COST OF REPLACING SAME.
- 9. THE CONTRACTOR SHALL BE RESPONSIBLE FOR ANY DAMAGE DONE TO THE PREMISES OR ADJACENT PREMISES, OR INJURIES TO THE PUBLIC DURING THE CONSTRUCTION OF THE WORK, CAUSED BY HIMSELF, HIS SUBCONTRACTOR, OR THE CARELESSNESS OF ANY OF HIS EMPLOYEES.
- 10. THE CONTRACTOR MUST UNDERSTAND THAT THE WORK IS ENTIRELY AT HIS RISK UNTIL SAME IS ACCEPTED, AND HE WILL BE HELD RESPONSIBLE FOR ITS SAFETY.
- 11. THE CONTRACTOR SHALL FURNISH AND INSTALL ALL NECESSARY TEMPORARY WORKS FOR THE PROTECTION OF THE WORK, INCLUDING BARRICADES, WARNING SIGNS, LIGHTS, ETC.
- 12. SITE LAYOUT IS TO BE AS PER ARCHITECTURAL DRAWINGS AND SPECIFICATIONS PREPARED BY ARCHITECT.
- 13. THE CONTRACTOR SHALL PROVIDE THE ARCHITECT WITH ONE SET OF PRINTS MARKED WITH ANY CHANGES FROM ORIGINAL CONTRACT DOCUMENTS.
- 14. ALL EXISTING CIRCUIT CONDUCTORS AND RACEWAYS IN BUILDING UNITS TO REMAIN UNLESS NOTED OTHERWISE.

A.D.A. COMPLIANCE

THIS PROJECT SHALL BE IN COMPLIANCE WITH GUIDELINES OF THE AMERICANS WITH DISABILITIES ACT (A.D.A.)

AMERICANS WITH DISABILITIES ACT (A.D.A.)

ARCHITECHNICS, TO THE BEST OF ITS ABILITY, HAS EXERCISED PROFESSIONAL EFFORTS TO INTERPRET THE INTENT OF THE "AMERICANS WITH DISABILITIES ACT", AND OTHER APPLICABLE FEDERAL, STATE AND LOCAL CODES AND REQUIREMENTS. ARCHITECHNICS CANNOT GUARANTEE TOTAL COMPLIANCE WITH ANY WORK DIRECTLY RELATED TO THE A.D.A., WHEN THE OWNER PERFORMS AND/OR AUTHORIZES WORK USING THESE DOCUMENTS AND/OR DRAWINGS.

INDEX OF DRAWINGS

G001 COVER SHEET
C101 OVERALL SITE PLAN
DC101 SITE DEMOLITION PLAN

C102 ENLARGED SITE PLAN
C103 SITE UTILITIES PLAN

C501 SITE DETAILS

PRE-BID MEETING: 10:00 AM FRIDAY, AUGUST 13, 2021
BIDS DUE: 2:00 PM THURSDAY, AUGUST 19, 2021

ABBREVIATIONS

ABV	ABOVE	DWG	DRAWING	M.A.U.	MAKEUP AIR UNIT	SECT.	SECTION
A.F.F.	ABOVE FINISHED FLOOR	D.F.	DRINKING FOUNTAIN	M.H.	MANHOLE	SHT.	SHEET
ADD'N.	ADDITION	EA.	EACH	MFGR.	MANUFACTURER	SIM.	SIMILAR
		E.W.		M.T.	MARBLE TILE	S.C.	SOLID CORE
A.C.	AIR CONDITIONING		EACH WAY			SPEC.	SPECIFICATION
A.H.U.	AIR HANDLING UNIT	E.M.R.	ELASTOMERIC MEMBRANE	MK.	MARK		
ALT	ALTERNATE		ROOFING	M.O.	MASONRY OPENING	S.& V.	STAIN AND VARNISH
ALUM	ALUMINUM	ELEC.	ELECTRIC	MATL.	MATERIAL	S.S.	STAINLESS STEEL
A.D.A.	AMERICANS WITH	E.P.	ELECTRIC PANELBOARD	MECH.	MECHANICAL	STD.	STANDARD
	DISABILITIES ACT	EL	ELEVATION	MET.	METAL	STL.	STEEL
ANCS.	ANCHORS	ELEV.	ELEVATOR	MIN.	MINIMUM	STOR.	STORAGE
		EXH.	EXHAUST	MISC.	MISCELLANEOUS	ST. S.	STORM SEWER
AUTO.	AUTOMATIC	E.F.	EXHAUST FAN	M.R.	MOISTURE RESISTANT	S.G.T.	STRUCTURAL GLAZED
BM.	BEAM	EXIST	EXISTING	MTD.	MOUNTED		TILE
BR'G.	BEARING				NAPKIN DISPENSER	S.A.P.	SUSPENDED ACOUSTICAL
BITUM.	BITUMINOUS	E. J.	EXPANSION JOINT	N.D.		J.A.I .	PANELS
BLK'G.	BLOCKING	EXT	EXTERIOR	N.I.C.	NOT IN CONTRACT	TD	
BLDG	BUILDING	E.I.F.S.	EXTERIOR INSULATION	NOM.	NOMINAL	T.B.	TACK BOARD
BD.	BOARD		FINISH SYSTEM	NO.	NUMBER	T. & S.	TAPE AND SAND
BTM.	воттом	F.W.C.	FABRIC WALL COVERING	OFC.	OFFICE	T.D.D.	TELECOMMUNICATIONS
B.P.	BRICK PAVERS	F.V.	FIELD VERIFY	O.C.	ON CENTER		DEVICE FOR DEAF
BLDG.	BUILDING	FIN.	FINISH	OPG.	OPENING	T.G.	TEMPERED GLASS
	BUILT-UP ROOF	F.E.C.	FIRE EXTINGUISHER	OPP. HND.	OPPOSITE HAND	T.R.G.	TEMPERED REFLECTIVE
BUR			CABINET	OH.	OVERHEAD		GLASS
CA.	CARPET	FIX.	FIXTURE	PT.	PAINT	TZ.	TERRAZZO
C.I.	CAST IRON	FL.	FLOOR	PR.	PAIR	T.T.	TERRAZZO TILE
CAT	CATALOG	F.D.	FLOOR DRAIN			THK.	THICK/THICKNESS
CLG.	CEILING			PARTN.	PARTITION		
C.T.	CERAMIC TILE	FLOUR.	FLUORESCENT	PERF.	PERFORATED	T'HOLD	THRESHOLD
C.W.B.	CERAMIC WALL BASE	FTG.	FOOTING	P.D.	PRESSURE DROP	T.P.	TOILET PAPER
C.B.	CHALK BOARD	FND.	FOUNDATION	PLAS.	PLASTIC	T. & G.	TONGUE AND GROOVE
CLOS.	CLOSET	G.P.M.	GALLONS PER MINUTE	P.S.	PLUMBING STACK	T. & B.	TOP AND BOTTOM
C.O.	CLEAN OUT	GALV	GALVANIZED	P.V.	PLUMBING VENT	TRANS.	TRANSITION
CO.	COMPANY	GA.	GAUGE	PLYWD.	PLYWOOD	T.	TREADS
COMP.	COMPOSITION	G.W.T.	GLAZED WALL TILE	P.V.C.	POLYVINYL CHLORIDE	TYP.	TYPICAL
		G.B.	GRAB BAR	P.S.F.	POUNDS PER SQUARE	U.L.	UNDERWRITERS
CONC	CONCRETE	G.F.B.	GROUND FACE BRICK	1 .0.1 .	FOOT		LABORATORIES
C.M.U.	CONCRETE MASONRY	GYP. BD.	GYPSUM WALLBOARD	PREFIN.	PREFINISHED	U.N.O.	UNLESS NOTED
	UNIT	H.D.	HAIR/HAND DRYER			O.N.O.	OTHERWISE
COND	CONDENSATION		1		. PROJECT MANUAL	U.P.	UTILITY POLE
CONN.	CONNECTION	HC	HANDICAPPED	QTY.	QUANTITY		
CONST.	CONSTRUCTION	HR.	HANDRAIL	Q.T.	QUARRY TILE	V.P.	VAPOR BARRIER
C.J.	CONSTRUCTION JOINT	HDWE.	HARDWARE	RAD.	RADIUS	VERT.	VERTICAL
CONT	CONTINUOUS	H.V.A.C.	HEATING, VENTILATING,	RECEP.	RECEPTACLE	VEST.	VESTIBULE
CONTR.	CONTRACTOR		& AIR CONDITIONING	REF.	REFERENCE	V.C.T.	VINYL COMPOSITION
COR'D	CORRUGATED	HT.	HEIGHT	R.A.	RETURN AIR		TILE
CORR.	CORRIDOR	H.C.	HOLLOW CORE	R.H.	RIGHT HAND	V.W.C.	VINYL WALL
CNTR.	COUNTER	H.M.	HOLLOW METAL	R.	RISERS		COVERING
C.R.	CRUSHED ROCK	HORIZ.	HORIZONTAL	R.D.	ROOF DRAIN	V.C.P.	VITRIFIED CLAY PIPE
C.F.M.	CUBIC FEET PER	INC.	INCORPORATED	R.B.	RUBBER BASE	W.C.	WATER CLOSET
C.F.IVI.	MINUTE	INSUL.	INSULATION	R.C.B.	RUBBER COVE BASE	W.W.F.	WELDED WIRE FABRIC
DEMO		INSUL.G.	INSULATED GLASS	REQD.	REQUIRED	W.	WIDTH
DEMO	DEMOLITION	JAN.	JANITOR			WDW.	WINDOW
DET	DETAIL	JT.	JOINT	R.O.W.	RIGHT OF WAY		
DIA	DIAMETER			RM.	ROOM	W.G.	WIRE GLASS
DIM.	DIMENSION	J.F.	JOINT FILLER	R.I.	ROUGH IN	W/	WITH
DISP.	DISPENSER	JST.	JOIST	R.O.	ROUGH OPENING	W/O	WITH OUT
DIV.	DIVISION	J.B.	JUNCTION BOX	R.S.T.	RUBBER STAIR TREAD	WD.	WOOD
DR.	DOOR	LAM.	LAMINATE	R.T.	RUBBER TILE	T.	TREADS
DBL.	DOUBLE	LAV.	LAVATORY	SAN.	SANITARY (SEWER)	TYP.	TYPICAL
D.S.	DOWNSPOUT	L.H.	LEFT HAND	SCHED.	SCHEDULE	U.L.	UNDERWRITERS
2.0.	23771137 337	LG.	LONG				

ARCHITECTS • engineers • interior designers

510 Naire Street, Quincy, IL 62301 • 217-222-0554 • info@architechnicsinc.com

CURRENT DATE: 8/6/2021



LICENSE EXPIRES: 11/30/22

ADWAY (IL 16-3)

MADWAY (IL 16-3)

MADWAY (IL 16-3)

HOUSING AUTHO
STREET, QUINCY, ILLINOIS 62301


CONSTRUCTION DOCUMENT

ISSUED FOR BIDDING
ISSUE DATE: 8/6/2021
REVISIONS

COVER SHEET

PROJECT NUMBER: 6107

G001

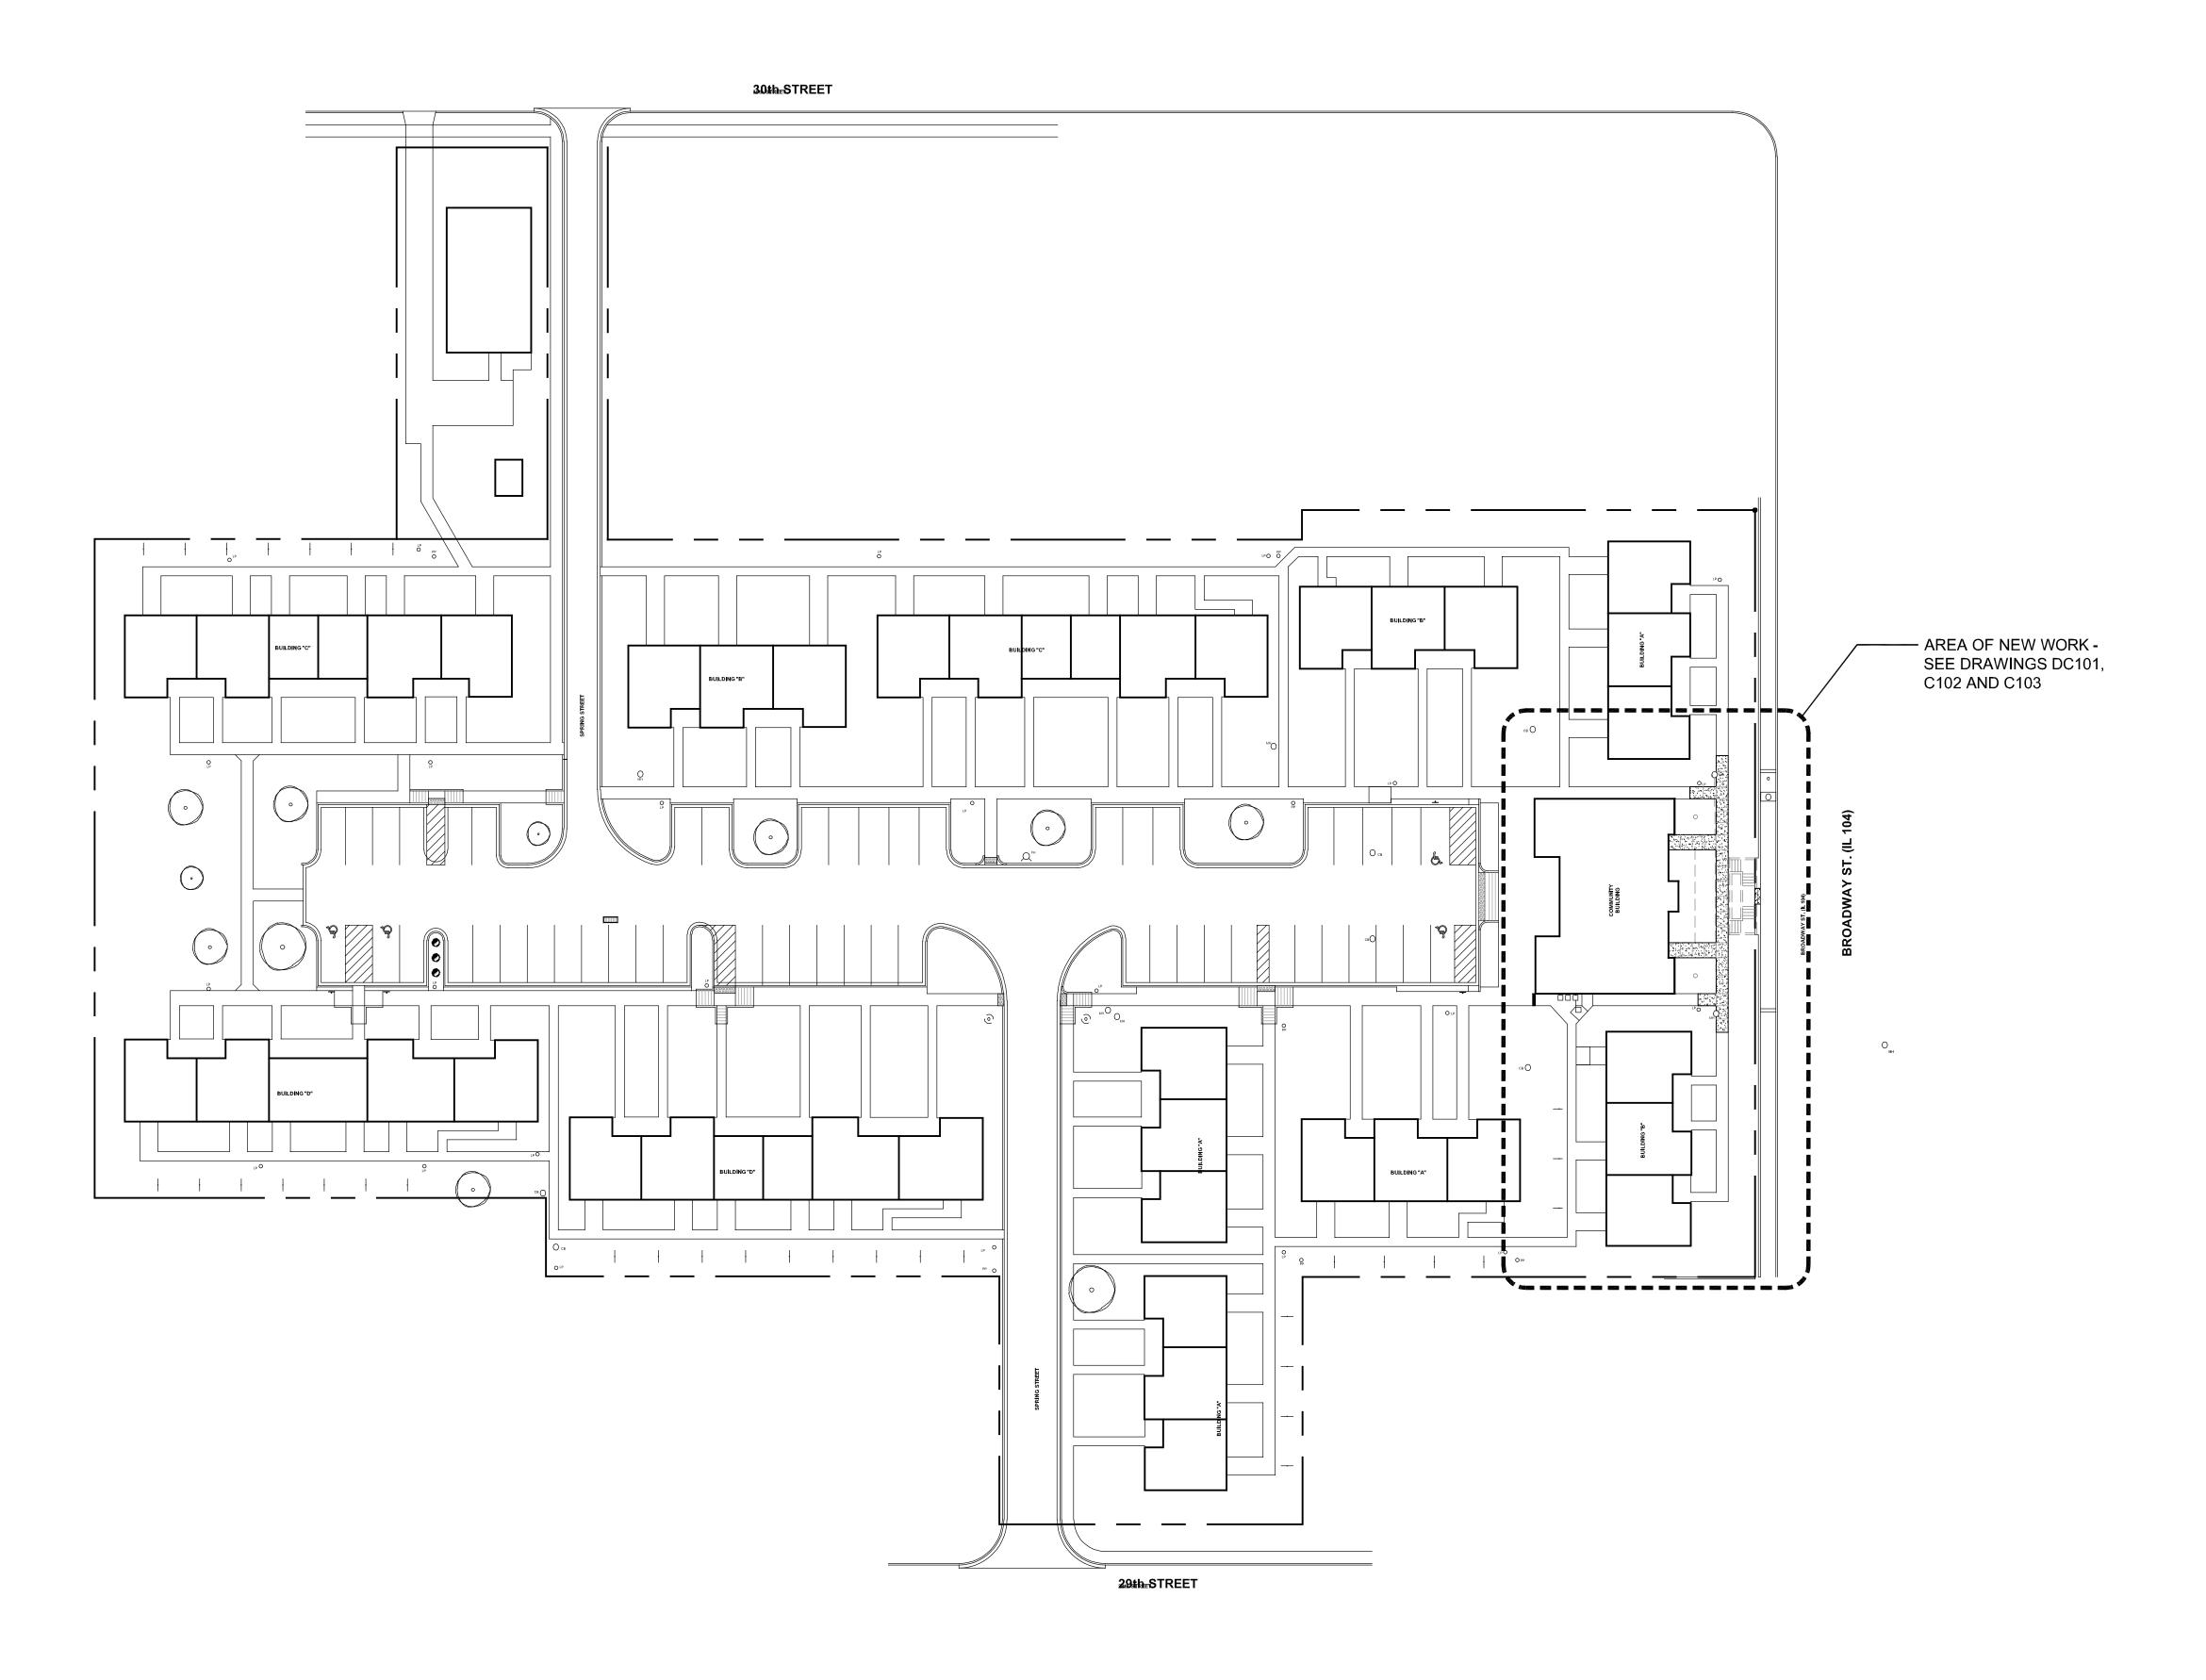



CURRENT DATE: 8/6/2021



EXTERIOR IMPROVEMENTS AT: 29TH & QUINCY HOUSING A
540 HARRISON STREET, QUINCY, ILLING
JERRY GILLE, EXECUTIVE DIRECTOR

CONSTRUCTION DOCUMENT PHASE


ISSUED FOR BIDDING

ISSUE DATE: 8/6/2021 REVISIONS

PROJECT NUMBER: 6107

SITE PLAN

DWG. NO. C101

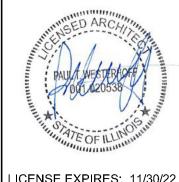

CONSTRUCTION DOCUMENT


PHASE

ISSUED FOR BIDDING SSUE DATE: **8/6/2021** REVISIONS

DEMOLITION

SITE PLAN

PROJECT NUMBER: 6107

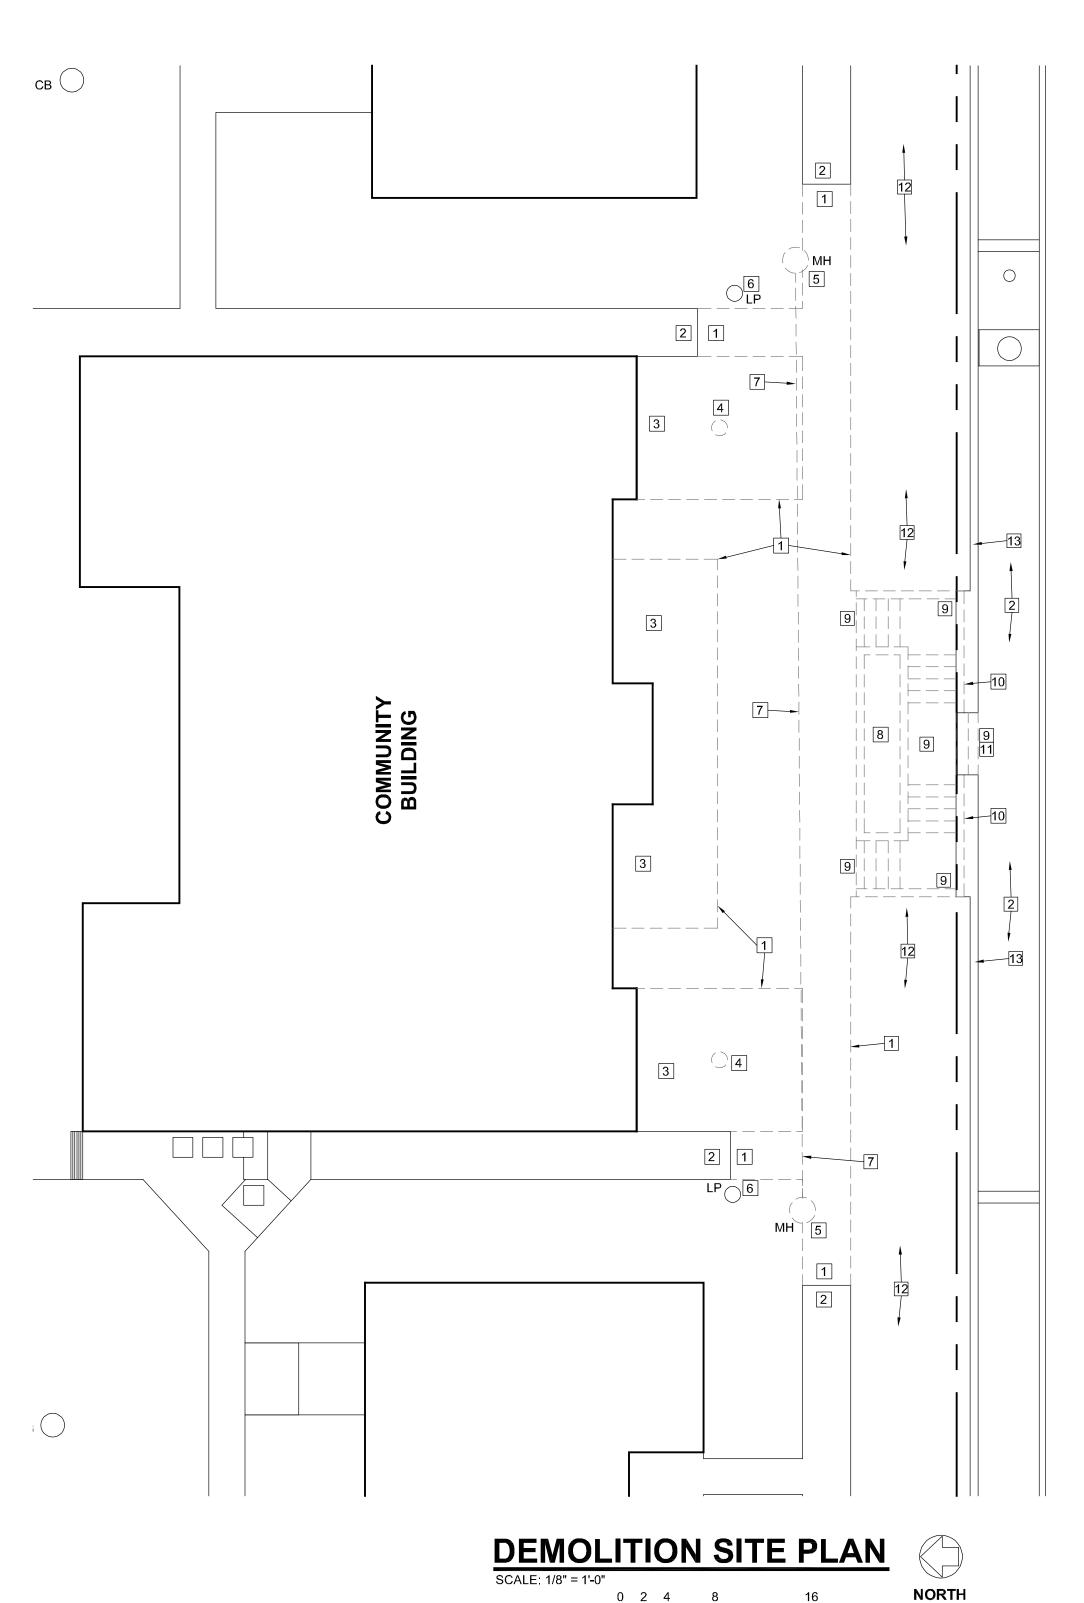

LEGEND

LIGHT POLE POWER POLE MANHOLE FIRE HYDRANT CATCH BASIN YARD CLEANOUT ——— — PROPERTY LINE

SITE DEMOLITION NOTES

- 1 EXISTING CONCRETE SIDEWALK CONSTRUCTION TO BE REMOVED
- 2 EXISTING CONCRETE SIDEWALK TO REMAIN
- 3 EXISTING LANDSCAPING IN THIS AREA TO BE REMOVED
- 4 EXISTING PLANTER TO BE REMOVED
- 5 EXISTING MANHOLE TO BE REMOVED, SEE DWG. C103
- 6 EXISTING LIGHT POLE TO REMAIN
- 7 EXISTING SANITARY SEWER PIPING BETWEEN MANHOLES TO BE REMOVED, SEE
- 8 EXISTING PLANTER BOX TO BE REMOVED IN ITS ENTIRETY
- 9 EXISTING CONCRETE STAIRWAY, BRICK WALLS, STEEL HANDRAILS, AND CONCRETE FOUNDATIONS BELOW TO BE REMOVED
- 10 EXISTING BRICK WALLS ATOP CONCRETE GRADE BEAM TO BE REMOVED, EXISTING GRADE BEAM TO REMAIN
- 11 REMOVE EXISTING CONCRETE SIDEWALK IN THIS AREA AS REQUIRED FOR NEW
- 12 EXISTING LANDSCAPING IN THIS AREA TO REMAIN
- 13 EXISTING CONCRETE WALL CONSTRUCTION TO REMAIN

INFILL WALL CONSTRUCTION, SEE DRAWING C102

GENERAL NOTES

1. CONTRACTOR SHALL VERIFY ALL DIMENSIONS AND EXISTING CONDITIONS.

OUT THE WORK IN ACCORDANCE WITH THE CONTRACT DOCUMENTS.

IN PLACE AND FINAL CONNECTIONS ARE MADE.

SITUATIONS ELSEWHERE, UNLESS OTHERWISE NOTED.

CONSTRUCTION.

2. COORDINATE ALL WORK WITH ALL TRADES, INCLUDING MECHANICAL, PLUMBING AND ELECTRICAL.

3. AFTER DEMOLITION, THE CONTRACTOR SHALL CLEAN AREA FOR INSTALLATION OF NEW MATERIAL.

CONSTRUCTION MEANS, METHODS, TECHNIQUES, SEQUENCES OR PROCEDURES FOR THE SAFETY PRECAUTIONS AND PROGRAMS IN CONNECTION WITH THIS PROJECT, AND SHALL NOT BE RESPONSIBLE

FOR CONTRACTOR'S FAILURE TO CARRY OUT HIS WORK IN ACCORDANCE WITH THE CONTRACT

5. ARCHITECHNICS SHALL NOT BE RESPONSIBLE FOR, NOR HAVE CONTROL OVER, THE ACTS OR

6. THE CONTRACTOR SHALL PROVIDE AND BE RESPONSIBLE FOR ALL TEMPORARY SHORING AND

AND CONNECTIONS SHALL BE OF SUFFICIENT STRENGTH TO SUPPORT THE IMPOSED LOADS.

FABRICATION OF ANY NEW STRUCTURAL ELEMENT. CONTRACTOR SHALL DOCUMENT ANY

THE FORM OF DETAILED SKETCHES TO THE ARCHITECT/STRUCTURAL ENGINEER FOR REVIEW .

OMISSIONS OF THE CONTRACTOR, SUBCONTRACTORS, ANY OF THEIR AGENTS, OR EMPLOYEES, OR ANY OTHER PERSONS PERFORMING ANY OF THE WORK, OR FOR THE FAILURE OF ANY OF THEM TO CARRY

BRACING REQUIRED FOR THE CONSTRUCTION OF THIS PROJECT. ALL SHORING AND BRACING MEMBERS

TEMPORARY MEMBERS AND CONNECTIONS SHALL NOT BE REMOVED UNTIL PERMANENT MEMBERS ARE

7. CONTRACTOR SHALL VERIFY IN FIELD ALL DIMENSIONS, ELEVATIONS, AND MEMBER SIZES AS SHOWN ON THE CONTRACT DRAWINGS FOR THE EXISTING CONSTRUCTION, PRIOR TO THE DETAILING OR

CONSTRUCTION-RELATED DISCREPANCIES. CONTRACTOR SHALL FURNISH THE ABOVE INFORMATION IN

8. ALL DETAILS, SECTIONS, AND NOTES ON THE DRAWINGS ARE INTENDED TO BE TYPICAL FOR SIMILAR

9. PROTECT EXISTING CONSTRUCTION FROM DAMAGE AS REQUIRED DURING DEMOLITION AND NEW

4. ARCHITECHNICS SHALL NOT BE RESPONSIBLE FOR NOR HAVE CONTROL OR CHARGE OF

LEGEND

LIGHT POLE **POWER POLE** MANHOLE FIRE HYDRANT CATCH BASIN YCO YARD CLEANOUT ——— — PROPERTY LINE

SITE PLAN NOTES:

- 1 NEW CONCRETE SIDEWALK, SEE DETAIL 1/C501
- 2 INSTALL NEW EVERGREEN GROUND COVER TO MATCH EXISTING, VERIFY AT PROJECT SITE
- 3 SLOPE NEW GRADE IN THIS AREA TO MATCH EXISTING, VERIFY AT PROJECT SITE
- 4 GRADE AND RESEED IN THIS AREA AS REQUIRED
- 5 NEW CONCRETE WALL INFILL CONSTRUCTION, SEE DETAIL 6/C501
- 6 PATCH AND REPAIR EXISTING CONCRETE SIDEWALK AS REQUIRED
- 7 MATCH EXISTING ELEVATIONS WHERE NEW CONCRETE SIDEWALKS MEET EXISTING (TYPICAL)
- 8 NEW SANITARY SEWER MANHOLE, SEE DWG. C103
- 9 SEE DRAWING C103 FOR DRAINAGE BEHIND NEW CONCRETE WALL
- 10 REMOVE AND REPLACE DEAD EVERGREEN GROUND COVER TO MATCH EXISTING IN THIS AREA, VERIFY AT PROJECT SITE
- PROVIDE NEW SOIL INFILL TO REDUCE STEEP SLOPE AT EXISTING CONCRETE WALL REMOVE EXISTING LAWN AREA AND INSTALL NEW EVERGREEN GROUND COVER TO MATCH EXISTING, VERIFY AT PROJECT

ENLARGED SITE PLAN
SCALE: 1/8" = 1'-0"





CURRENT DATE: 8/6/2021



LICENSE EXPIRES: 11/30/22


CONSTRUCTION DOCUMENT PHASE

ISSUED FOR BIDDING SSUE DATE: 8/6/2021 REVISIONS

PROJECT NUMBER: 6107

ENLARGED SITE PLAN

DWG. NO. C102

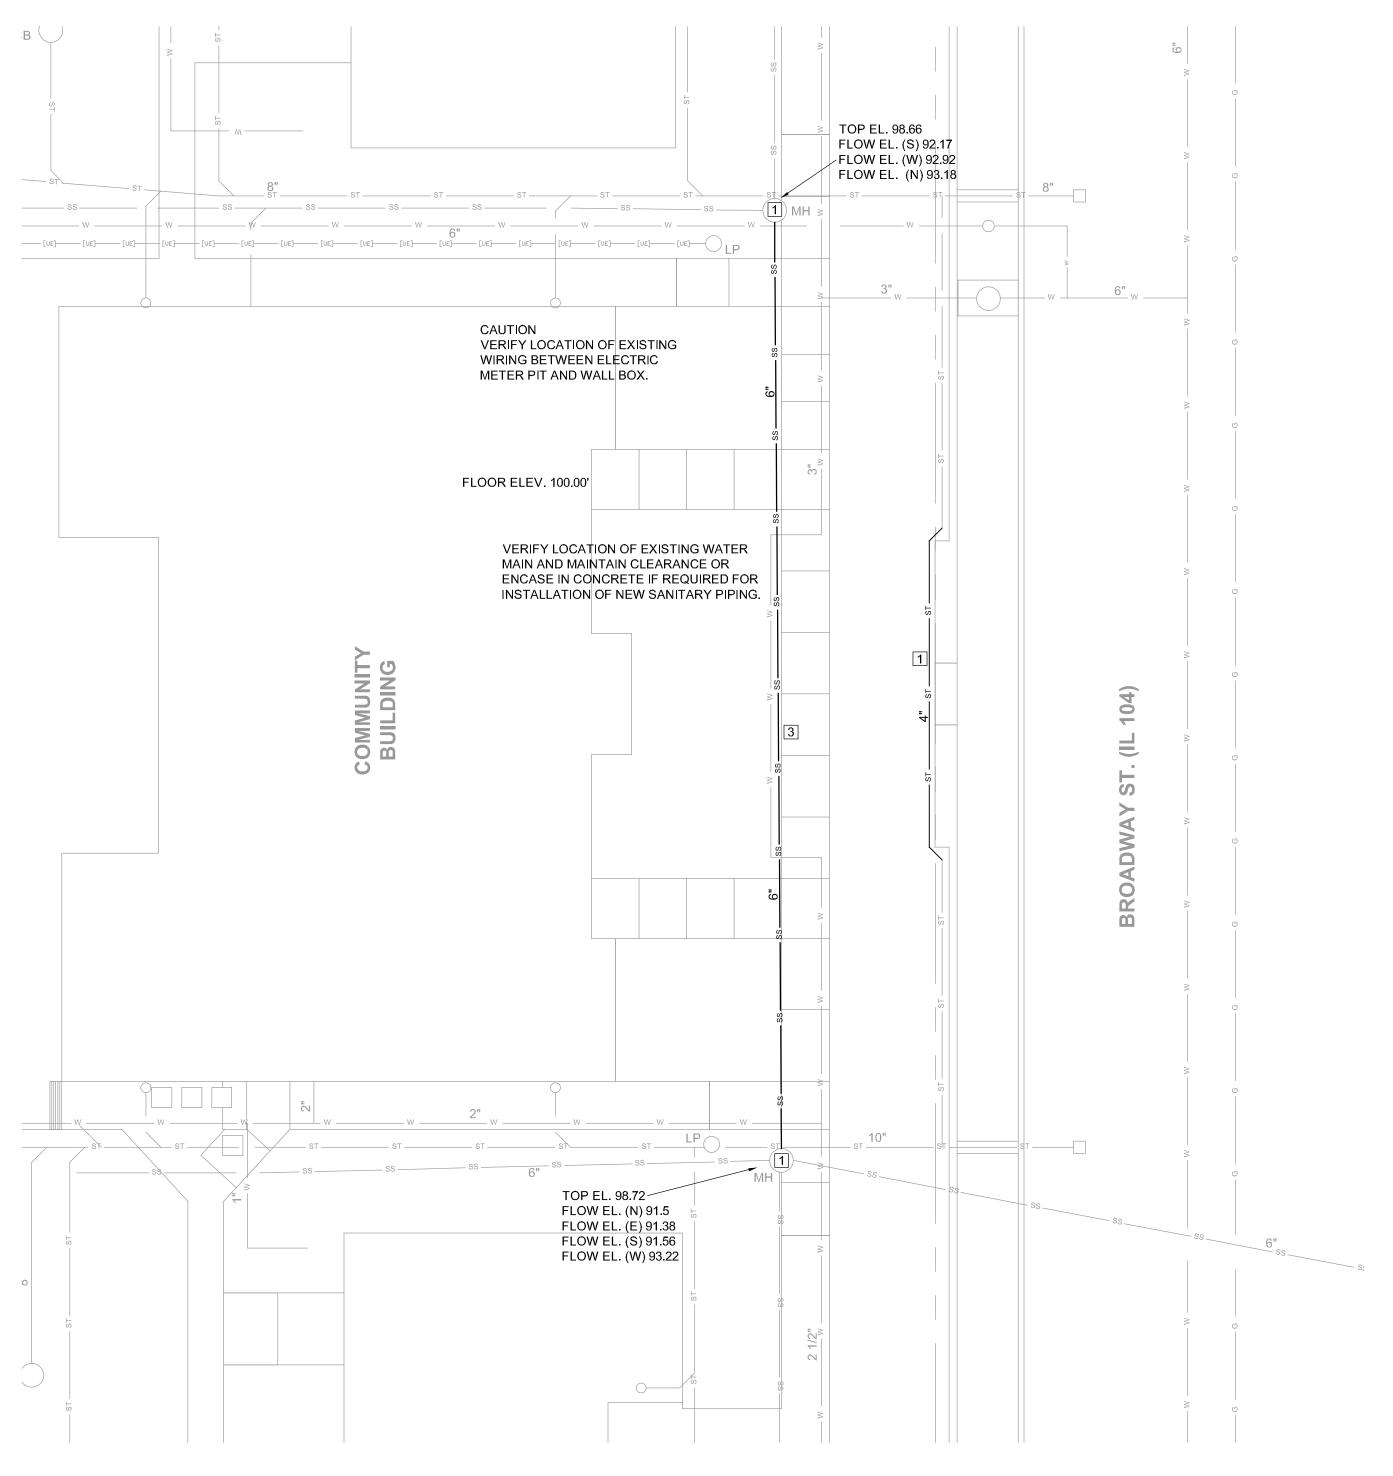

LEGEND

LIGHT POLE **POWER POLE** MANHOLE FIRE HYDRANT CATCH BASIN YARD CLEANOUT ——— — PROPERTY LINE

SITE UTILITIES PLAN NOTES:

- 1 NEW MANHOLE SEE DETAIL C501-5. VERIFY/COORDINATE DEPTH AND PIPE INFLOW/OUTFLOW ELEVATIONS PRIOR TO ORDERING.
- 2 VERIFY LOCATION OF EXISTING RETAINING WALL UNDER DRAIN AND AND INSTALL NEW 4" PIPING WITH ROCK COVER TO MATCH EXISTING.
- 3 VERIFY EXISTING ELEVATIONS PRIOR TO STARTING WORK AND INSTALL NEW 6" PVC SANITARY PIPING BETWEEN NEW MANHOLES.

CURRENT DATE: 8/6/2021



LICENSE EXPIRES: 11/30/22

CONSTRUCTION DOCUMENT PHASE

ISSUED FOR BIDDING SSUE DATE: **8/6/2021** REVISIONS


PROJECT NUMBER: 6107


ENLARGED SITE UTILITIES **PLAN**


DWG. NO.


C103


ENLARGED SITE UTILITIES PLAN
SCALE: 1/8" = 1'-0" NORTH

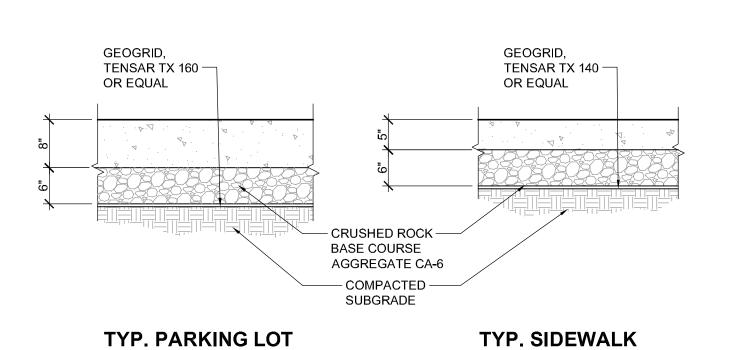

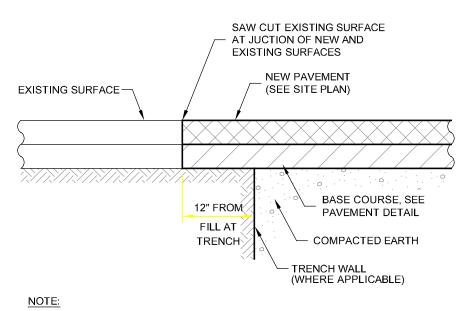

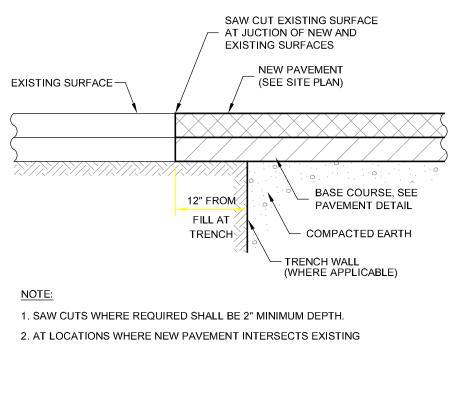

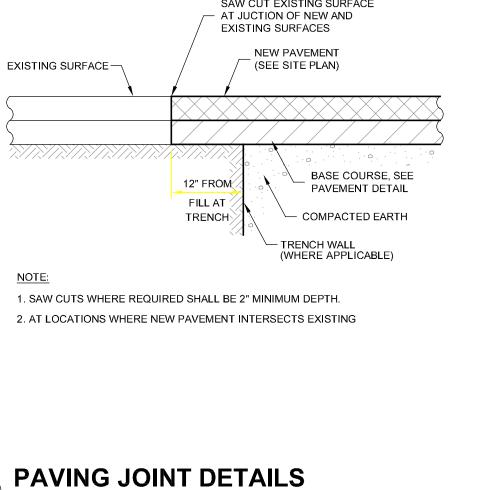

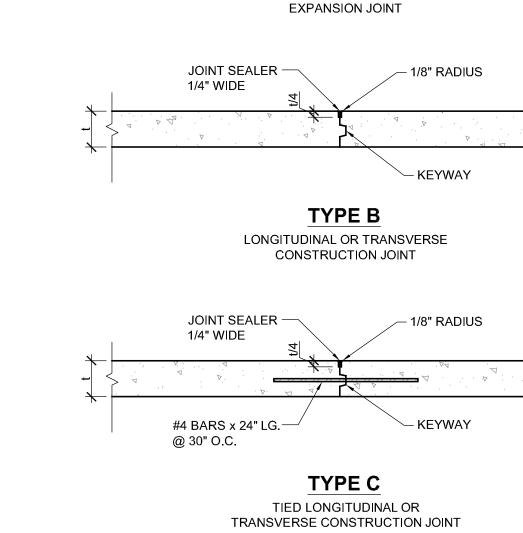


JOINT SEALER -

- 1/8" RADIUS

PREFORMED EXP.


JOINT FILLER

TYPE A

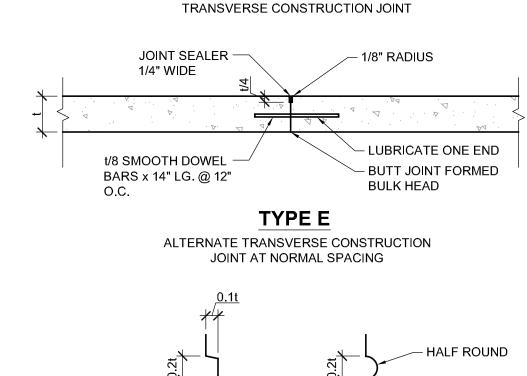

TYPE D

SAWED LONGITUDINAL OR

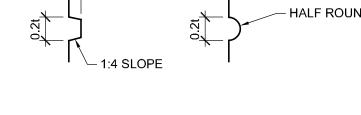

-JOINT SEALER 1/4" WIDE, FLUSH WITH SURFACE

POURED AT

SAME TIME

KEYWAYS FOR TYPES B AND C


CONSTRUCTION JOINTS


RELACEMENT PAVEMENT MOUND BACKFILL TO MATCH EXISTING MAT'L OVER TRENCH AND THICKNESS U.N.O. FINISHED GRADE EXISTING SURFACE -AFTER SETTLEMENT BACKFILL IN ACCORDANCE WITH PIPE MFGS' RECOMMENDATIONS.

CONCRETE PAVING DETAILS

SCALE: 3/4" = 1'-0"

COMPACTED AGGREGATE -BACKFILL FOR FLEXIBLE PIPE USE-SELECT HAND-TAMPED ASTM D 2321 CLASS II BACKFILL TO 1'-0" OVER MATERIAL (3/4" DIA. MAX.) TOP OF PIPE TO 1'-0" OVER TOP OF PIPE VARIES (SEE TABLE) GRANULAR FOUNDATION (IF REQUIRED) TRENCH WIDTHS PIPE DIA. | MAXIMUM | MINIMUM

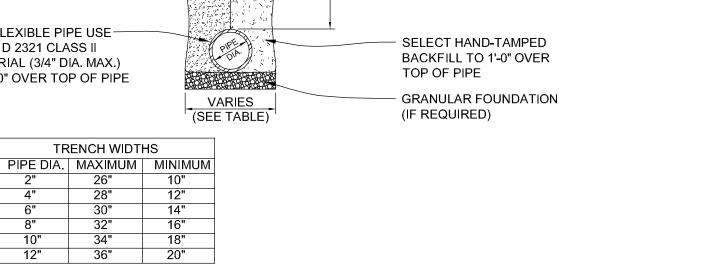

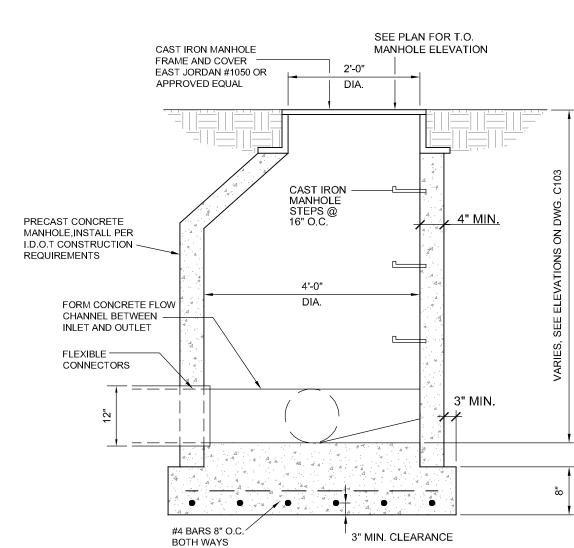

ADJUSTED TO PROVIDE FOR INTERSECTION OF LONGITUDINAL JOINTS AT BOX-OUT CORNERS. 2. ALL TRANSVERSE JOINTS MUST EXTEND THROUGH CURBS AND MUST BE CONTINUOUS ACROSS PAVEMENT, EXCEPT TIED TRANSVERSE CONSTRUCTION JOINTS. EXPANSION JOINTS WILL BE REQUIRED AS SHOWN ON PLANS. 3. MAXIMUM TRANSVERESE JOINT SPACING SHALL BE 15 FEET, UNLESS OTHERWISE SPECIFIED. 4. PAVEMENT JOINTS SHALL BE SEALED WITH HOT POUR MATERIAL MEETING THE REQUIREMENTS OF ASTM D3405. 5. DEFORMED BARS CONFORMING TO THE REQUIREMENTS OF AASHTO M-31 OR M-53 GRADE 40 SHALL BE USED FOR THE TIE BARS. 6. TYPE B JOINTS WHICH ARE TO BE COATED SHALL RECEIVE TWO COATS OF ASPHALTIC EMULSION PRIOR TO PLACEMENT OF THE ADJACENT PAVEMENT. 7. TYPE D JOINTS MAY BE USED IN LIEU OF TYPES B OR C JOINTS WHEN SLABS ON BOTH SIDES OF THE JOINT ARE POURED INTEGRALLY. 8. SUPPORT PINS FOR THE TIE BARS, WHEN REQUIRED, SHALL BE OF SIZE AND STRENGTH SUFFICENT TO FIRMLY HOLD THE BAR IN PLACE. 9. THE ALTERNATE CONSTRUCTION OF INTEGRAL OR SEPARATE COMBINATION CURB AND GUTTER IS AT THE CONTRACTOR'S OPTION.

1. AT INLETS, MANHOLES AND OTHER STRUCTURES, TRANSVERSE JOINTS SHALL BE SHORTENED ONE OR MORE PANELS EITHER SIDE OF

THE STRUCTURE TO PERMIT JOINTS TO FALL AT THE CORNERS OF THE BOX-OUT. ONE OR BOTH "L" DIMENSIONS OF THE BOX-OUT MAY BE

3 CONCRETE PAVEMENT JOINT DETAILS
SCALE: N.T.S.


CONCRETE PAVING JOINT NOTES:


TRENCH DETAILS SCALE: 1/2" = 1'-0"

CONCRETE WALL DETAIL

SCALE: 3/4" = 1'-0"



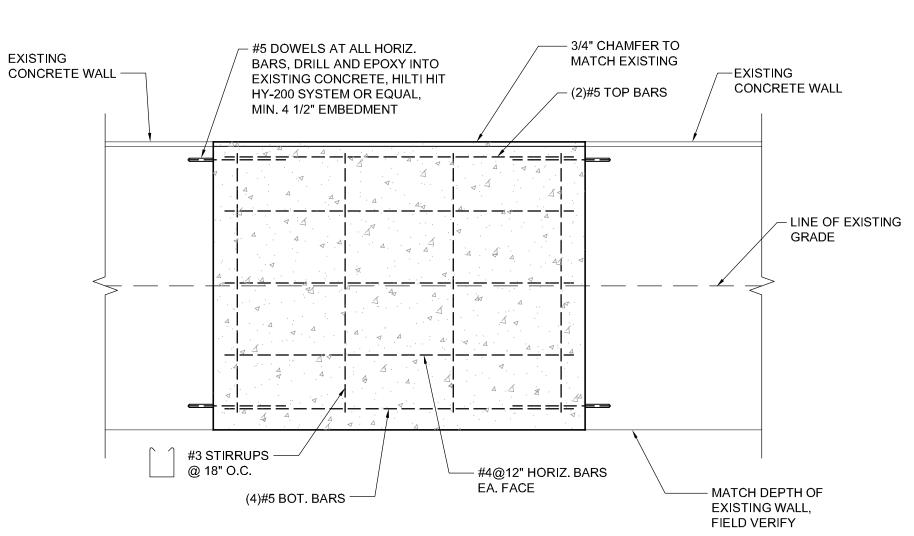

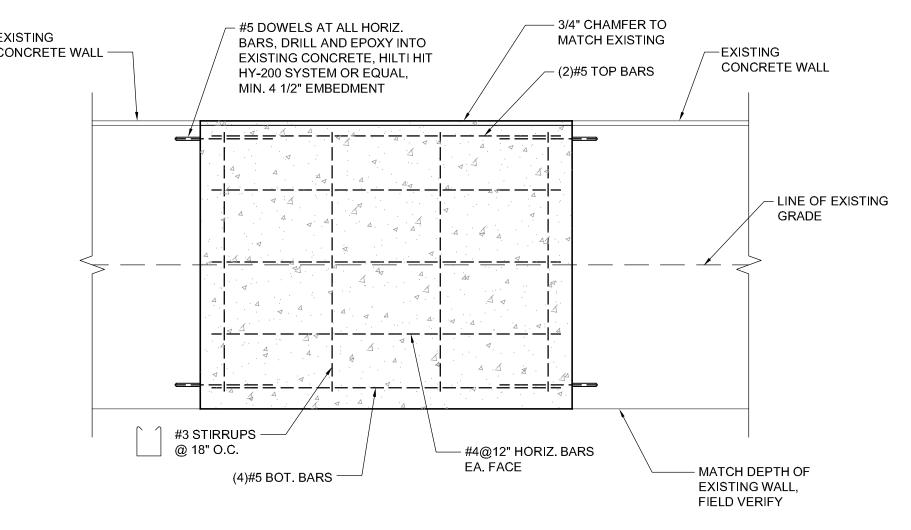



PHASE

ISSUED FOR

BIDDING

SSUE DATE: **8/6/2021** REVISIONS

CURRENT DATE: 8/6/2021

LICENSE EXPIRES: 11/30/22

DWG. NO. C501

PROJECT NUMBER: 6107

SITE

DETAILS