
### HEALTH LIFE SAFETY WORK:

ELECTRICAL SYSTEMS REPLACEMENT AT: QJHS

# QUINCY PUBLIC SCHOOL DISTRICT #172

100 SOUTH 14TH STREET, QUINCY, ILLINOIS

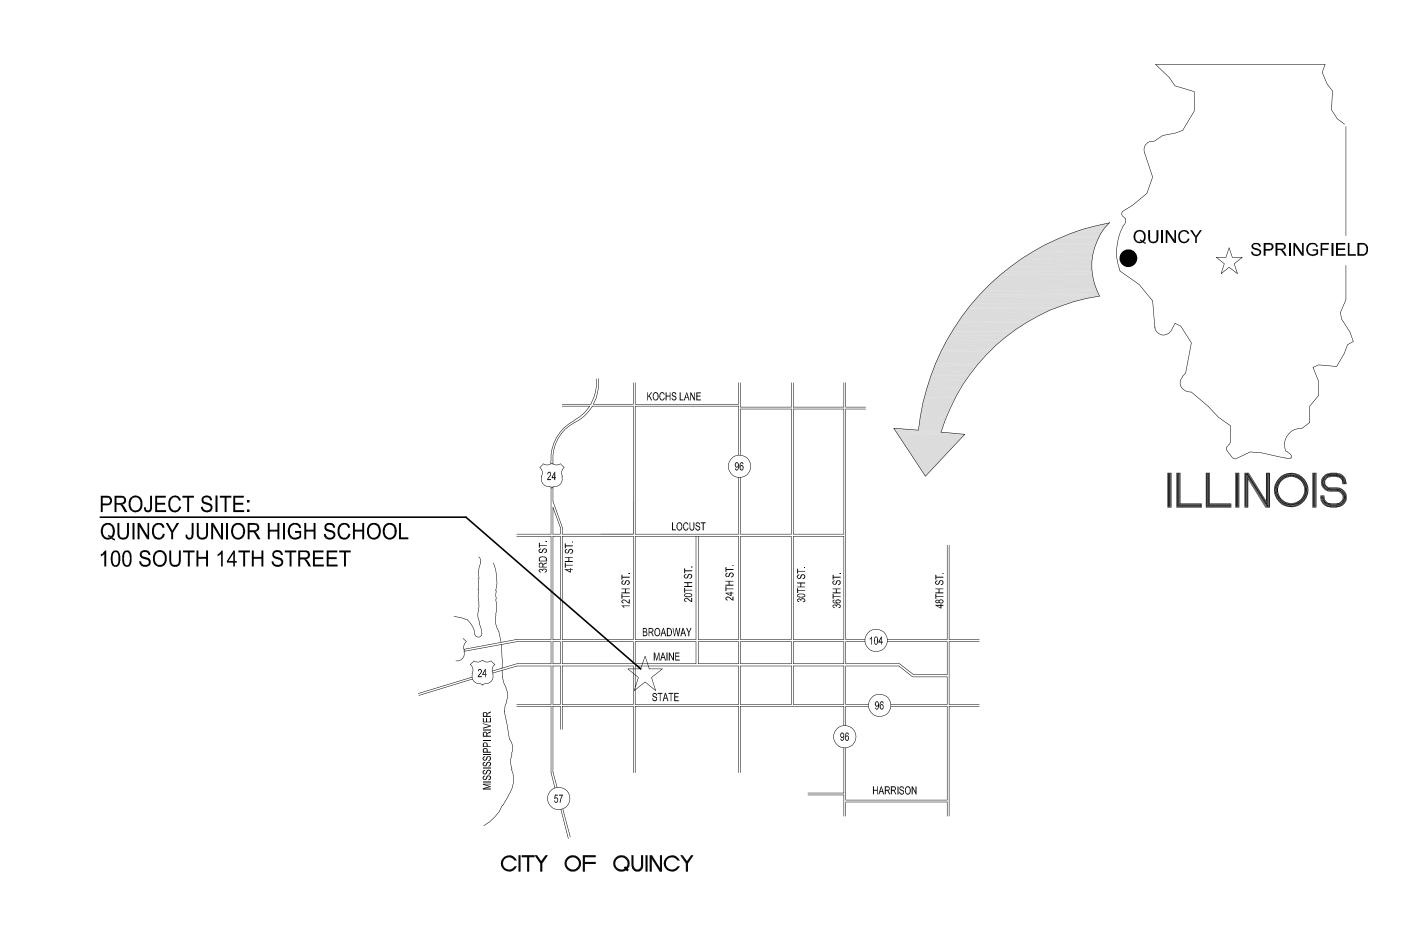

AREA LOCATION - MAP



#### A.D.A. COMPLIANCE

THIS PROJECT SHALL BE IN COMPLIANCE WITH GUIDELINES OF THE AMERICANS WITH DISABILITIES ACT (A.D.A.)

#### AMERICANS WITH DISABILITIES ACT (A.D.A.)

ARCHITECHNICS, TO THE BEST OF ITS ABILITY, HAS EXERCISED PROFESSIONAL EFFORTS TO INTERPRET THE INTENT OF THE "AMERICANS WITH DISABILITIES ACT", AND OTHER APPLICABLE FEDERAL, STATE AND LOCAL CODES AND REQUIREMENTS. ARCHITECHNICS CANNOT GUARANTEE TOTAL COMPLIANCE WITH ANY WORK DIRECTLY RELATED TO THE A.D.A., WHEN THE OWNER PERFORMS AND/OR AUTHORIZES WORK USING THESE DOCUMENTS AND/OR DRAWINGS.

## MATERIALS

PROPERTY CORNER

714	EXISTING CONTOUR			
14_	NEW CONTOUR			
	EARTH			
	CRUSHED ROCK			
	CONCRETE			
	FACE BRICK			
	CONCRETE BLOCK			
	PARTITION, SEE CODE			
>4	DIMENSION LUMBER			
	FINISH LUMBER			
	GYPSUM WALLBOARD			
	PLYWOOD			

BATT INSULATION

METALS

#### **GENERAL NOTES**

- 1. CONTRACTOR TO VERIFY ALL DIMENSIONS.
- ANY DISCREPANCIES BETWEEN STATED AND EXISTING CONDITIONS SHALL BE REPORTED IMMEDIATELY TO THE ARCHITECT.
- DISCREPANCIES OR CONFLICTS BETWEEN SPECIFICATIONS AND DRAWINGS SHALL BE MADE KNOWN TO THE ARCHITECT FOR CLARIFICATION.
- THE CONTRACTOR SHALL BE RESPONSIBLE FOR PROTECTING THOSE
- AREAS TO REMAIN UNDISTURBED DURING CONSTRUCTION. THE CONTRACTOR SHALL TAKE NECESSARY PRECAUTIONS, TO MAINTAIN SAFETY AT THE CONSTRUCTION SITE, AND HE IS SOLELY RESPONSIBLE FOR SAFETY MEASURES. THE CONTRACTOR IS ALSO SOLELY
- REGARDING EXECUTION OF THE WORK. THE CONTRACTOR SHALL CONFORM TO ALL LOCAL AND STATE CODES AND RECEIVE LOCAL AND STATE APPROVAL WHERE NECESSARY PRIOR TO

RESPONSIBLE FOR CONSTRUCTION MEANS, METHODS, AND TECHNIQUES

- CONSTRUCTION. THE CONTRACTOR SHALL GIVE ALL NECESSARY NOTICES AND OBTAIN ALL PERMITS AND PAY ALL LEGAL FEES. HE SHALL ALSO COMPLY WITH ALL
- CITY, COUNTY, AND STATE BUILDING LAWS, ORDINANCES, OR REGULATIONS. 8. THE CONTRACTOR SHALL BE RESPONSIBLE FOR ANY DAMAGE DONE TO THE PREMISES OR ADJACENT PREMISES, OR INJURIES TO THE PUBLIC DURING THE CONSTRUCTION OF THE WORK, CAUSED BY HIMSELF, HIS SUBCONTRACTOR, OR THE CARELESSNESS OF ANY OF HIS EMPLOYEES.
- 9. THE CONTRACTOR MUST UNDERSTAND THAT THE WORK IS ENTIRELY AT HIS RISK UNTIL SAME IS ACCEPTED, AND HE WILL BE HELD RESPONSIBLE FOR ITS SAFETY.
- 10. THE CONTRACTOR SHALL FURNISH AND INSTALL ALL NECESSARY TEMPORARY WORKS FOR THE PROTECTION OF THE WORK, INCLUDING BARRICADES, WARNING SIGNS, LIGHTS, ETC.
- 11. THE CONTRACTOR SHALL PROVIDE THE ARCHITECT WITH ONE SET OF PRINTS MARKED WITH ANY CHANGES FROM ORIGINAL CONTRACT DOCUMENTS.

### INDEX OF DRAWINGS

G1 **COVER SHEET** 

ABOVE FINISHED FLOOR

ADDITION

ADD'N.

AHU

ALUM A.D.A.

ANCS.

AUTO.

BR'G.

BITUM. BLK'G.

BLDG

BTM.

BUR

CAT

CLG.

C.W.B.

C.B. CLOS. C.O.

COMP.

CONC

C M U

CONN. CONST.

CONT

CONTR.

COR'D

CORR.

CNTR. C.R.

C.F.M.

DEMO

DET

DIA

DIM. DISP.

DIV.

DR.

DBL.

D.S.

C.T.

B.P.

D.F.

DRINKING FOUNTAIN

EACH

FIRST FLOOR PAINTING PLAN SECOND FLOOR PAINTING PLAN THIRD FLOOR PAINTING PLAN FOURTH FLOOR PAINTING PLAN

FIRST FLOOR ELECTRICAL DEMOLITION PLAN SECOND FLOOR ELECTRICAL DEMOLITION PLAN THIRD FLOOR ELECTRICAL DEMOLITION PLAN FOURTH FLOOR ELECTRICAL DEMOLITION PLAN **ED101 ED201 ED301 ED401** 

COMMON ELECTRICAL WORK FIRST FLOOR POWER PLAN FIRST FLOOR LIGHTING PLAN SECOND FLOOR POWER PLAN E101 SECOND FLOOR LIGHTING PLAN THIRD FLOOR POWER PLAN
THIRD FLOOR LIGHTING PLAN
FOURTH FLOOR POWER PLAN
FOURTH FLOOR LIGHTING PLAN
FIFTH FLOOR LIGHTING PLAN

**ABBREVIATIONS** 

M.H.

MFGR.

MANHOLE

MANUFACTURER

SHT. SIM.

SHEET

SIMILAR


ADDITION	EA.	EAGIT	M.T.	MARBLE TILE	S.C.	SOLID CORE
AIR CONDITIONING	E.W.	EACH WAY		···· ·· · · · <del>-</del>	SPEC	SPECIFICATION
AIR HANDLING UNIT	E.M.R.	ELASTOMERIC MEMBRANE	MK.	MARK		
ALTERNATE		ROOFING	M.O.	MASONRY OPENING	S.& V.	STAIN AND VARNISH
ALUMINUM	ELEC.	ELECTRIC	MATL.	MATERIAL	S.S.	STAINLESS STEEL
AMERICANS WITH	E.P.	ELECTRIC PANELBOARD	MECH.	MECHANICAL	STD.	STANDARD
DISABILITIES ACT	EL	ELEVATION	MET.	METAL	STL.	STEEL
ANCHORS	ELEV.	ELEVATOR	MIN.	MINIMUM	STOR.	STORAGE
AUTOMATIC	EXH.	EXHAUST	MISC.	MISCELLANEOUS	ST. S.	STORM SEWER
BEAM	E.F.	EXHAUST FAN	M.R.	MOISTURE RESISTANT	S.G.T.	STRUCTURAL GLAZED
	EXIST	EXISTING	MTD.	MOUNTED		TILE
BEARING	E. J.	EXPANSION JOINT	N.D.	NAPKIN DISPENSER	S.A.P.	SUSPENDED ACCOUSTICAL
BITUMINOUS	EXT	EXTERIOR	N.I.C.	NOT IN CONTRACT		PANELS
BLOCKING	E.I.F.S.	EXTERIOR INSULATION	NOM.	NOMINAL	T.B.	TACK BOARD
BUILDING	E.I.F.3.	FINISH SYSTEM	NO.	NUMBER	T. & S.	TAPE AND SAND
BOARD	EW.0	FABRIC WALL COVERING	OFC.	OFFICE	T.D.D.	TELECOMMUNICATIONS
BOTTOM	F.W.C.				1.0.0.	DEVICE FOR DEAF
BRICK PAVERS	F.V.	FIELD VERIFY	O.C.	ON CENTER	T C	
BUILDING	FIN.	FINISH	OPG.	OPENING	T.G.	TEMPERED GLASS
BUILT-UP ROOF	F.E.C.	FIRE EXTINGUISHER		OPPOSITE HAND	T.R.G.	TEMPERED REFLECTIVE
CARPET		CABINET	OH.	OVERHEAD		GLASS
CAST IRON	FIX.	FIXTURE	PT.	PAINT	TZ.	TERRAZZO
CATALOG	FL.	FLOOR	PR.	PAIR	T.T.	TERRAZZO TILE
CEILING	F.D.	FLOOR DRAIN	PARTN.	PARTITION	THK.	THICK/THICKNESS
CERAMIC TILE	FLOUR.	FLOURESCENT	PERF.	PERFORATED	T'HOLD	THRESHOLD
CERAMIC WALL BASE	FTG.	FOOTING	P.D.	PRESSURE DROP	T.P.	TOILET PAPPER
	FND.	FOUNDAT <b>II</b> ON	PLAS.	PLASTIC	T. & G.	TONGUE AND GROOVE
CHALK BOARD	G.P.M.	GALLONS PER MINUTE	P.S.	PLUMBING STACK	T. & B.	TOP AND BOTTOM
CLOSET	GALV	GALVANIZED	P.V.	PLUMBING VENT	TRANS	TRANSITION
CLEAN OUT	GA.	GAUGE	PLYWD	PLYWOOD	T	TREADS
COMPANY	G.W.T.	GLAZED WALL TILE			TYP.	TYPICAL
COMPOSITION	G.B.	GRAB BAR	P.V.C.	POLYVINYL CHLORIDE	U.L.	UNDERWRITERS
CONCRETE			P.S.F.	POUNDS PER SQUARE	U.L.	
CONCRETE MASONRY	G.F.B.	GROUND FACE BRICK		FOOT		LABORATORIES
UNIT	GYP. BD.	GYPSUM WALLBOARD	PREFIN.	PREFINISHED	U.N.O.	UNLESS NOTED
CONDENSATION	H.D.	HAIR/HAND DRYER		PROJECT MANUAL		OTHERWISE
CONNECTION	HC	HANDICAPPED	QTY.	QUANTITY	U.P.	UTILITY POLE
CONSTRUCTION	HR.	HANDRAIL	Q.T.	QUARRY TILE	V.P.	VAPOR BARRIER
CONSTRUCTION JOINT	HDWE.	HARDWARE	RAD.	RADIUS	VERT.	VERTICAL
CONTINUOUS	H.V.A.C.	HEATING, VENTILATING,	RECEP.	RECEPTACLE	VEST.	VESTIBULE
CONTRACTOR		& AIR CONDITIONING	REF.	REFERENCE	V.C.T.	VINYL COMPOSITION
CORRUGATED	HT	HEIGHT	R.A.	RETURN AIR		TILE
CORRIDOR	H.C.	HOLLOW CORE	R.H.	RIGHT HAND	V.W.C.	VINYL WALL
	H.M.	HOLLOW METAL	R	RISERS	1111101	COVERING
COUNTER	HORIZ	HORIZONTAL	R.D.	ROOF DRAIN	V.C.P.	VITRIFIED CLAY PIPE
CRUSHED ROCK	INC.	INCORPORATED	R.B.	RUBBER BASE	w.c.	WATER CLOSET
CUBIC FEET PER	INSUL.	INSULATION			W.W.F.	WELDED WIRE FABRIC
MINUTE	INSUL.G.		R.C.B.	RUBBER COVE BASE		
DEMOLITION		INSULATED GLASS	REQD.	REQUIRED	W.	WIDTH
DETAIL	JAN.	JANTOR	R.O.W.	RIGHT OF WAY	WDW.	WINDOW
DIAMETER	JT.	JOINT	RM.	ROOM	W.G.	WIRE GLASS
DIMENSION	J.F.	JOINT FILLER	R.I.	ROUGH IN	W/	WITH
DISPENSER	JST.	JOIST	R.O.	ROUGH OPENING	W/O	WITH OUT
DIVISION	J.B.	JUNCTION BOX	R.S.T.	RUBBER STAIR TREAD	WD.	WOOD
DOOR	LAM.	LAMINATE	R.T.	RUBBER TILE	T.	TREADS
DOUBLE	LAV.	LAVATORY	SAN.	SANITARY (SEWER)	TYP.	TYPICAL
DOWNSPOUT	L.H.	LEFT HAND	SCHED.	SCHEDULE	U.L.	UNDERWRITERS
DOWINGFOOT	LG.	LONG	331125.			


CONSTRUCTION DOCUMENT PHASE **ISSUED FOR** 

CONSTRUCTION SSUE DATE: **03/20/2020** REVISIONS PROJECT NUMBER: 5901

**COVER SHEET** 


G101

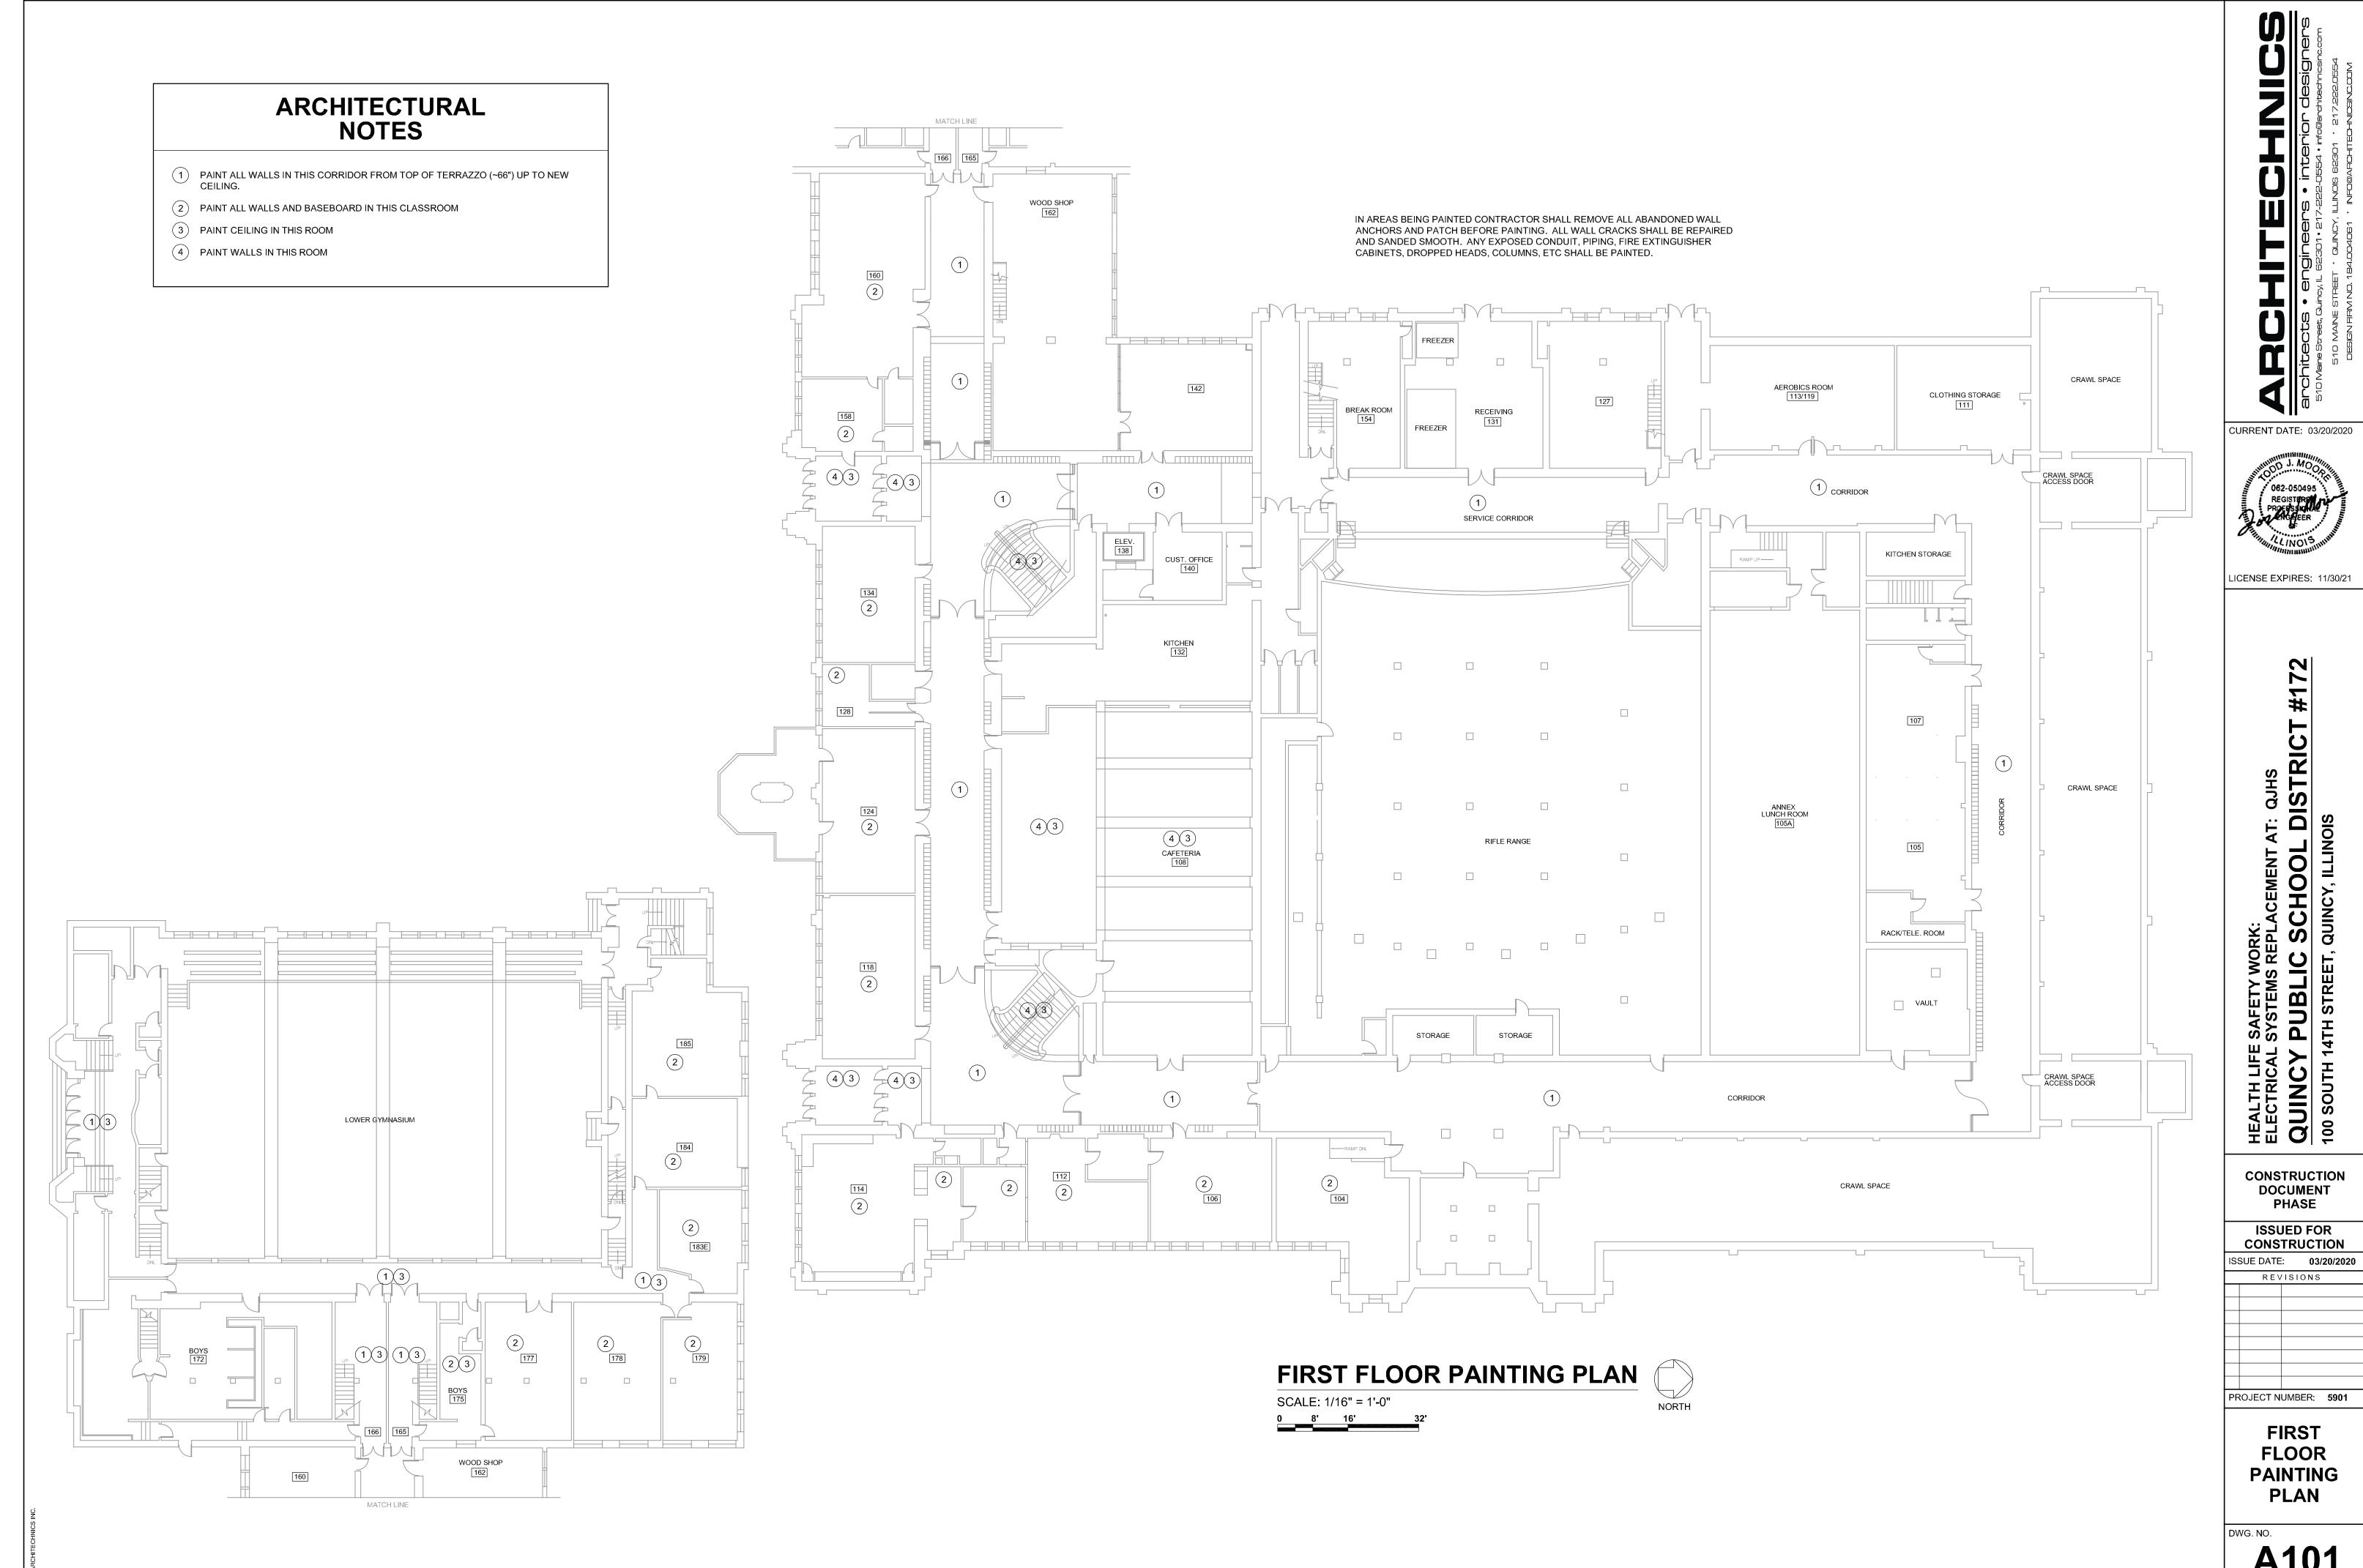

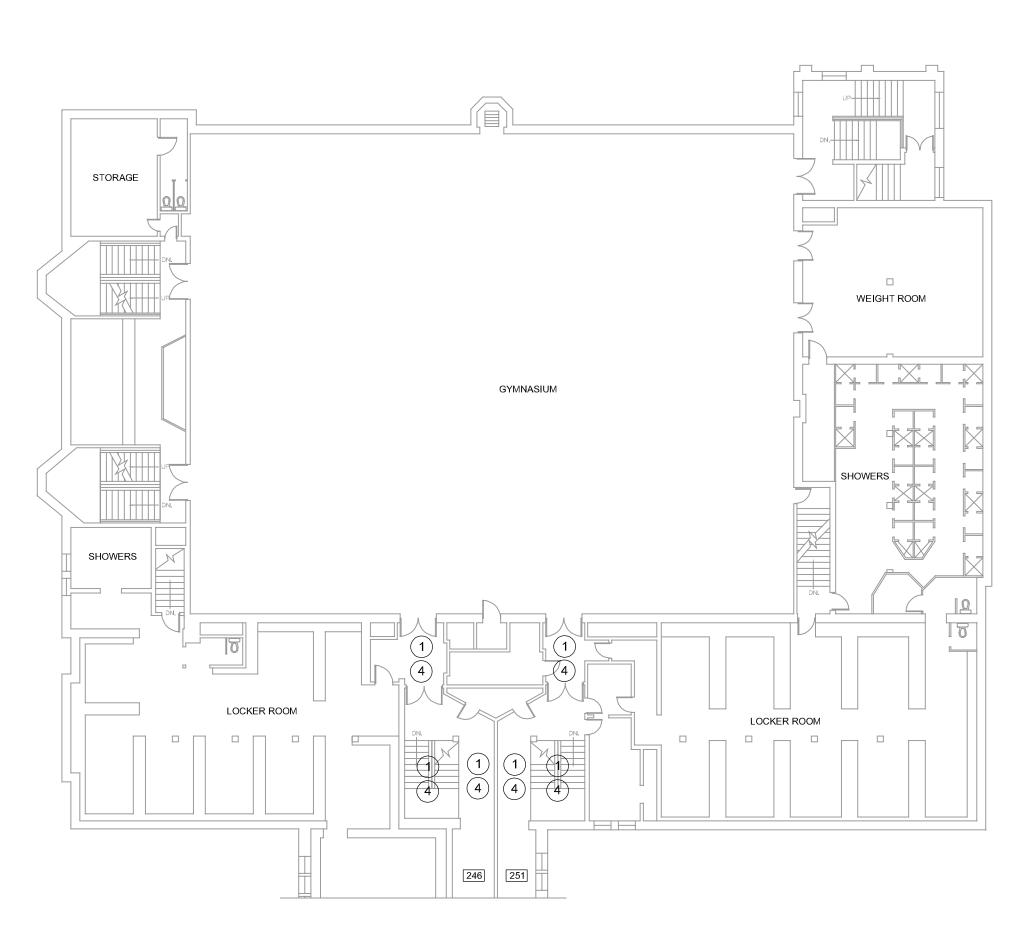

# ARCHITECTURAL NOTES

- 1 PAINT ALL WALLS IN THIS CORRIDOR FROM TOP OF TERRAZZO (~66") UP TO NEW CEILING.
- 2 PAINT ALL WALLS AND BASEBOARD IN THIS CLASSROOM
- 3 PAINT CEILING IN THIS ROOM
- 4 PAINT WALLS IN THIS ROOM

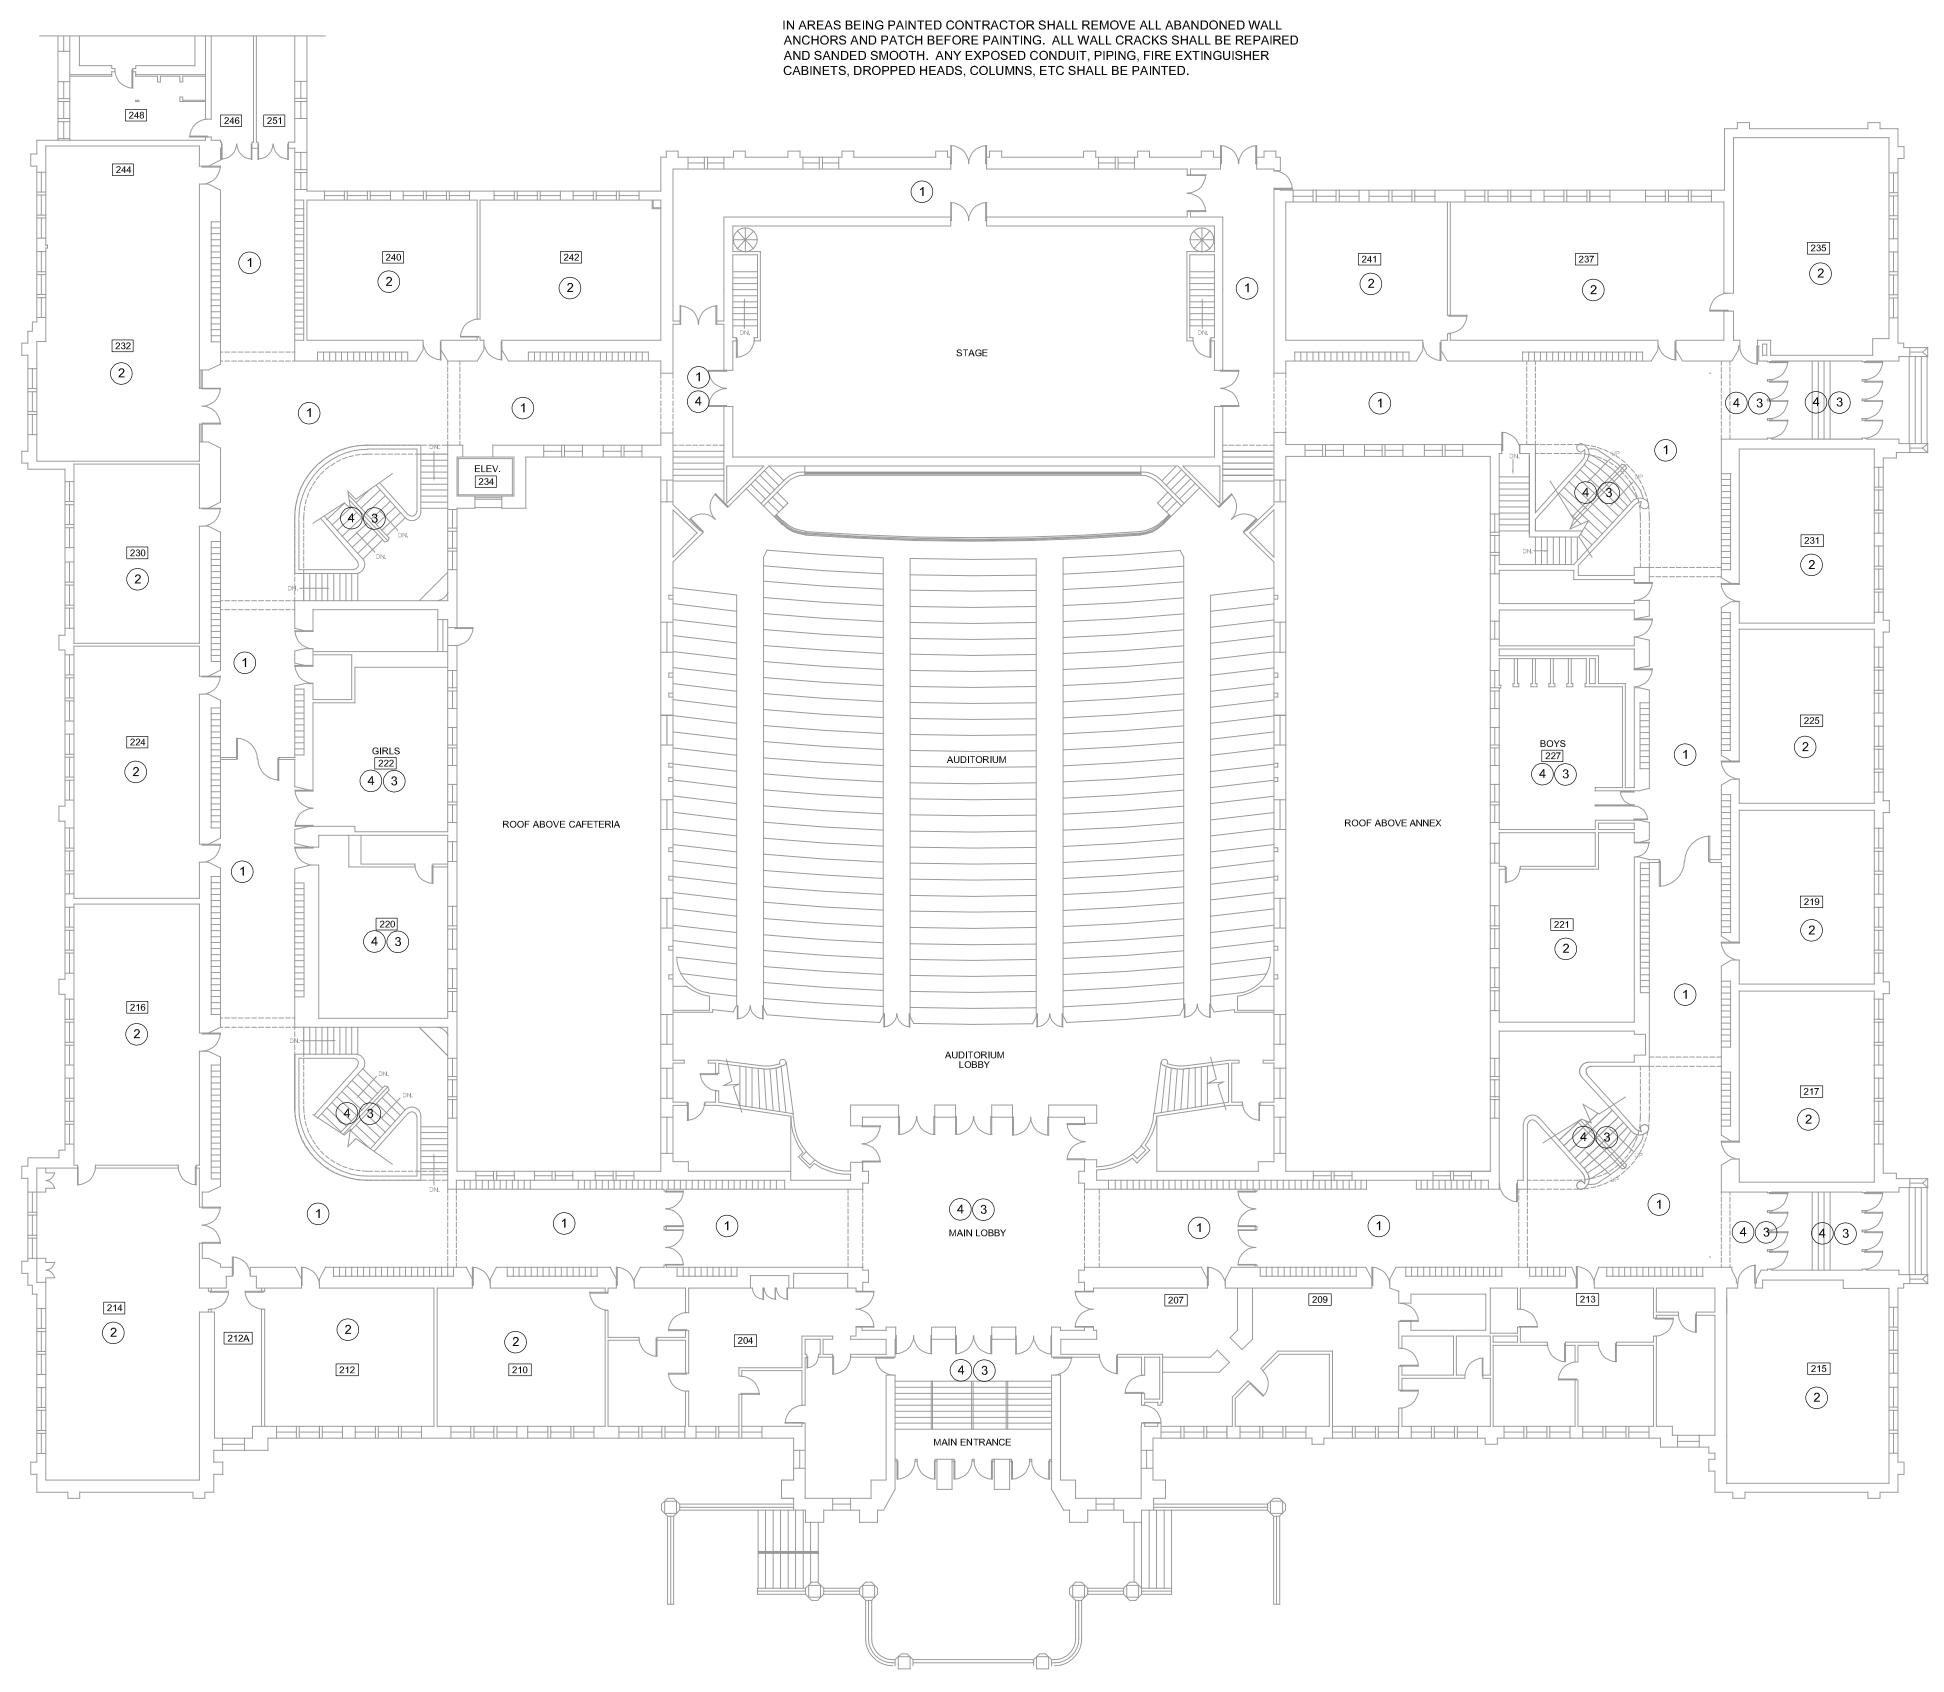

SECOND FLOOR PAINTING PLAN

SCALE: 1/16" = 1'-0" 0 8' 16' 32'



SECOND FLOOR PAINTING PLAN

PROJECT NUMBER: 5901


CONSTRUCTION DOCUMENT PHASE

ISSUED FOR CONSTRUCTION

REVISIONS

CURRENT DATE: 03/20/2020

LICENSE EXPIRES: 11/30/21

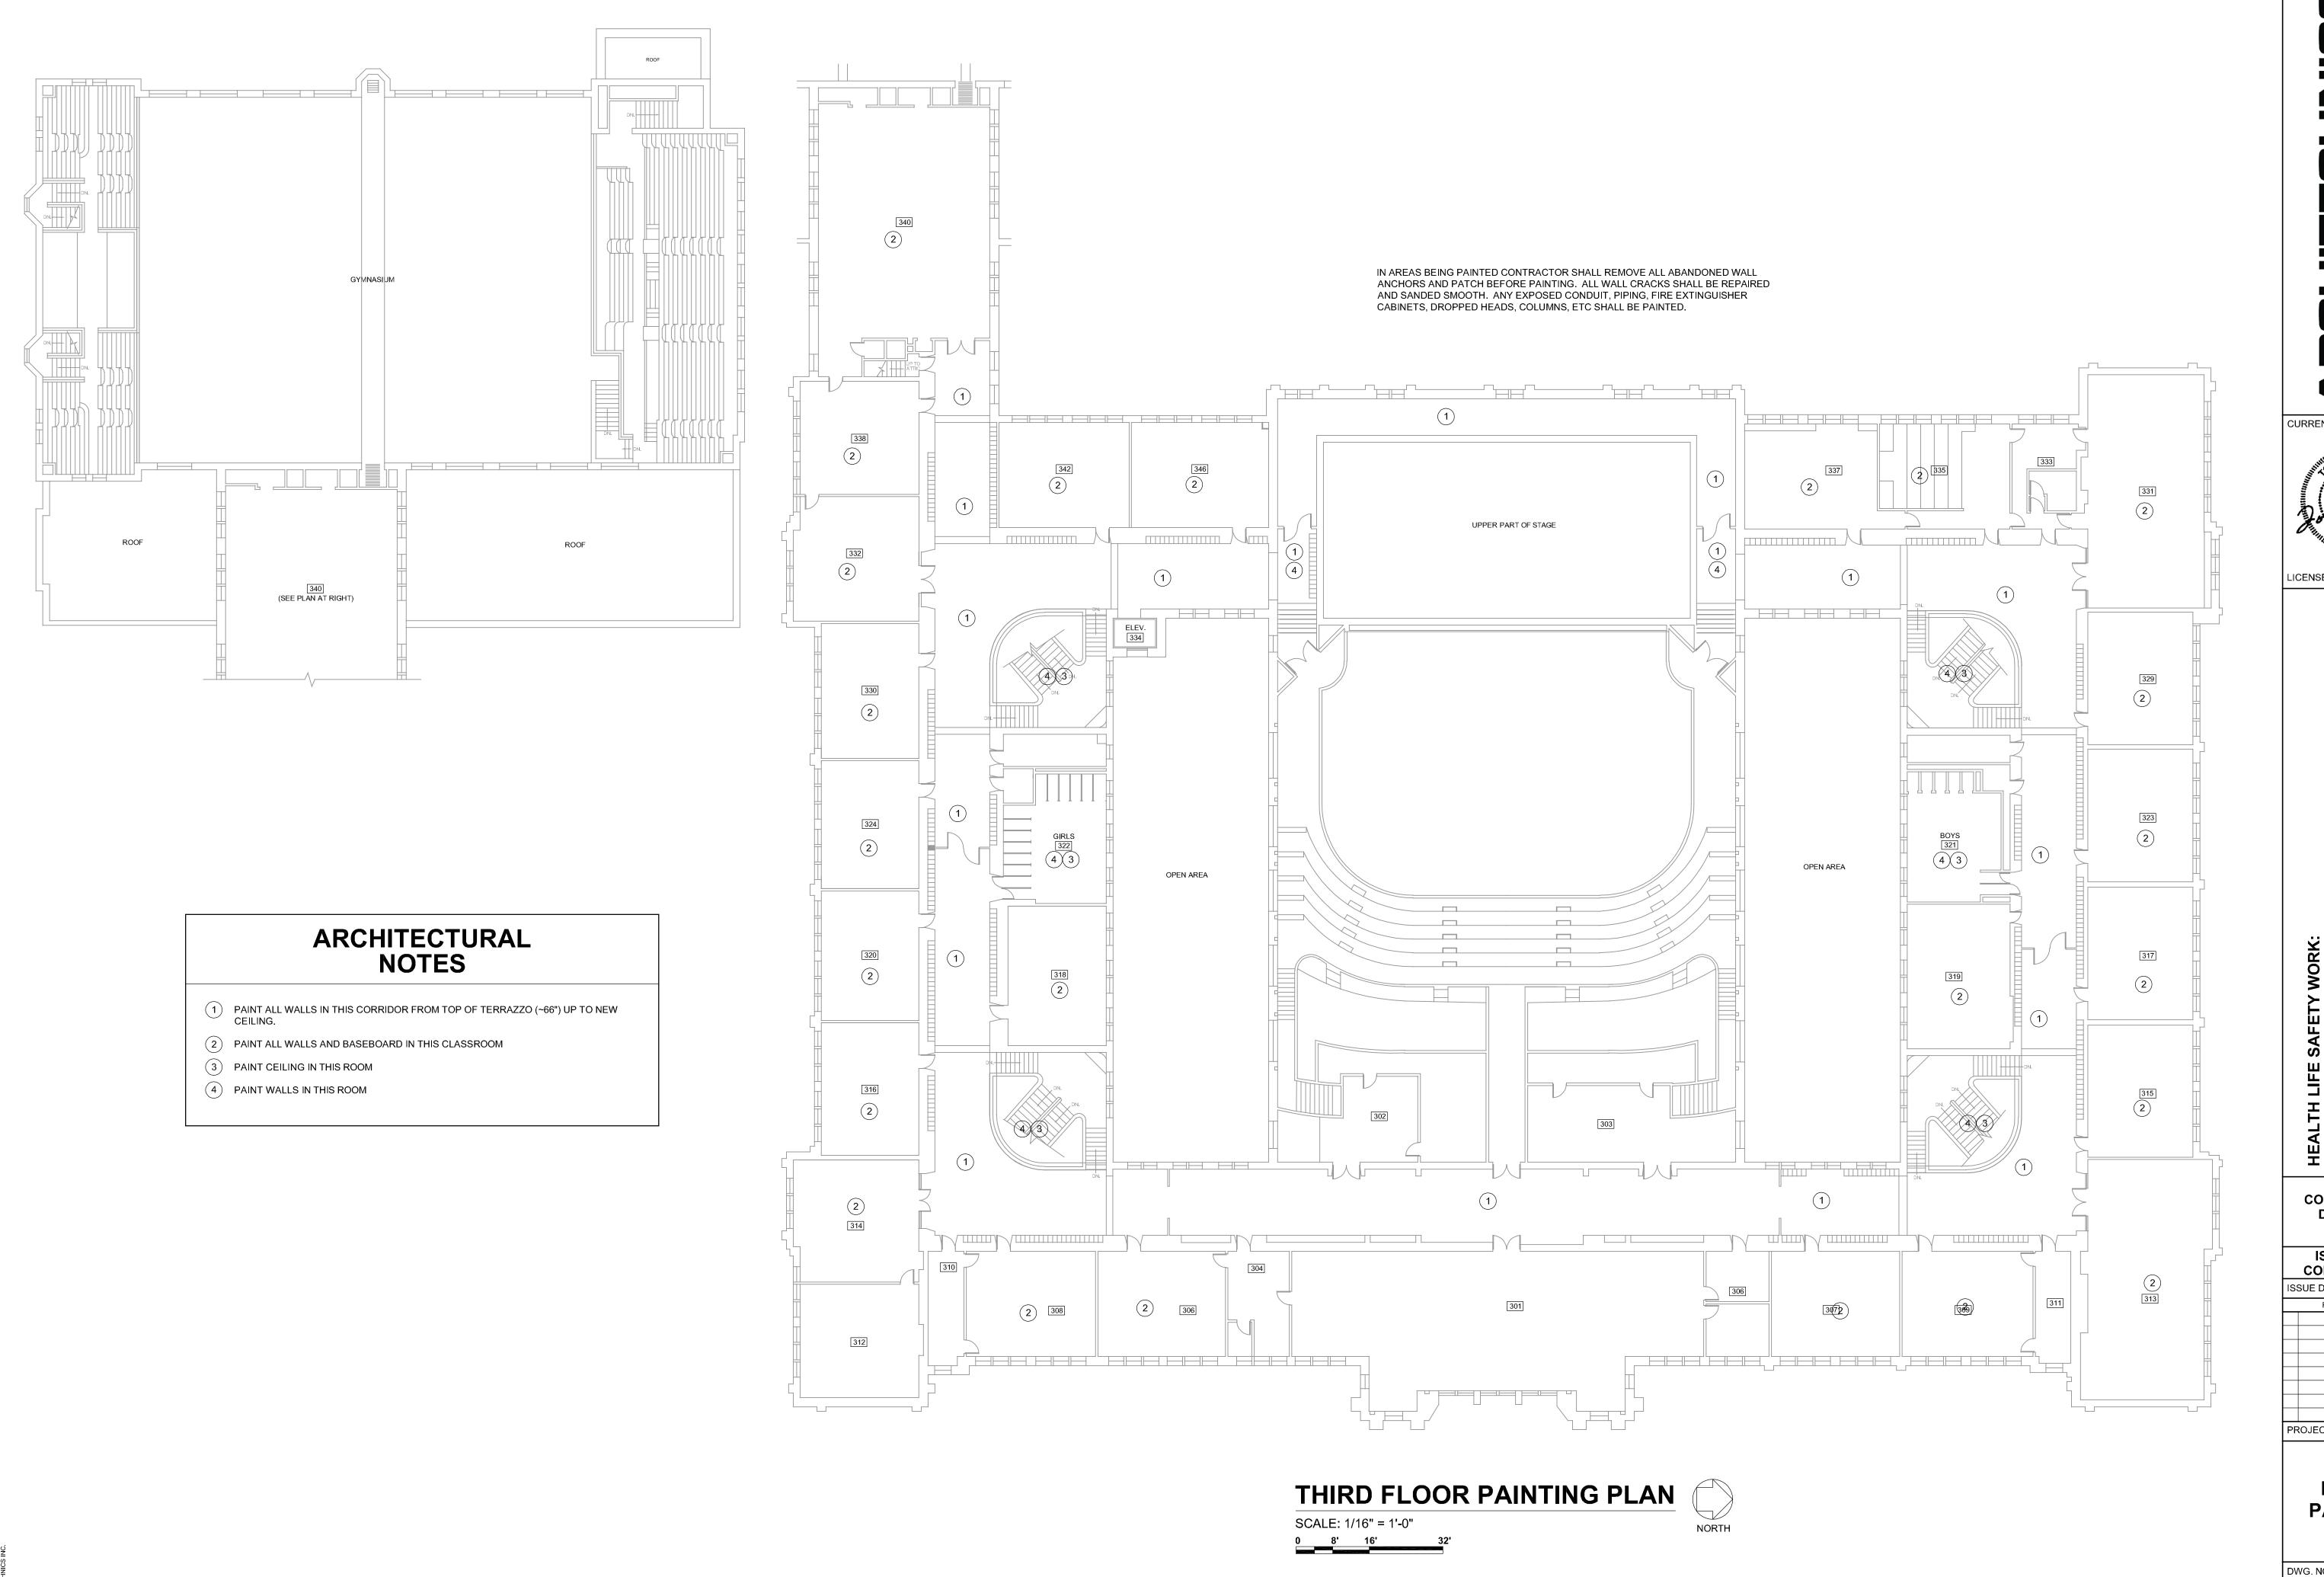

S • engineers • interior designers, a Quincy, IL 62301 • 217-222-0554 • info@enchitechnicsinc.com

CURRENT DATE: 03/20/2020

062-050495
REGISTERED
PROFESSIONAL
PROFESSIO

LICENSE EXPIRES: 11/30/21

IT AT: QJHS

OL DISTRICT #172

HEALTH LIFE SAFETY WORK:
ELECTRICAL SYSTEMS REPLACEMENT AT
QUINCY PUBLIC SCHOOL I
100 SOUTH 14TH STREET, QUINCY, ILLINOI

CONSTRUCTION DOCUMENT PHASE


ISSUED FOR CONSTRUCTION
ISSUE DATE: 03/20/2020

ISSUE DATE: 03/20/202

PROJECT NUMBER: 5901

THIRD FLOOR PAINTING PLAN

DWG. NO.

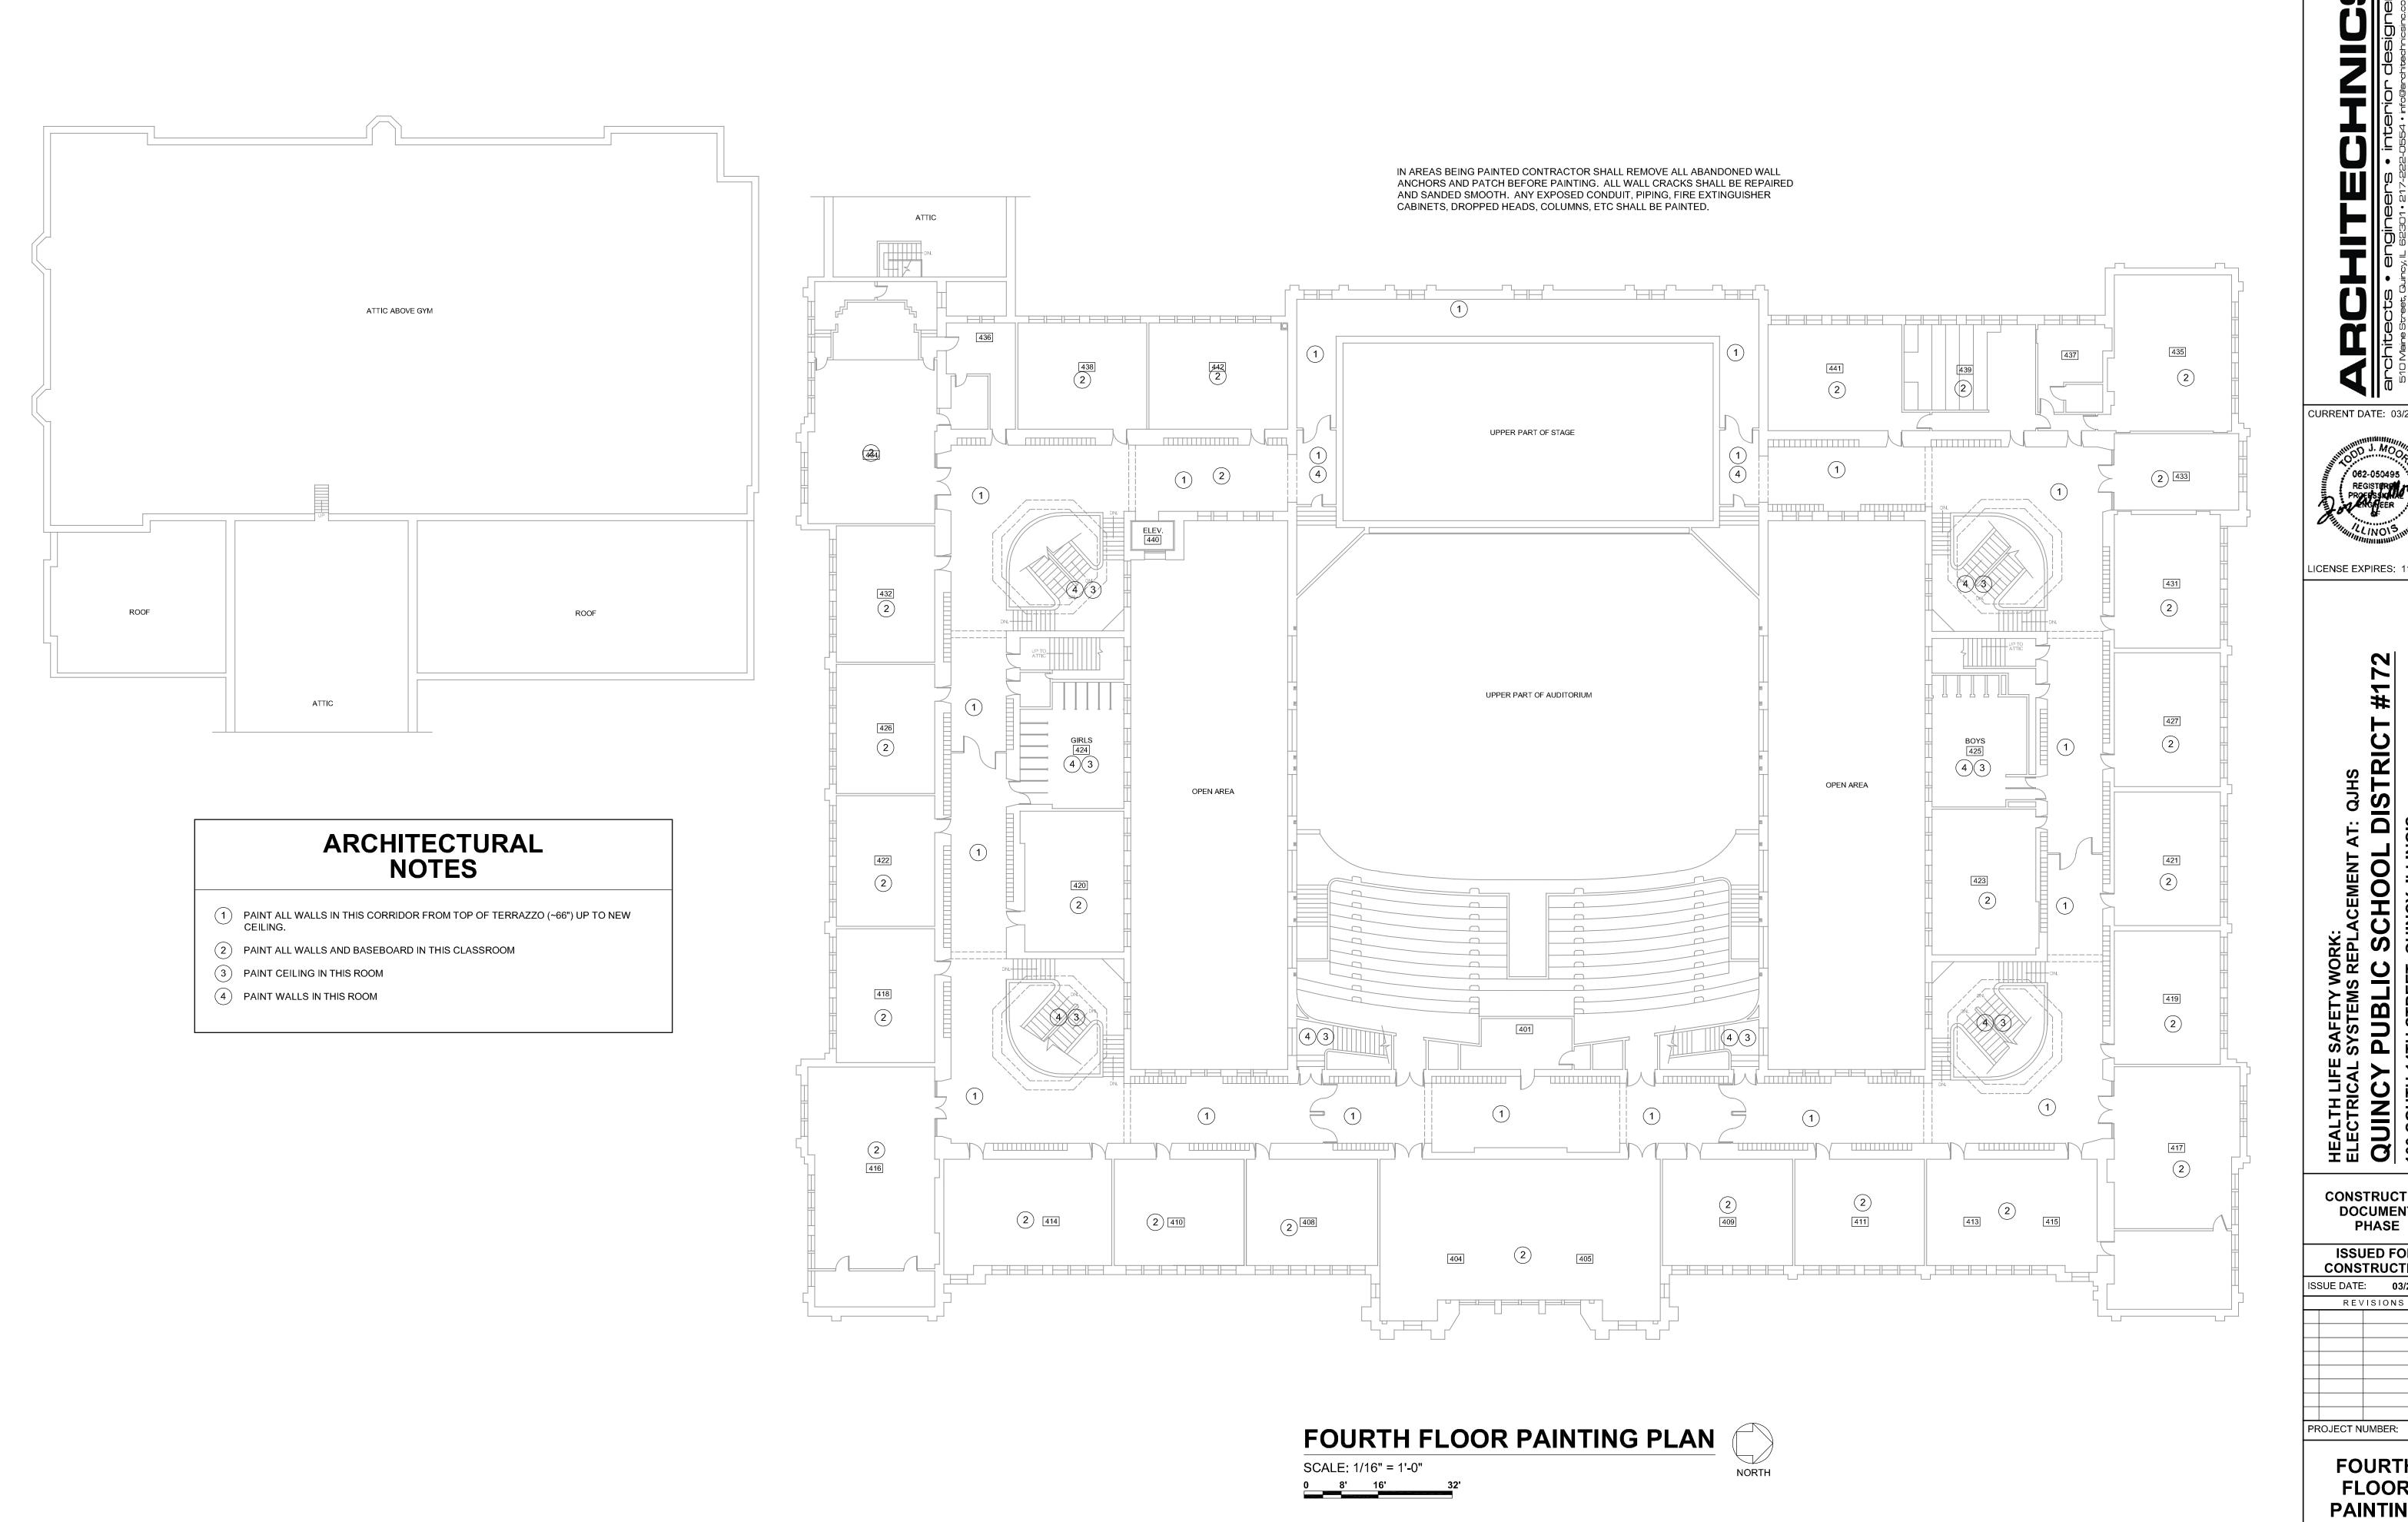

CURRENT DATE: 03/20/2020

LICENSE EXPIRES: 11/30/21


CONSTRUCTION DOCUMENT


ISSUED FOR CONSTRUCTION ISSUE DATE: 03/20/2020 REVISIONS

PROJECT NUMBER: 5901

**FOURTH FLOOR PAINTING PLAN** 


DWG. NO.

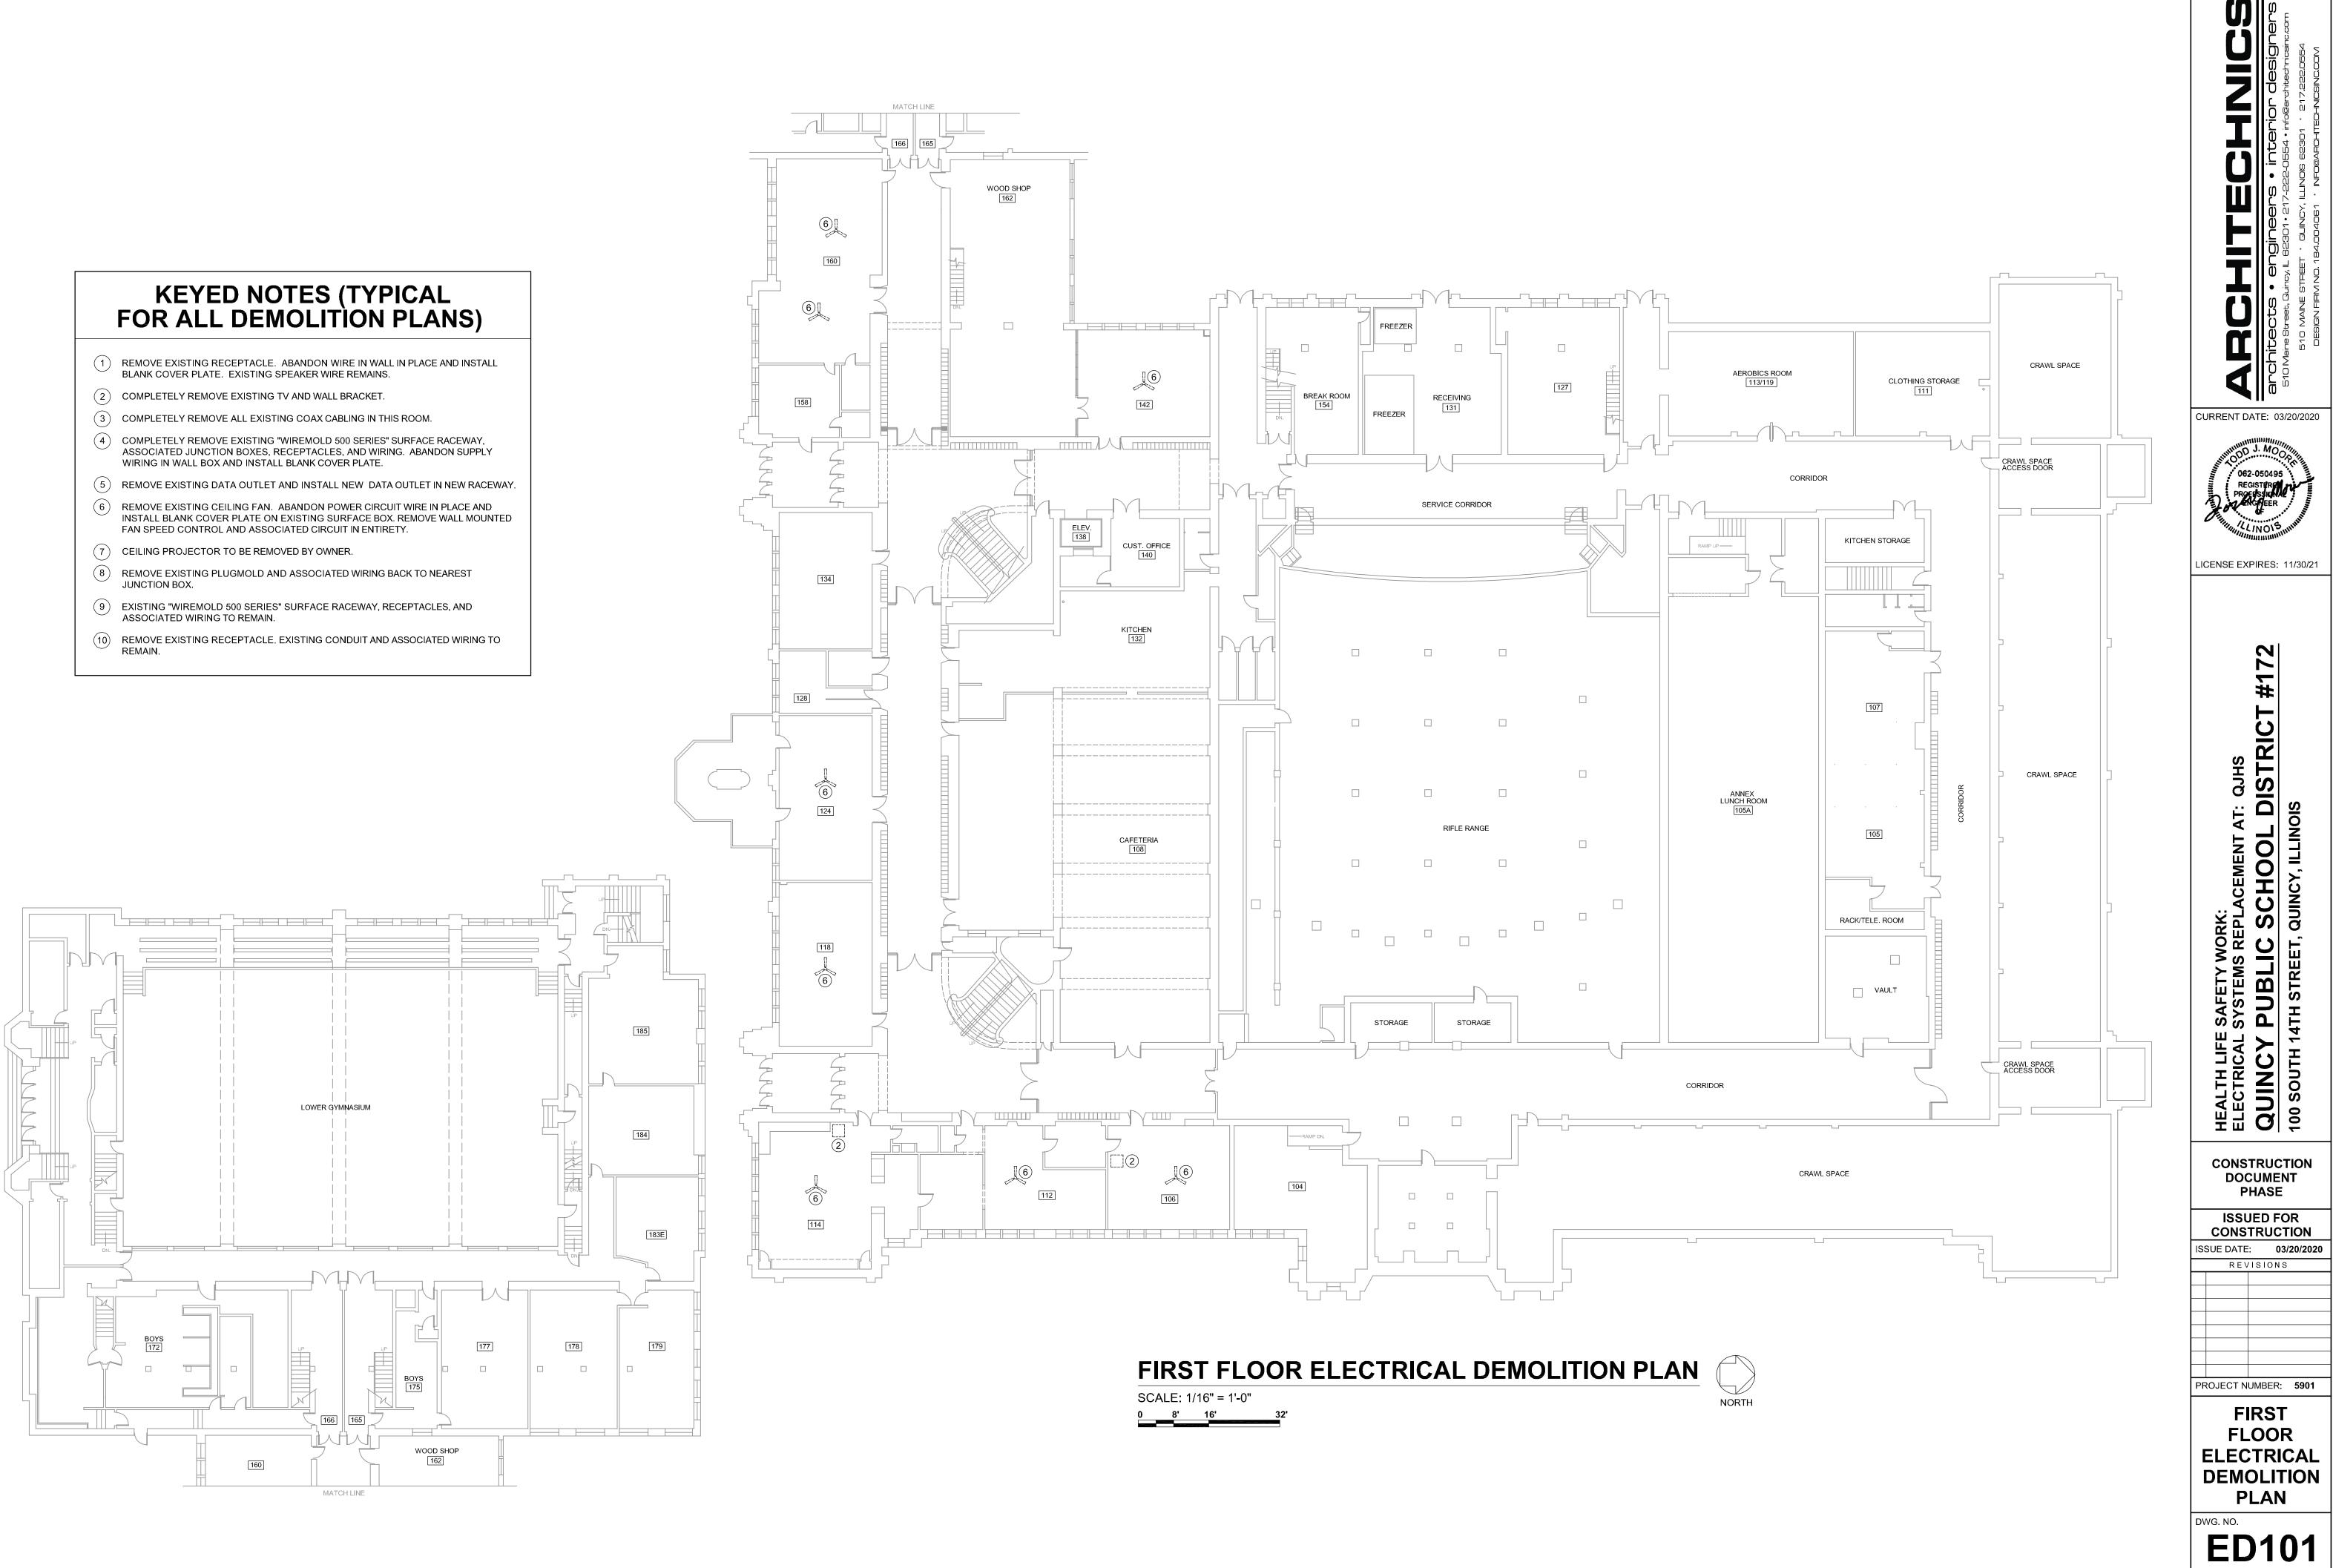

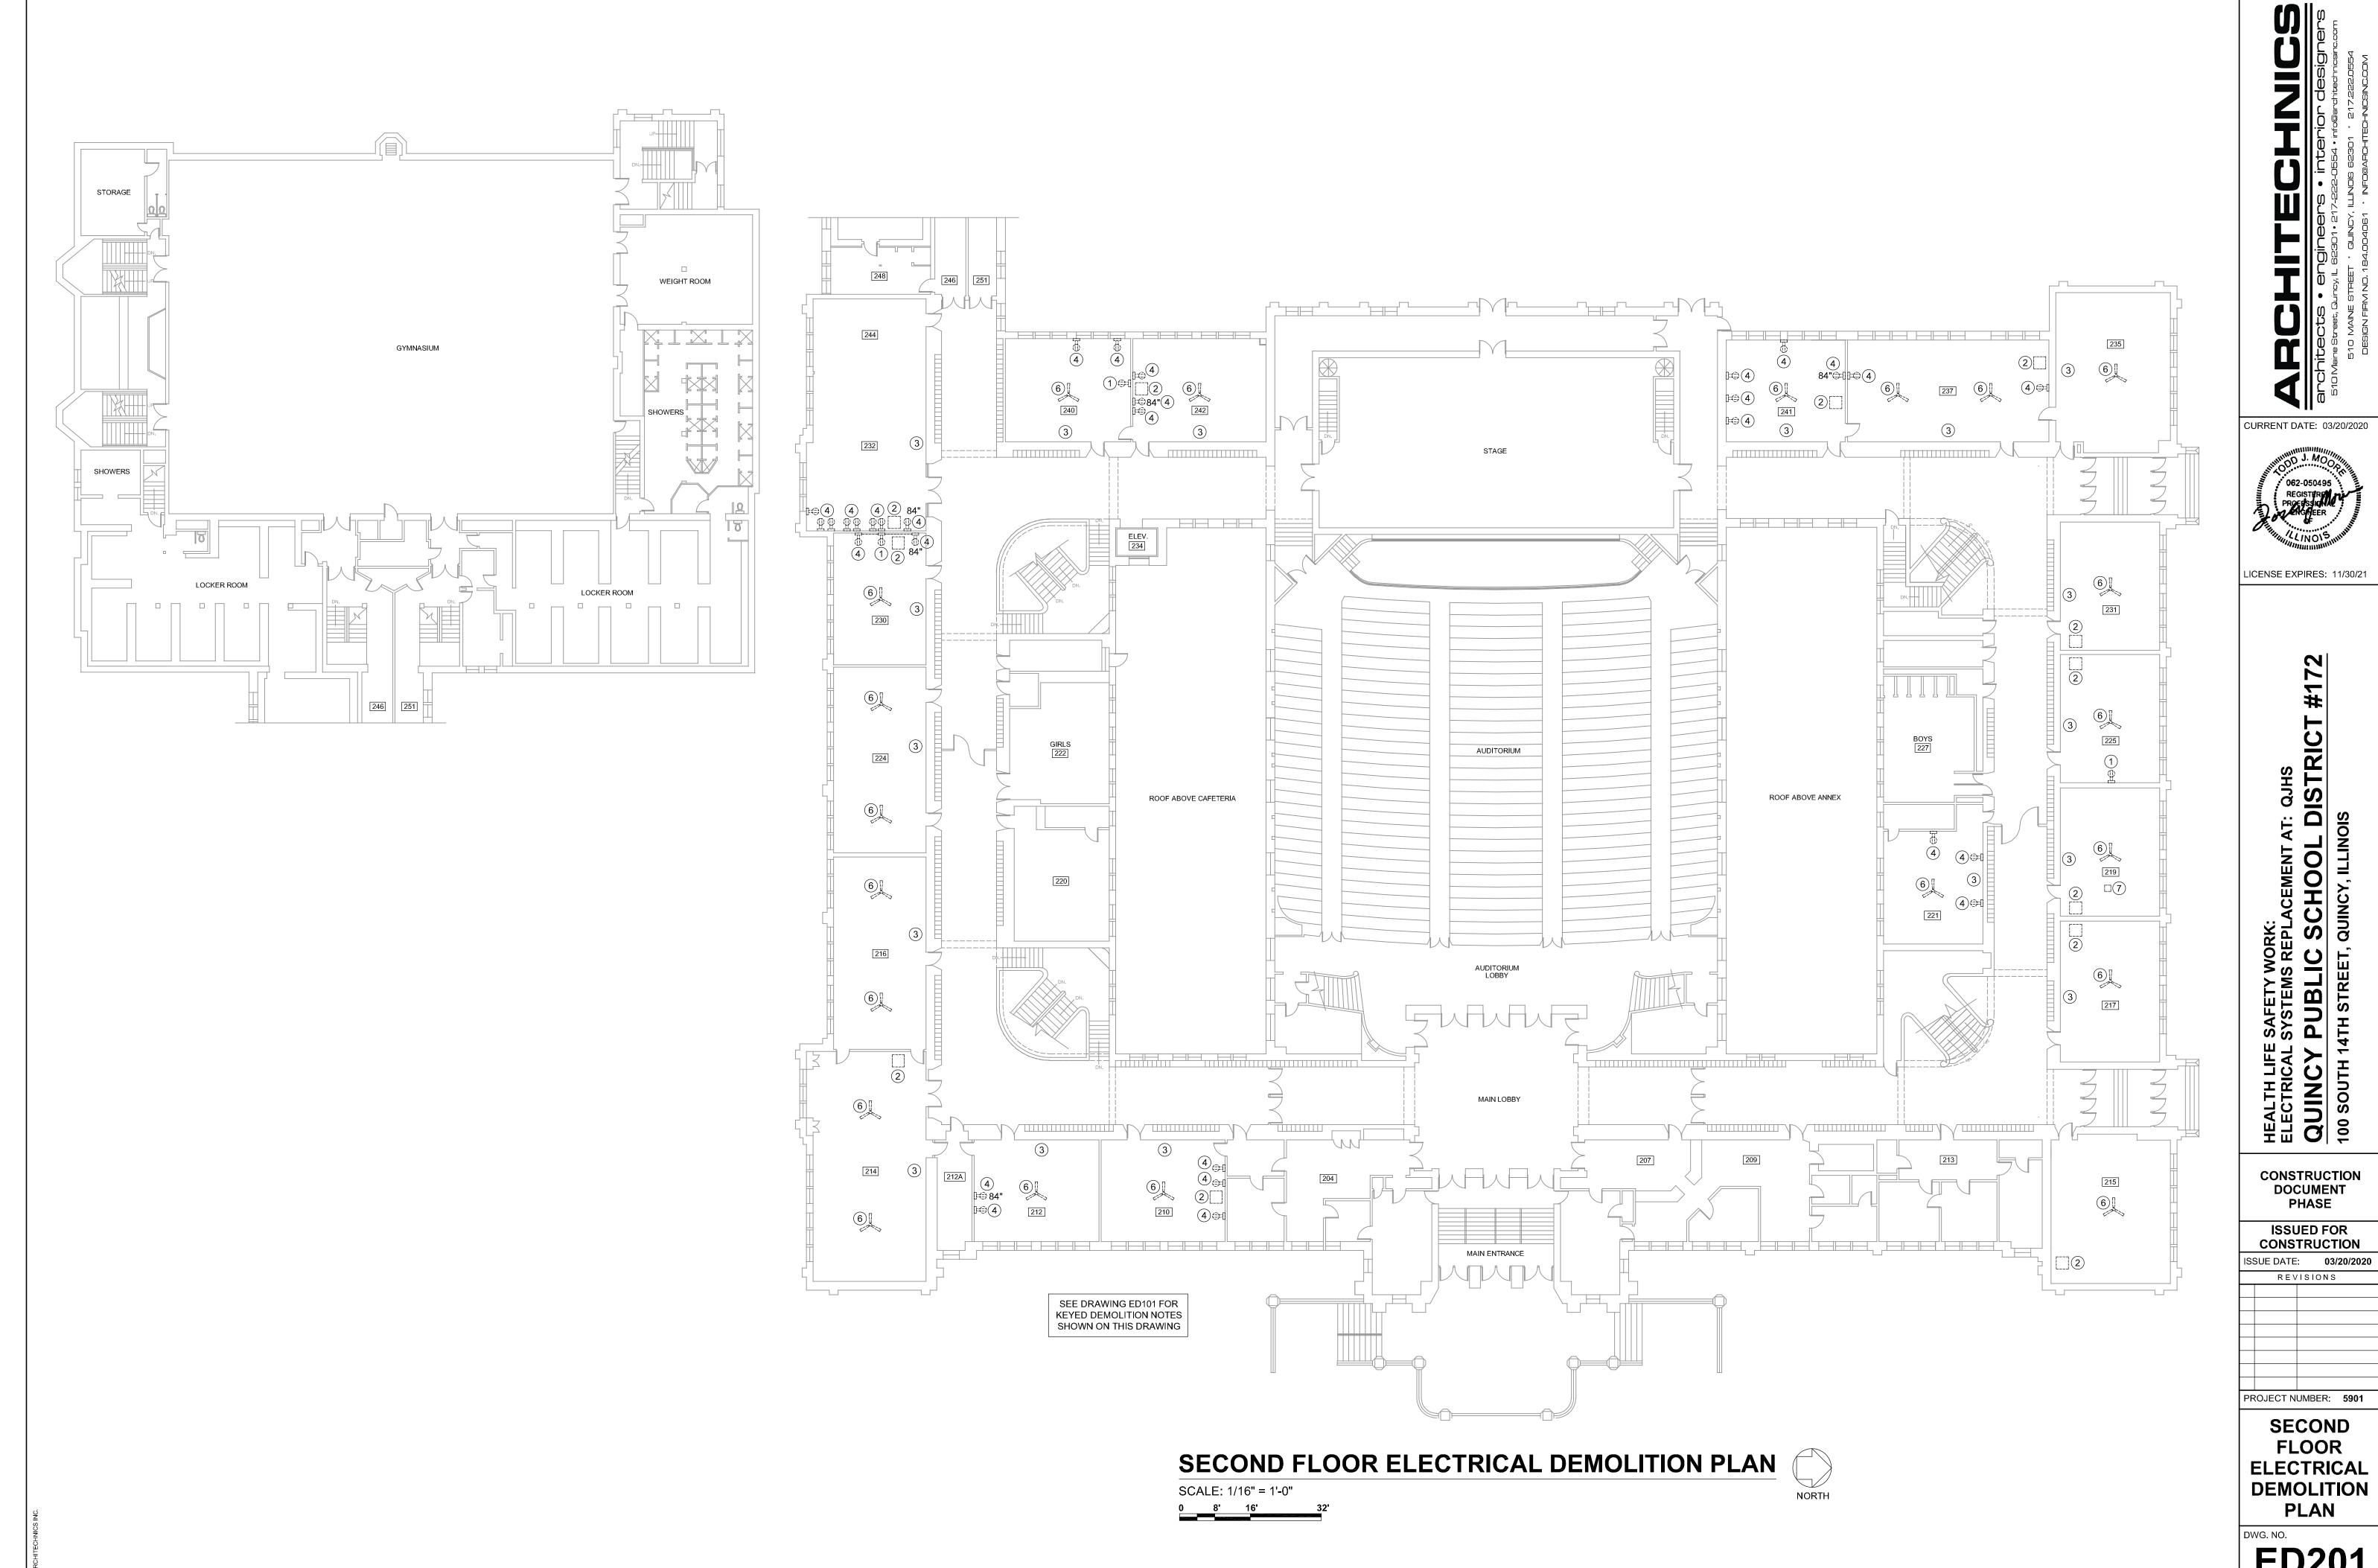


CURRENT DATE: 03/20/2020

DWG. NO. **ED201** 

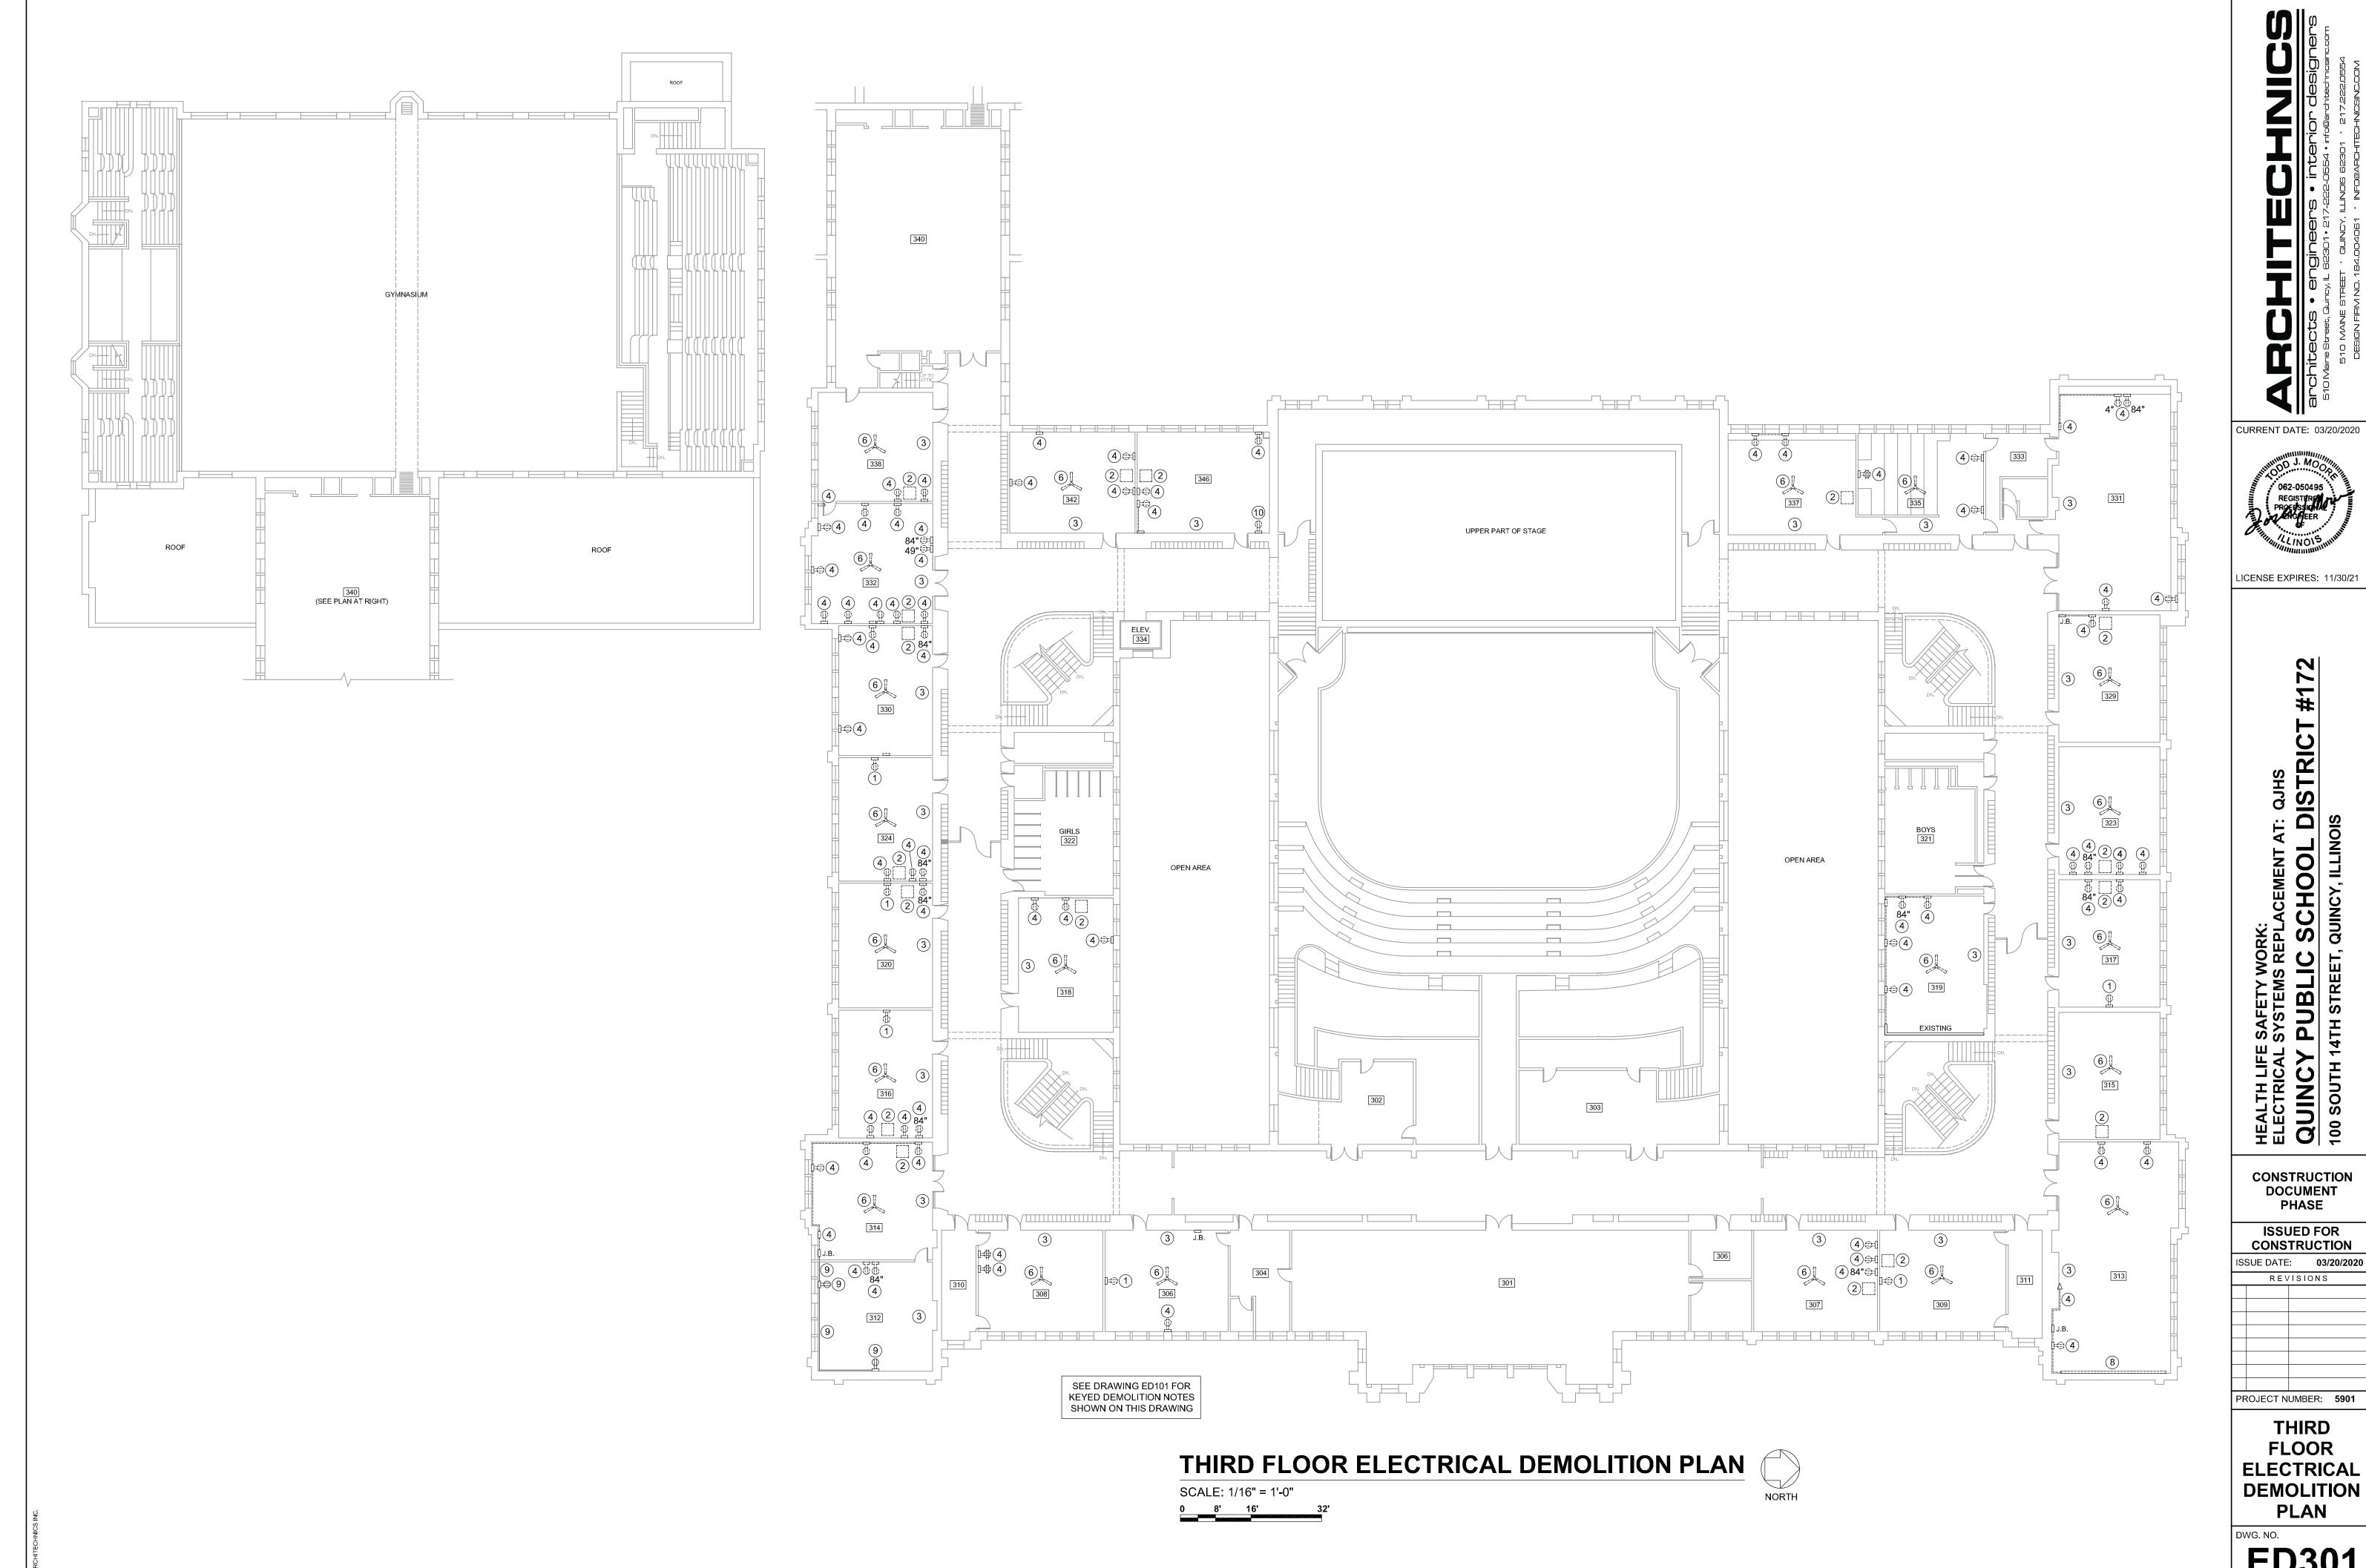

ISSUED FOR CONSTRUCTION

**ED301** 

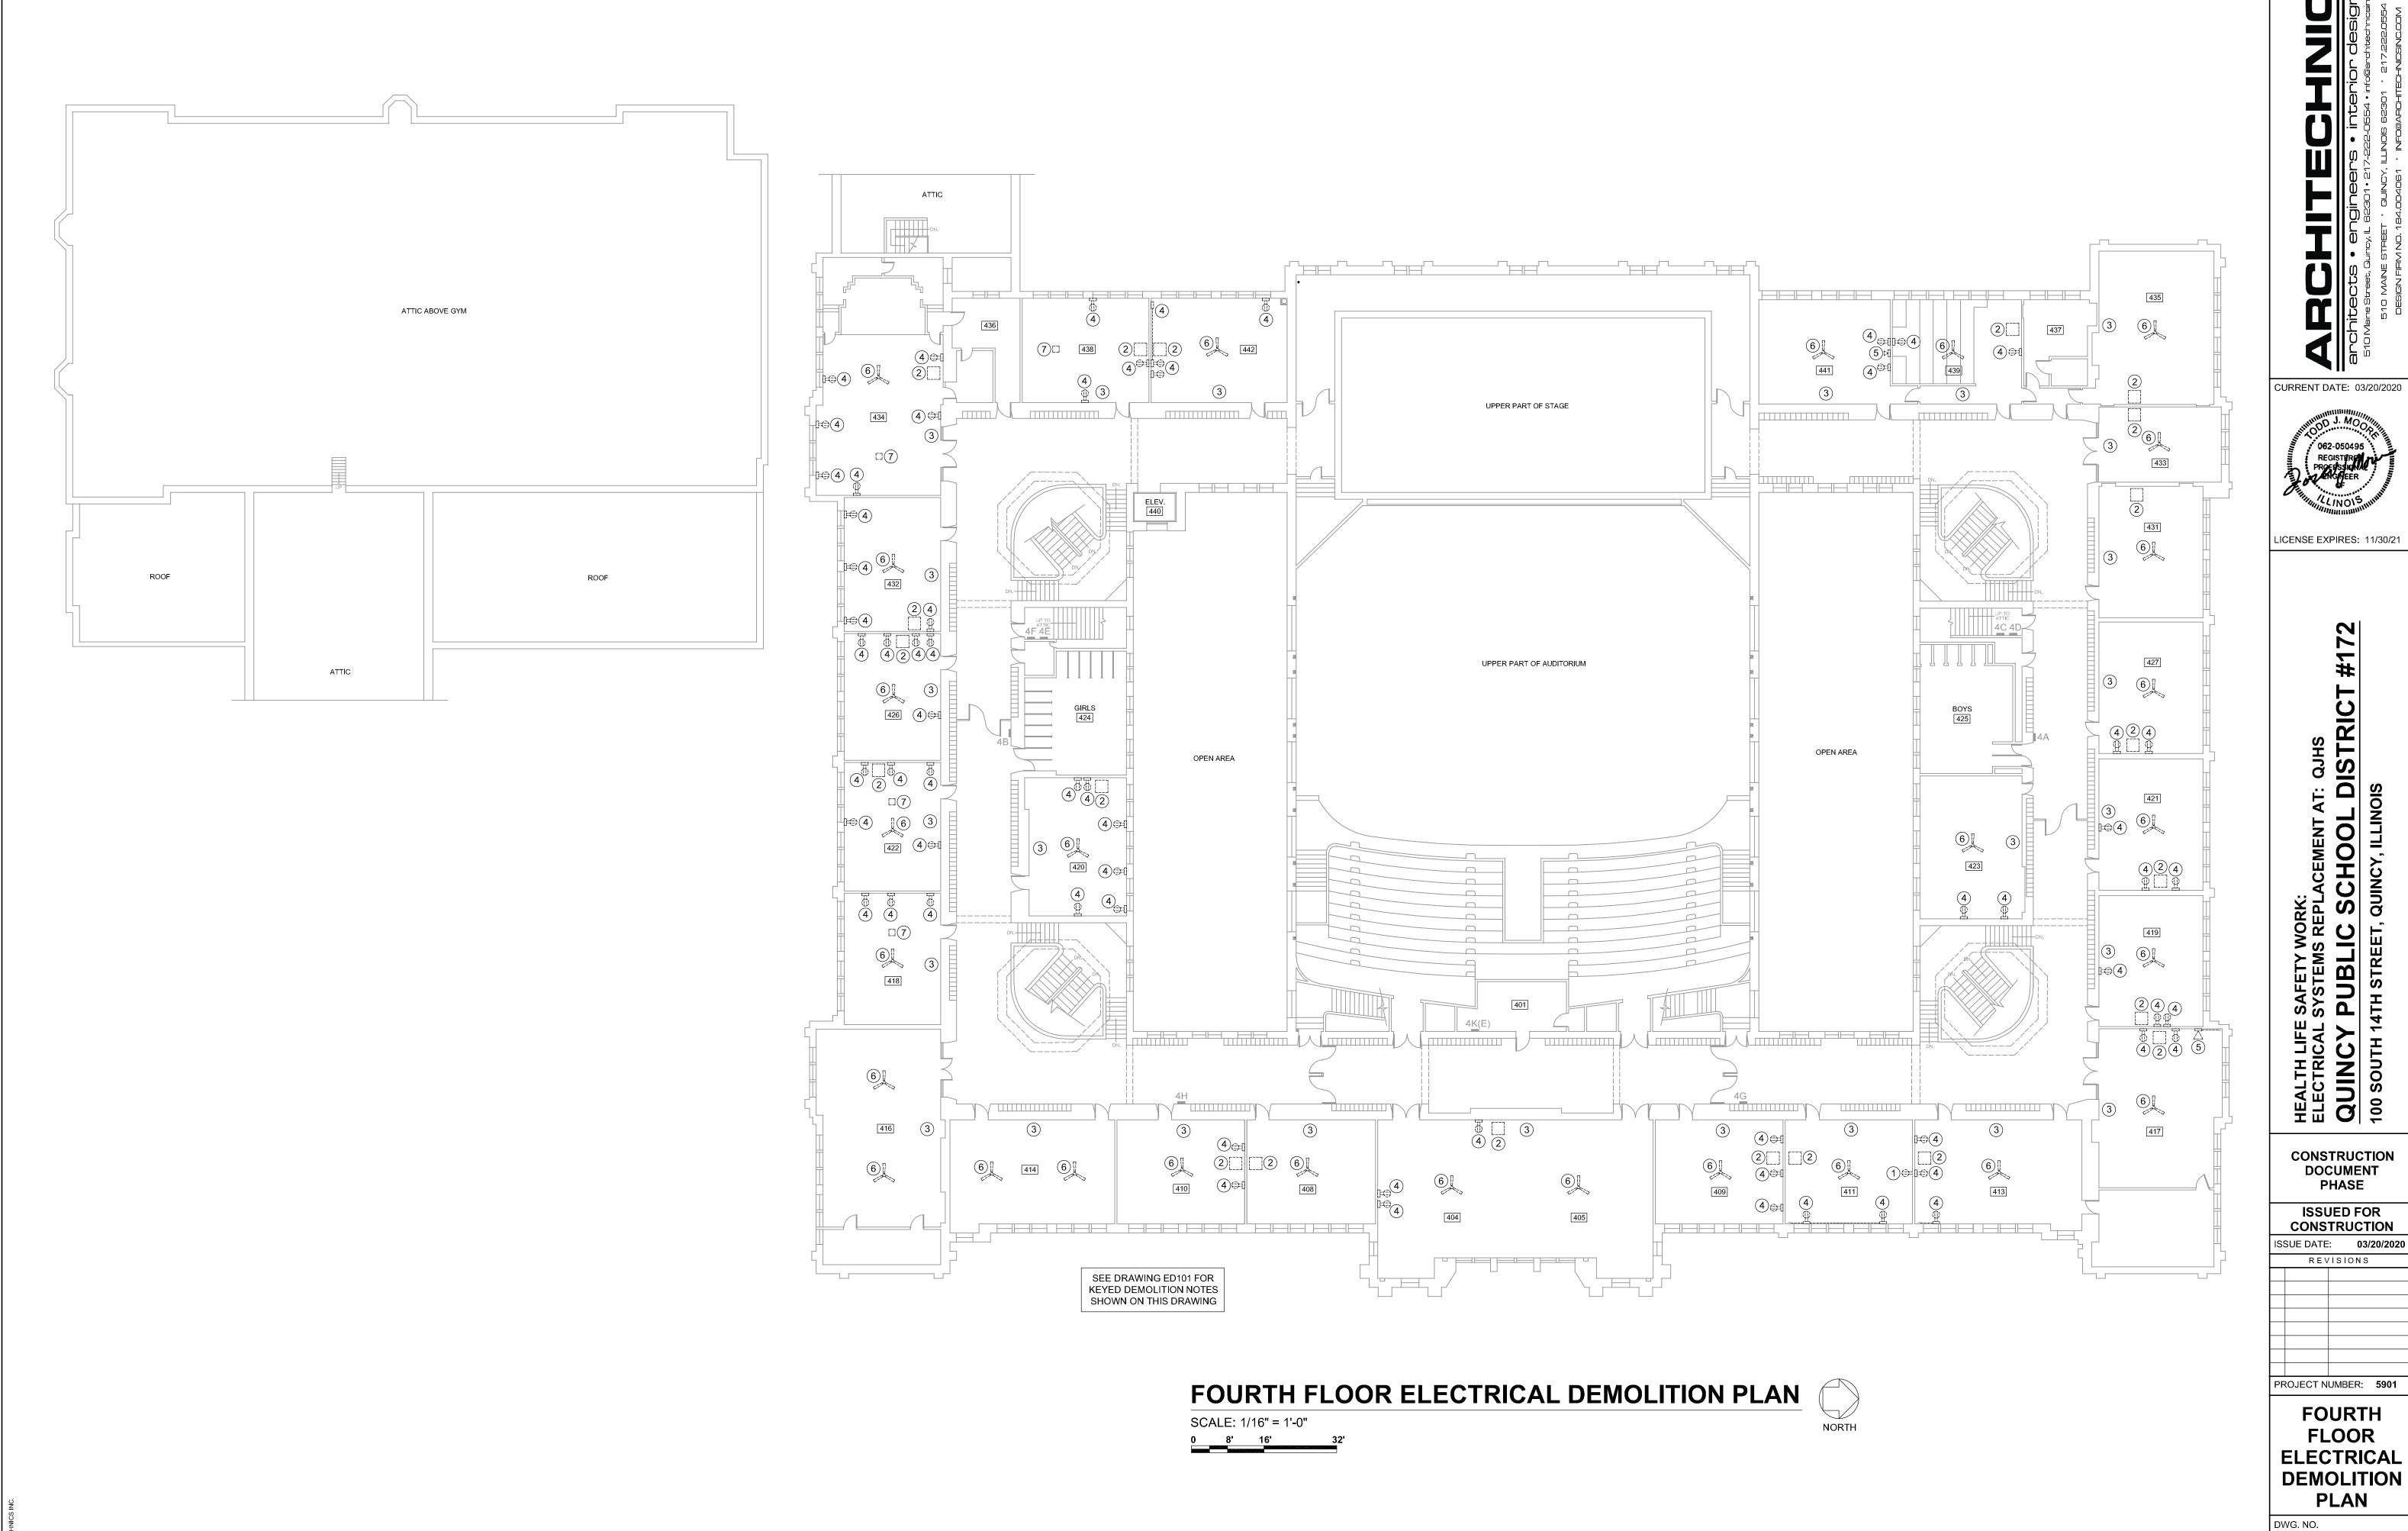

LICENSE EXPIRES: 11/30/21

CONSTRUCTION DOCUMENT

ISSUED FOR CONSTRUCTION ISSUE DATE: 03/20/2020


REVISIONS


**FOURTH FLOOR ELECTRICAL DEMOLITION** PLAN

DWG. NO. **ED401** 

#### **ELECTRICAL GENERAL NOTES**

- 1. ARCHITECHNICS ASSUMES NO RESPONSIBILITY AND CANNOT BE HELD LIABLE FOR THE ACCURACY OF EXISTING CONSTRUCTION DRAWINGS, PLANS, AND SPECIFICATIONS FOR THE EXISTING BUILDING.
- 2. ARCHITECHNICS DOES NOT GUARANTEE OR REPRESENT THAT THESE DRAWINGS ARE ACCURATE OR REPRESENT THE ACTUAL CONDITION OF THE EXISTING BUILDING AT THIS TIME.
- MANY DECISIONS CONCERNING THE NEW CONSTRUCTION FOR THIS PROJECT USED THE EXISTING PLANS AND SPECIFICATIONS FOR THE EXISTING BUILDING AS A BASIS FOR THE NEW WORK. MUCH OF THIS WORK IS COVERED UP OR CONCEALED BEHIND EXISTING CONSTRUCTION AND IS NOT AVAILABLE FOR VERIFICATION. ONLY AT THE TIME OF ACTUAL DEMOLITION WORK WILL MANY OF THESE CONDITIONS BE VERIFIED.
- 4. ARCHITECHNICS CANNOT ASSUME RESPONSIBILITY FOR ANY VARIANCE OR OMISSIONS BETWEEN THESE DRAWINGS AND THE ACTUAL CONDITIONS AS THEY EXIST TODAY.
- 5. CHANGES OR IMPROVEMENTS MAY BE REQUIRED BY THE A/E. THE A/E RESERVES THE RIGHT TO MAKE SUCH CHANGES OR IMPROVEMENTS AS NECESSITATED BY THE PROJECT FOR COMPLETE COMPLIANCE WITH STATE, LOCAL, FEDERAL CODES, AND REGULATIONS. CHANGES MADE BY THE CONTRACTOR TO THE WORK RELATED TO THESE DRAWINGS, SHALL BE PRE-APPROVED BY THE A/E, IN WRITING, ANY UNAUTHORIZED CHANGES SHALL RELIEVE THE A/E FROM LIABILITIES RESULTING FROM SAID CHANGES. CHANGES THAT ARE DULY AUTHORIZED BY THE A/E TO THESE DRAWINGS SHALL BE IN WRITING, SUCH AS CLARIFICATIONS, ADDENDA, AND/OR CONTRACT CHANGE ORDERS. FIELD DIRECTIVES SHALL NOT BECOME AUTHORIZED UNTIL APPROVAL IS OBTAINED FROM THE A/E IN WRITING, AND DOCUMENTED SUCH.
- 6. EACH CONTRACTOR IS RESPONSIBLE FOR SITE SAFETY, AND SHALL FOLLOW SAFETY RULES AND CONDITIONS FOR CONTRACTORS.
- 7. INSTALLATIONS WHICH INCLUDE ELECTRICAL FIXTURES, DEVICES, CONDUIT, SWITCHES, PANELS, HANGERS, WIRE, CABLE, STANDARDS, ETC., MUST BE ENTIRELY SUITABLE FOR TEMPERATURES, HUMIDITY, DAMP AREAS, VOLTAGE, FREQUENCY, AND ALL INSTALLATION CONDITIONS ENCOUNTERED.
- 8. INSTALLATION MUST BE ENTIRELY SAFE IN EVERY RESPECT, AND MUST NOT CREATE ANY CONDITIONS OF ANY KIND WHICH WILL BE HARMFUL TO ANY OCCUPANT OF THE BUILDING. IF CONTRACTOR BELIEVES THAT INSTALLATION WILL NOT BE SAFE FOR ALL PEOPLE, HE/SHE SHALL SO REPORT IN WRITING TO A/E BEFORE ANY EQUIPMENT IS PURCHASED OR WORK IS INSTALLED, GIVING EXACT RECOMMENDATIONS, AND REASONS FOR THEM.
- 9. PROVIDE TEMPORARY POWER AND LIGHTING FOR ALL AREAS OF THE BUILDING UNTIL PERMANENT POWER IS ENERGIZED AND AUTHORIZED FOR USE.
- 10. GROUNDING SHALL BE IN STRICT ACCORDANCE WITH THE LATEST EDITION OF THE NATIONAL ELECTRICAL CODE (NEC). EQUIPMENT GROUNDING CONDUCTORS SHALL BE PULLED WITH ALL BRANCH CIRCUITS. CONDUIT SHALL NOT BE USED AS A GROUND UNLESS NOTED OTHERWISE.
- 11. INSTALLATION OF ELECTRICAL DEVICES SHALL BE COORDINATED WITH OTHER TRADES AS NECESSARY TO PREVENT ANY CONFLICTS DURING CONSTRUCTION.
- 12. PATCH HOLES AND DAMAGE TO WALLS, FLOORS, ROOFS, ETC. AS A RESULT OF NEW ELECTRICAL CONSTRUCTION WORK. MATCH ORIGINAL FINISHES OR SURFACES AS CLOSE AS POSSIBLE AS APPROVED BY ARCHITECT OR OWNER'S REPRESENTATIVE.
- 13. LOW VOLTAGE CONDUIT, JUNCTION BOXES, AND CABLING SHALL BE INSTALLED BY THE ELECTRICAL CONTRACTOR. WHERE PHONE/DATA OUTLET LOCATIONS ARE INDICATED, INSTALL 1" EMT FROM OUTLET BOX (4" x 4" x 1-1/2" MIN.) OR SURFACE RACEWAY TO ABOVE S.A.T. CEILING, SEE DETAIL 1/E000.
- 14. FURNISH AND INSTALL ALL LIGHTING FIXTURES COMPLETE WITH LAMPS IN ACCORDANCE WITH THE LIGHTING FIXTURE SCHEDULE SHOWN ON THE DRAWINGS. ALL UNITS SHALL BE COMPLETE WITH SUSPENSION ACCESSORIES, CANOPIES, SOCKETS, LOUVERS, FRAMES, AND ROUGH-IN BOXES, WIRED AND ASSEMBLED TO FURNISH A COMPLETE WORKABLE SYSTEM.
- 15. ELECTRICAL CONTRACTOR SHALL FURNISH AND INSTALL ALL MATERIALS, ACCESSORIES, TOOLS, EQUIPMENT, TRANSPORTATION, LABOR, SERVICES AND OPERATIONS NECESSARY FOR A COMPLETE ELECTRICAL SYSTEM. MATERIALS MUST BE NEW, IN FIRST CLASS CONDITION.
- 16. RACEWAYS SHALL BE INSTALLED TO CLEAR MAJOR DUCTWORK AND PIPING. CONDUIT SHALL BE SEPARATELY HUNG AND ANCHORED, FREE TO EXPAND AND CONTRACT QUIETLY, WITHOUT IMPOSING STRAINS ON STRUCTURE, DEVICES, AND EQUIPMENT. CONDUIT SHALL BE RUN PARALLEL OR PERPENDICULAR TO BUILDING LINES.
- 17. CONDUIT PENETRATIONS THRU INTERIOR WALLS SHALL UTILIZE MANUFACTURED PENETRATION DEVICES, SEE DETAIL 2/E000.
- 18. SEE REFLECTED CEILING PLANS FOR CEILING GRID LAYOUT AND FINAL LOCATION OF LIGHTING FIXTURES AND CEILING MOUNTED DEVICES.

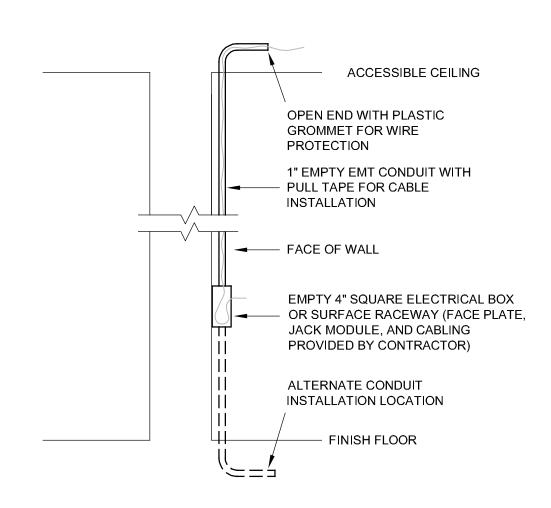

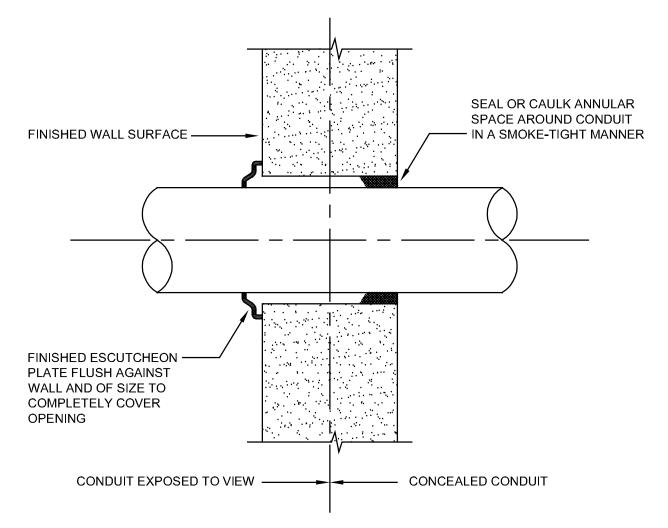





#### **SYMBOLS**

WALL OR CEILING MOUNTED STROBE
WALL MOUNTED MANUAL STATION
WALL OR CEILING MOUNTED HORN-STROBE
CEILING MOUNTED SMOKE DETECTOR
B PROJECTED BEAM SMOKE DETECTOR
CEILING MOUNTED HEAT DETECTOR
M MAGNETIC DOOR HOLDER
FACP FIRE ALARM CONTROL PANEL
FAAP FIRE ALARM ANNUNCIATOR PANEL

architects • engineers • ir 510 Maine Street, Quincy, IL 62301 • 217-222-09 510 MAINE STREET • QUINCY, ILLINOIS

CURRENT DATE: 03/20/2020



LICENSE EXPIRES: 11/30/21

ACEMENT AT: QJHS SHOOL DISTRICT #172

> CONSTRUCTION DOCUMENT PHASE

ISSUED FOR CONSTRUCTION

ISSUE DATE: 03/20/2020

REVISIONS

PROJECT NUMBER: 5901

COMMON ELECTRICAL WORK

DWG. NO.




- 1) INSTALL NEW WIREMOLD 4000 SERIES SURFACE RACEWAY WITH RECEPTACLES AS SHOWN (SEE PLAN FOR APPROXIMATE RACEWAY LENGTH). FEED POWER FROM EXISTING JUNCTION BOX IN ROOM UNLESS SHOWN OTHERWISE. EXTEND 1" EXPOSED CONDUIT FROM RACEWAY TO ABOVE CEILING OR THRU FLOOR TO CEILING SPACE BELOW FOR FUTURE DATA BY OTHERS, SEE DETAIL 1/E000.
- 2 EXTEND NEW SURFACE CONDUIT AND CONDUCTORS FROM EXISTING SURFACE RACEWAY TO FEED NEW SURFACE RECEPTACLES OR SURFACE RACEWAY AS
- 3 EXTEND NEW SURFACE CONDUIT AND CONDUCTORS FROM NEW SURFACE RACEWAY TO FEED NEW SURFACE RECEPTACLES AS SHOWN.
- 4 EXTEND NEW SURFACE CONDUIT AND CONDUCTORS FROM EXISTING JUNCTION BOX NEAR CEILING TO FEED NEW SURFACE RECEPTACLES AS SHOWN.
- 5 INSTALL NEW RECEPTACLES AS SHOWN IN EXISTING RACEWAY. FEED POWER FROM EXISTING JUNCTION BOX IN ROOM UNLESS SHOWN OTHERWISE.
- 6 MODIFY EXISTING DATA CONDUIT AND INSTALL NEW DATA OUTLET TO NEW
- 7 INSTALL NEW SURFACE MOUNTED RECEPTACLE ON WALL ABOVE EXISTING SMARTBOARD SCREEN FOR SMARTBOARD PROJECTOR POWER (VERIFY FINAL ATION). FEED FROM NEARBY LOCATION IN ROOM WITH OWNER PRIOR TO INSTALLATION). FEED FRON NEARBY RECEPTACLE POWER CIRCUIT.
- 8 INSTALL 15' CAT-6 CABLE DROP INTO ROOM ABOVE NEW CEILING NEAR DOOR FOR FUTURE TELEPHONE. TELEPHONE PROVIDED AND INSTALLED BY OWNER.
- 9 INSTALL 15' CAT-6 CABLE DROP INTO ROOM ABOVE NEW CEILING NEAR DOOR FOR FUTURE WIRELESS ACCESS POINT. WIRELESS ACCESS POINT PROVIDED AND INSTALLED BY OWNER.
- (10) EXISTING JUNCTION BOX (VERIFY EXACT LOCATION).
- 11 NEW JUNCTION BOX.
- RE-FEED EXISTING JUNCTION BOX SERVING EXISTING RECEPTACLES IN ADJACENT
- 13) NEW SURGE PROTECTED RECEPTACLE (VERIFY FINAL LOCATION WITH OWNER), CONNECT TO EXISTING NEARBY DEDICATED 120V CIRCUIT.

LOWER GYMNASIUM

160


WOOD SHOP

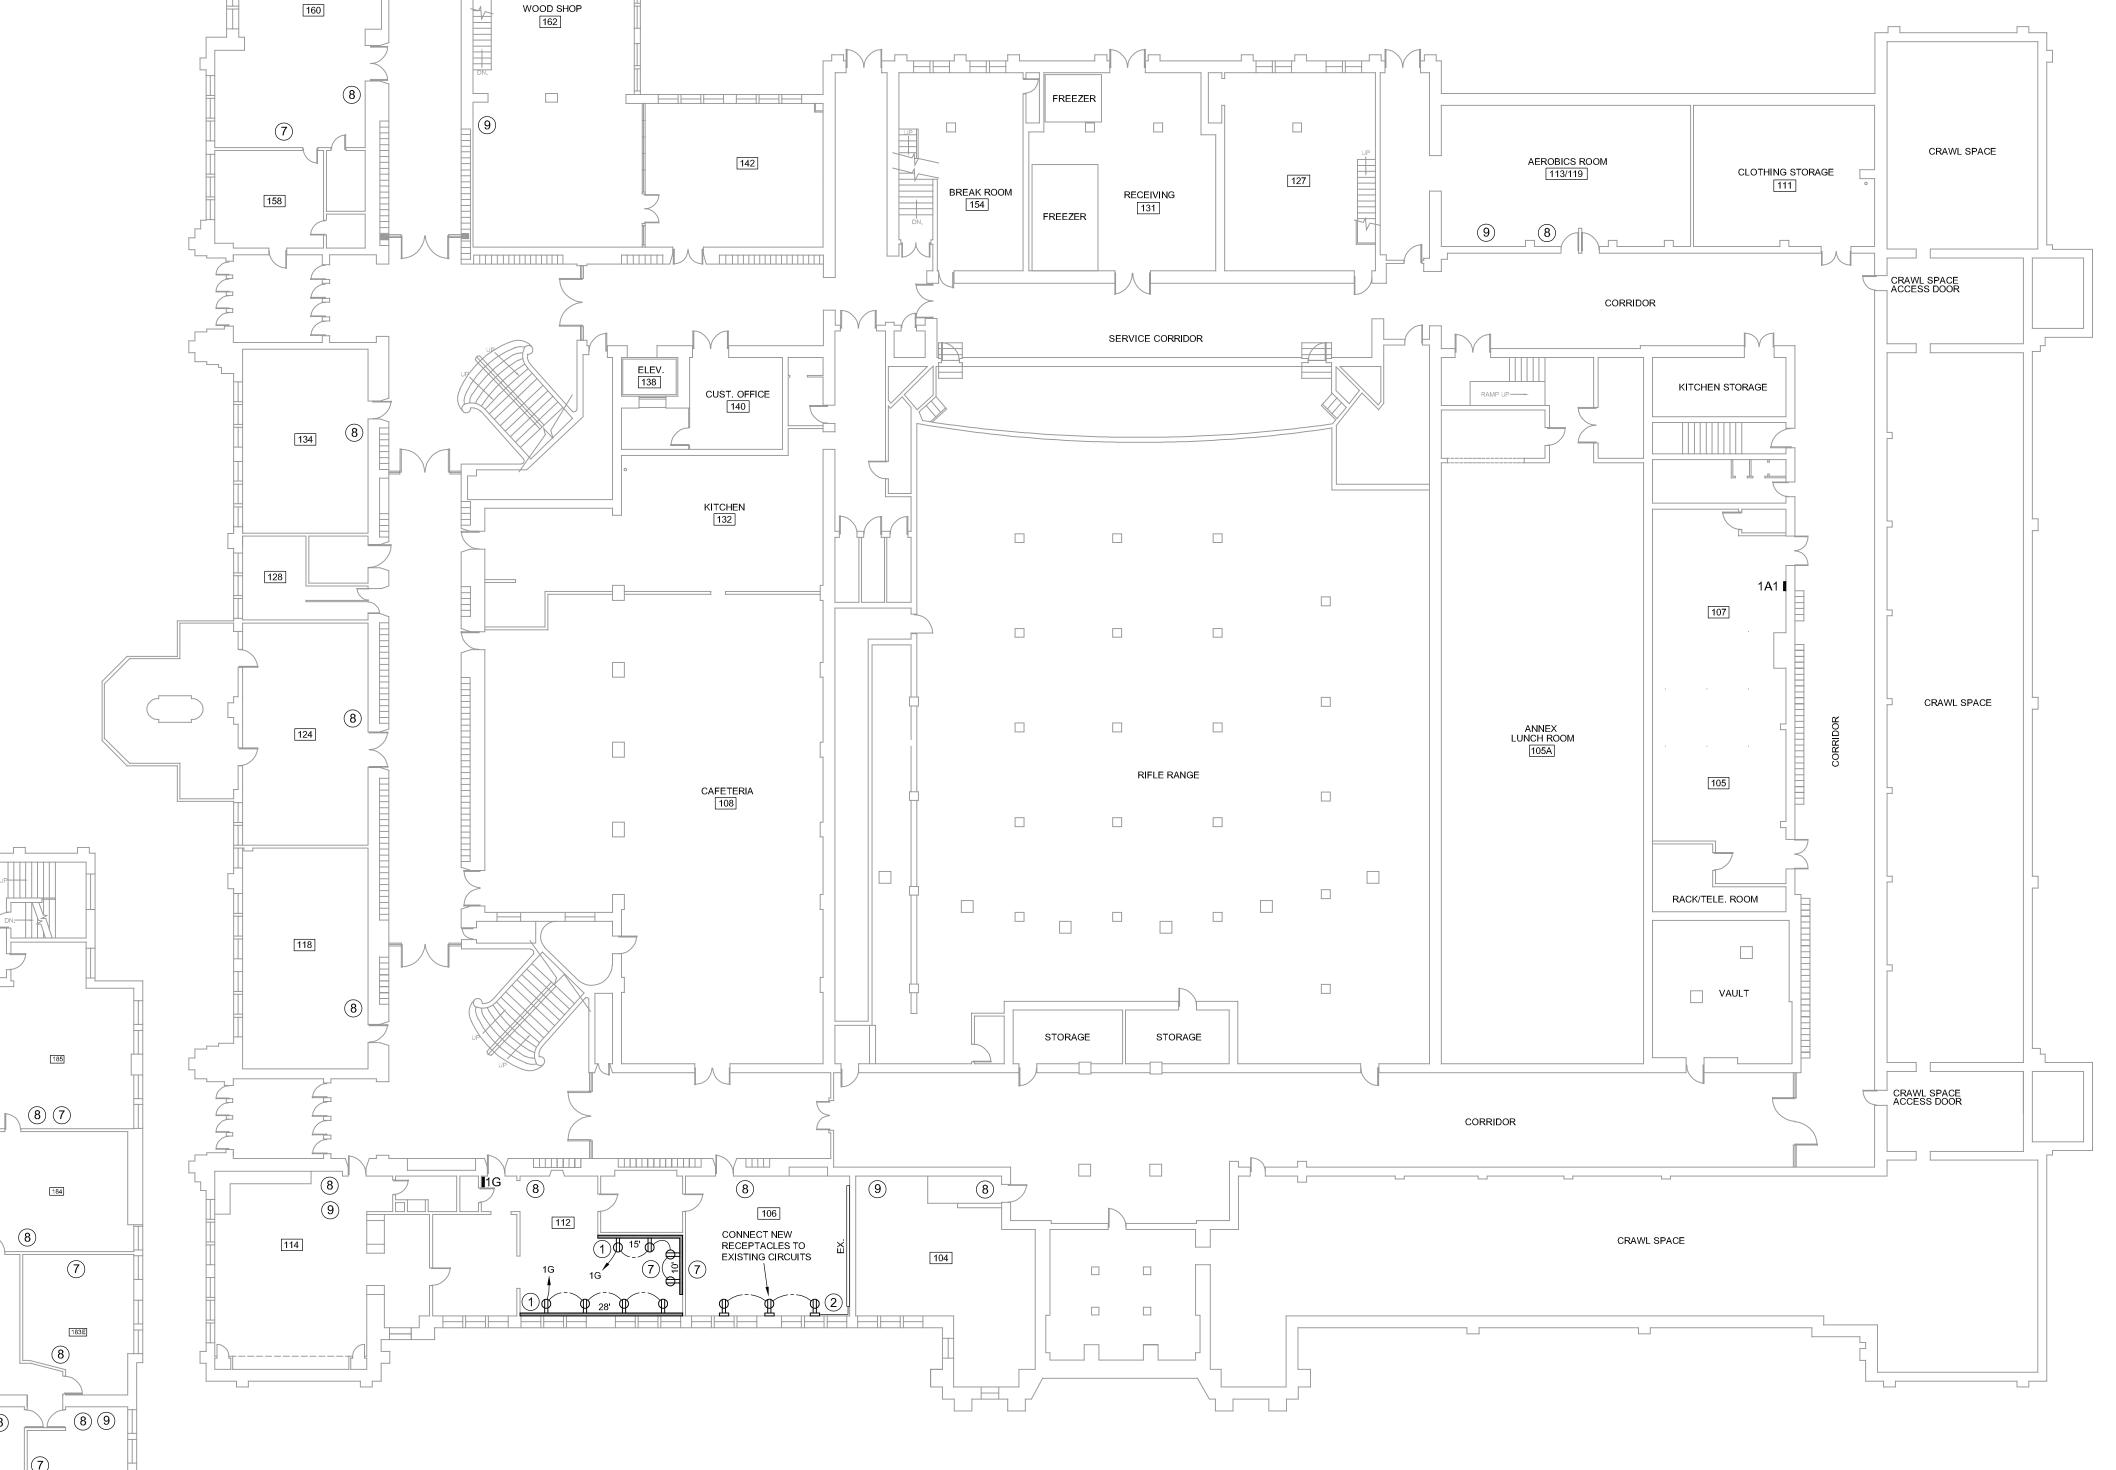

#### **GENERAL NOTES**


- . SEE DRAWING E101 FOR KEYED POWER NOTES SHOWN ON THIS DRAWING.
- 2. INSTALL 3/4" THICK x 6" WIDE PLYWOOD SHIMS AT 24" CENTERS ALONG WALL WHERE REQUIRED TO ALLOW FOR SURFACE RACEWAY CLEARANCE AROUND EXISTING CLASSROOM SPEAKER CONDUIT.
- 3. EXISTING CIRCUIT INFORMATION SHOWN IN CIRCUIT SCHEDULE IS FOR INFORMATIONAL PURPOSES ONLY, VERIFY EXISTING CIRCUITS AVAILABLE FOR NEW RECEPTACLE POWER PRIOR TO INSTALLATION. REARRANGE AND CONNECT OR RECONNECT EXISTING CIRCUITS IN PANELS AS REQUIRED.

## FIRST FLOOR POWER PLAN

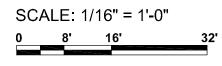



CURRENT DATE: 03/20/2020

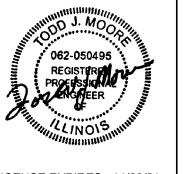

LICENSE EXPIRES: 11/30/21

T: QJHS
DISTRICT

CONSTRUCTION

DOCUMENT PHASE

**ISSUED FOR** 

CONSTRUCTION ISSUE DATE: 03/20/2020 REVISIONS

PROJECT NUMBER: 5901 **FIRST FLOOR** 

**POWER PLAN** 

## KEYED NOTES (TYPICAL FOR ALL LIGHTING PLANS)


- INSTALL NEW LED LAY-IN LIGHT FIXTURE, EQUAL TO RAB CAT. NO. T34-2X4-40N/D10/LCLC/W, IN NEW SUSPENDED ACOUSTIC CEILING. MODIFY EXISTING LIGHT FIXTURE CIRCUIT AND EXTEND POWER TO SERVE NEW FIXTURES AS REQUIRED. ABANDON EXISTING SURFACE MOUNTED FIXTURES IN PLACE.
- (2) INSTALL NEW LED LAY-IN LIGHT FIXTURE, EQUAL TO RAB CAT. NO. T34-2X4-40N/D10, IN NEW SUSPENDED ACOUSTIC CEILING. MODIFY AND EXTEND EXISTING LIGHT FIXTURE POWER AND SWITCH CIRCUITS AS REQUIRED TO SERVE NEW FIXTURES. ABANDON EXISTING SURFACE MOUNTED FIXTURES IN PLACE.
- (3) REPLACE EXISTING LAY-IN LIGHT FIXTURE WITH NEW LED LAY-IN LIGHT FIXTURE, EQUAL TO RAB CAT. NO. T34-2X4-40N/D10/LCLC/W, IN EXISTING SUSPENDED ACOUSTIC CEILING. CONNECT TO EXISTING LIGHT FIXTURE POWER CIRCUIT.
- (4) REPLACE EXISTING LAY-IN LIGHT FIXTURE WITH NEW LED LAY-IN LIGHT FIXTURE, EQUAL TO RAB CAT. NO. T34-2X4-40N/D10, IN EXISTING SUSPENDED ACOUSTIC CEILING. CONNECT TO EXISTING LIGHT FIXTURE POWER AND SWITCH CIRCUITS.
- (5) REPLACE EXISTING SURFACE MOUNTED LIGHT FIXTURE WITH NEW LED SURFACE MOUNTED LIGHT FIXTURE, EQUAL TO RAB CAT. NO. T34-2X4-40N/D10/ LCLC/W/SMKPANEL2X4. CONNECT TO EXISTING LIGHT FIXTURE POWER CIRCUIT.
- (6) REPLACE EXISTING SURFACE MOUNTED LIGHT FIXTURE WITH NEW LED SURFACE MOUNTED LIGHT FIXTURE, EQUAL TO RAB CAT. NO. T34-2X4-40N/D10/ SMKPANEL2X4. CONNECT TO EXISTING LIGHT FIXTURE POWER AND SWITCH
- (7) REPLACE EXISTING PENDANT MOUNTED LIGHT WITH NEW LED PENDANT MOUNTED LIGHT FIXTURE, EQUAL TO RAB CAT. NO. EZPAN2X4-40N/PMKEZPAN2X4 CONNECT TO EXISTING LIGHT FIXTURE POWER AND SWITCH CIRCUITS.
- (8) REPLACE EXISTING SURFACE MOUNTED LIGHT WITH NEW LED SURFACE MOUNTED LIGHT FIXTURE, EQUAL TO RAB CAT. NO. T34-1X4-40N/D10/SMKPANEL1X4. CONNECT TO EXISTING LIGHT FIXTURE POWER AND SWITCH CIRCUITS.
- (9) REPLACE EXISTING PENDANT MOUNTED LIGHT WITH NEW LED PENDANT MOUNTED LIGHT FIXTURE, EQUAL TO RAB CAT. NO. EZPAN1X4-40N-D10/PMKEZPAN1X4 CONNECT TO EXISTING LIGHT FIXTURE POWER AND SWITCH CIRCUITS.
- (10) REMOVE EXISITNG LIGHT SWITCH(ES) AND INSTALL NEW DIMMER SWITCH(ES) TO CONTROL LIGHT FIXTURES IN ROOM AS SHOWN. MODIFY EXISTING WIRING TO SWITCH AS REQUIRED TO PROVIDE 120V POWER TO NEW DIMMER SWITCH(ES).
- (11) RELOCATE EXISTING FIRE ALARM DEVICE TO NEW CEILING. MODIFY AND EXTEND EXISTING CIRCUIT AS REQUIRED.
- (12) RELOCATE EXISTING WIRELESS ACCESS POINT TO NEW CEILING. MODIFY AND EXTEND EXISTING CIRCUIT AS REQUIRED.
- (13) EXISTING SECURITY CAMERA RELOCATED TO NEW CEILING BY OWNER.
- (14) RELOCATE EXISTING EXIT LIGHT TO NEW CEILING. MODIFY AND EXTEND EXISTING CIRCUIT AS REQUIRED.
- (15) RELOCATE EXISTING DOME LIGHT TO NEW CEILING. MODIFY AND EXTEND EXISTING CIRCUIT AS REQUIRED.
- (16) REPLACE EXISTING LAY-IN LIGHT FIXTURE WITH NEW LED LAY-IN LIGHT FIXTURE, EQUAL TO ILP CAT. NO. GH24-180WLED-UNIV-40-FRL-WC, IN EXISTING SUSPENDED ACOUSTIC CEILING. CONNECT TO EXISTING LIGHT FIXTURE POWER AND SWITCH
- (17) RELOCATE EXISTING TRACK LIGHT TO NEW CEILING. MODIFY AND EXTEND EXISTING
- (18) REPLACE EXISTING SURFACE MOUNTED LIGHT FIXTURE AT STAIR LANDING WITH NEW LED SURFACE MOUNTED LIGHT FIXTURE, EQUAL TO RAB CAT. NO. T34-2X4-40N/D10/ SMKPANEL2X4. CONNECT TO EXISTING LIGHT FIXTURE POWER AND SWITCH

LOWER GYMNASIUM

160

**8** 

WOOD SHOP

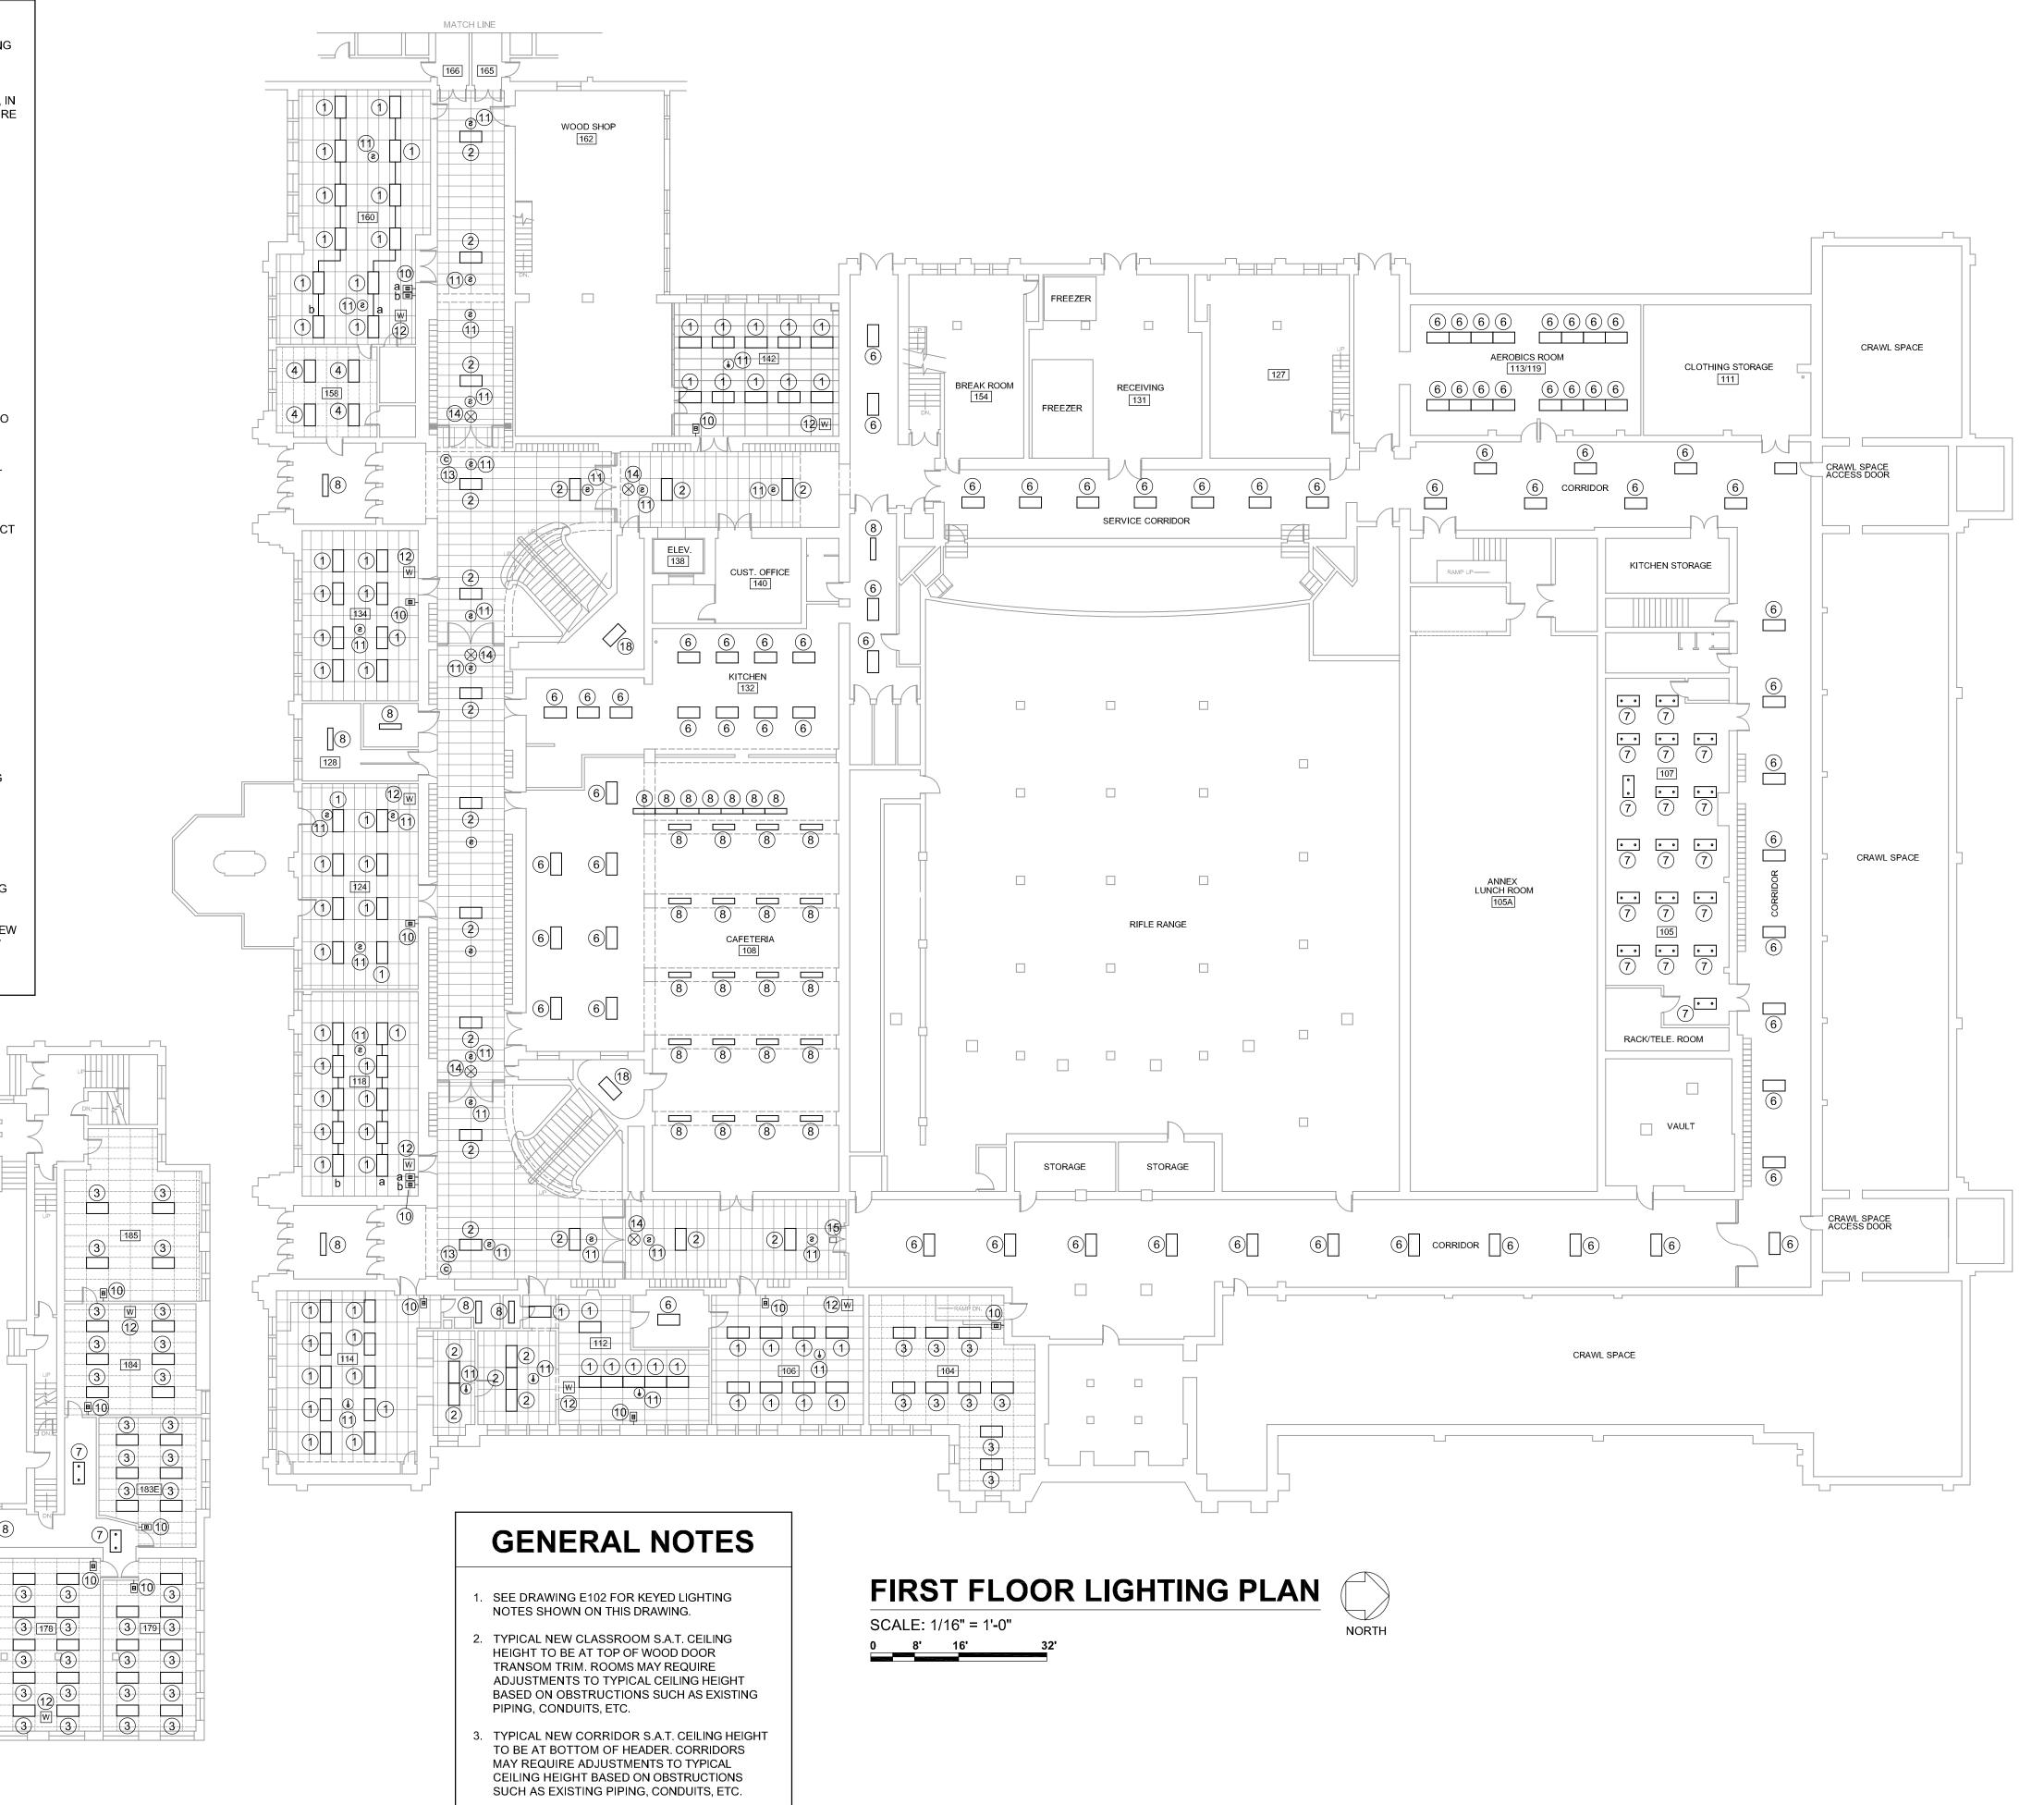

CURRENT DATE: 03/20/2020



LICENSE EXPIRES: 11/30/21

DISTRIC HEALTH LIFE SAFETY WORK:
ELECTRICAL SYSTEMS REPLACE
QUINCY PUBLIC SC
100 SOUTH 14TH STREET, QUIN


CONSTRUCTION DOCUMENT

PHASE **ISSUED FOR** 


CONSTRUCTION ISSUE DATE: 03/20/2020 REVISIONS

PROJECT NUMBER: 5901

**FIRST FLOOR** LIGHTING **PLAN** 

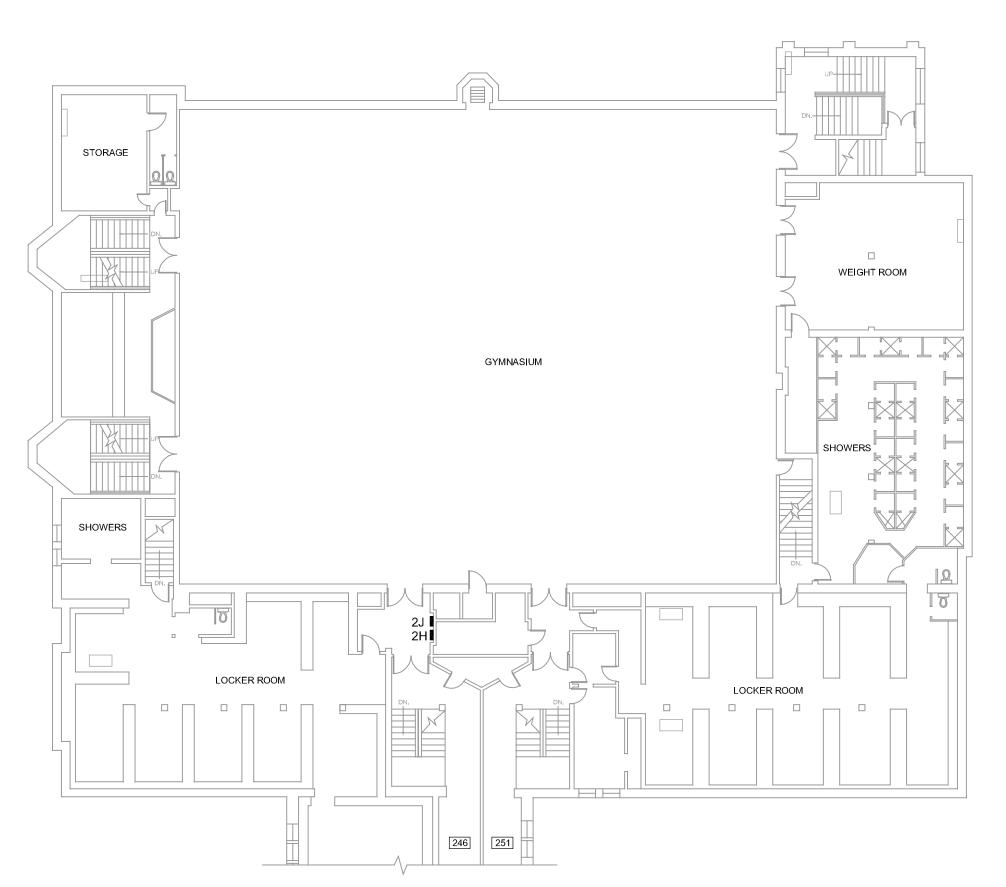

SECOND FLOOR CIRCUIT SCHEDULE				
ROOM	PANEL	CIRCUITS AVAILABLE	REMARKS	
210	1G	NEW CIRCUITS TO BE DETERMINED IN FIELD	INSTALL NEW HOME RUN FROM PANEL 1G ON FIRST FLOOR TO ROOM 210. FEED NEW RECEPTACLES IN NEW SURFACE RACEWAY WITH MINIMUM TWO CIRCUITS FROM PANEL 1G.	
212	2F	EXISTING FORMER A/C CIRCUITS #39, & #41	FEED NEW SURFACE RACEWAY RECEPTACLES FROM AVAILABLE CIRCUITS IN EXISTING ROOM JUNCTION BOX. INSTALL NEUTRAL CONDUCTOR IN EXISTING CONDUIT FROM PANEL 2F.	
219	2D	EXISTING CIRCUITS #5, & #9	FEED NEW RECEPTACLES IN EXISTING SURFACE RACEWAY FROM AVAILABLE CIRCUITS IN EXISTING ROOM	
221	1A1	NEW CIRCUITS TO BE DETERMINED IN FIELD	INSTALL NEW CONDUCTORS IN EXISTING 1/2" CONDUIT RUN FROM PANEL 1A1 ON FIRST FLOOR TO ROOM 221. FEED NEW RECEPTACLES ON WALL AND IN NEW SURFACE RACEWAY WITH TWO CIRCUITS FROM PANEL 1A1.	
225	2D	EXISTING CIRCUITS #2, #4, & #6	FEED NEW SURFACE RACEWAY RECEPTACLES FROM AVAILABLE CIRCUITS IN EXISTING ROOM	
230	2F	NEW CIRCUITS TO BE DETERMINED IN FIELD	INSTALL NEW CONDUCTORS IN EXISTING CONDUIT RUN FROM PANEL 2F TO EXISTING ROOM JUNCTION BOX. FEED NEW RECEPTACLES IN NEW SURFACE RACEWAY WITH TWO CIRCUITS FROM PANEL 2F.	
231	2C	EXISTING CIRCUITS #2, & #12	FEED NEW SURFACE RACEWAY RECEPTACLES FROM AVAILABLE CIRCUITS IN EXISTING SURFACE RACEWAY	
232	2F	NEW CIRCUITS TO BE DETERMINED IN FIELD	INSTALL NEW CONDUCTORS IN EXISTING CONDUIT RUN FROM PANEL 2F TO EXISTING ROOM JUNCTION BOX. FEED NEW RECEPTACLES IN NEW SURFACE RACEWAY WITH TWO CIRCUITS FROM PANEL 2F.	
237	2D	EXISTING CIRCUITS #14, #16, #18, #20, #22, & #24	FEED NEW SURFACE RECEPTACLES FROM AVAILABLE CIRCUITS IN EXISTING SURFACE RACEWAY	
240	2F	NEW CIRCUITS TO BE DETERMINED IN FIELD	FEED NEW SURFACE RACEWAY RECEPTACLES FROM AVAILABLE CIRCUITS IN EXISTING ROOM	
241	2D	EXISTING CIRCUITS #14, #16, #18, #20, #22, & #24	FEED NEW RECEPTACLES ON WALL AND IN NEW SURFACE RACEWAY FROM MINIMUN TWO AVAILABLE CIRCUITS IN JUNCTION BOX IN ROOM	

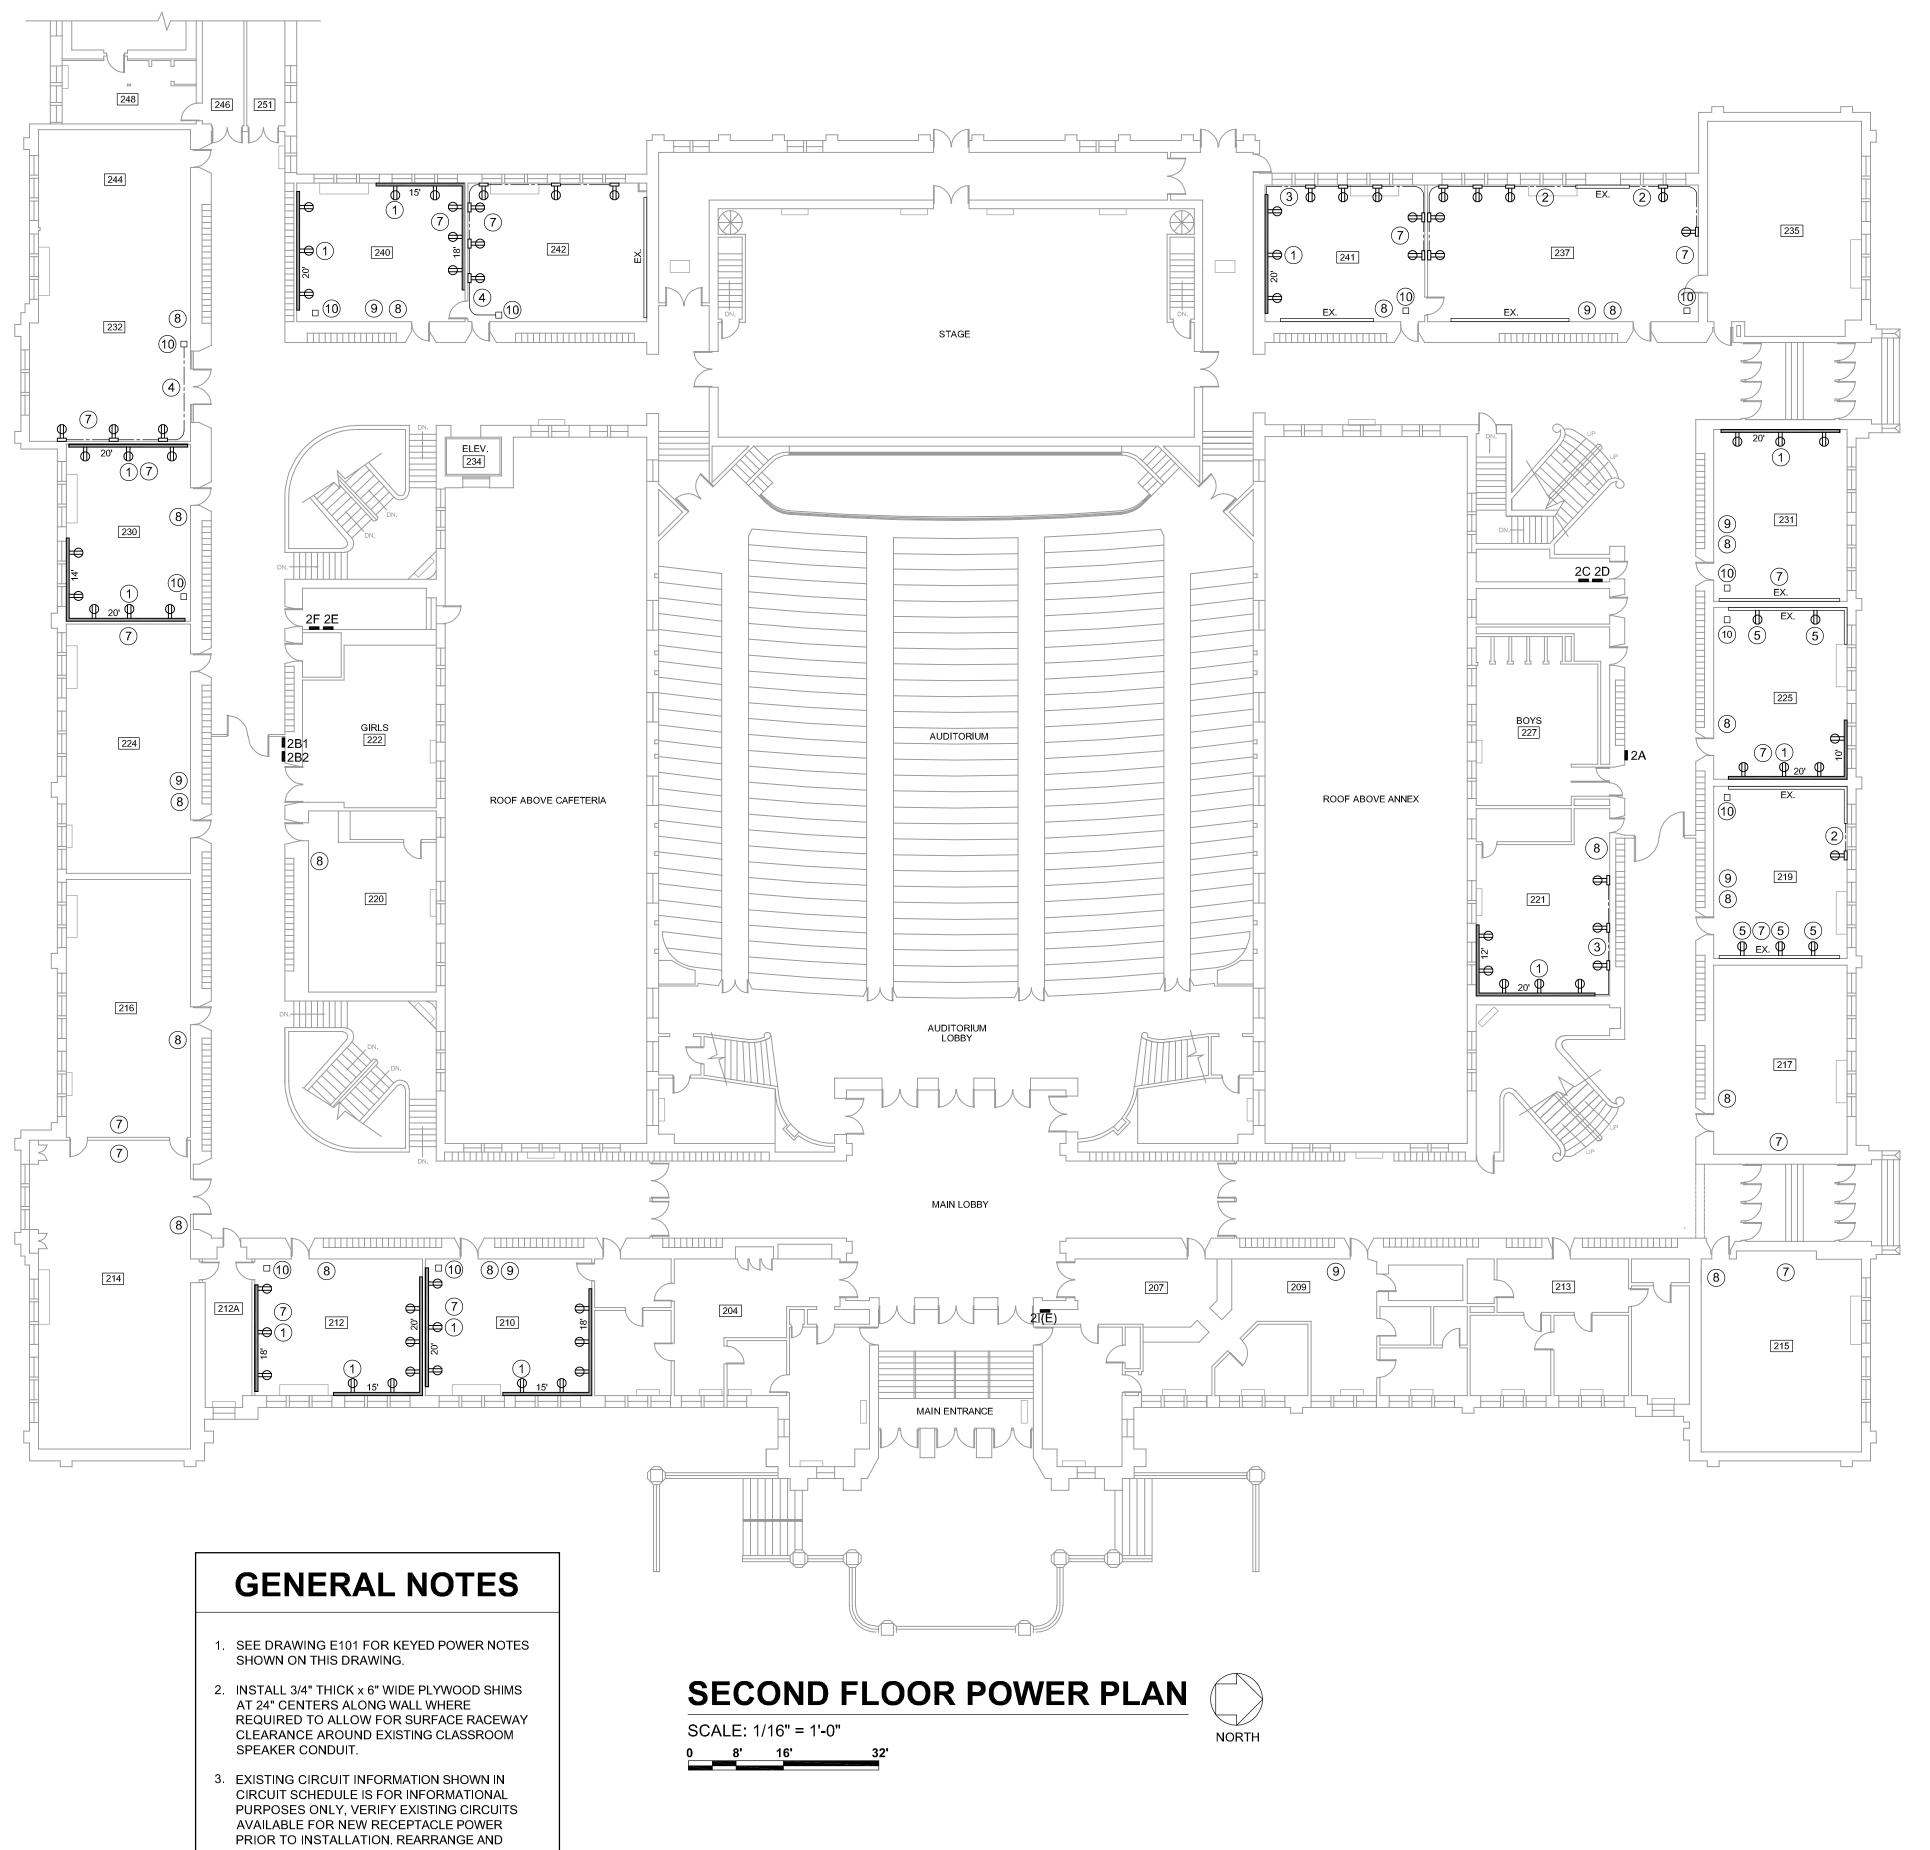

CONNECT OR RECONNECT EXISTING CIRCUITS IN PANELS AS REQUIRED.

ARCHITECTS • Engineers • interior designers

STO MAINE STREET • QUINCY, ILLINOIS 62301 • 217.222.0554

DESIGN FIRM NO. 184.004061 • INFO@ARCHITECHNICSINC.COM

062-050495
REGISTERO

LICENSE EXPIRES: 11/30/21

T: QJHS
DISTRICT #172

NCY PUBLIC SCHOOL DISTORTED IN 14TH STREET, QUINCY, ILLINOIS

CONSTRUCTION DOCUMENT

PHASE ISSUED FOR

ISSUED FOR
CONSTRUCTION

SSUE DATE: 03/20/202


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REVISIONS


PROJECT NUMBER: 5901


SECOND FLOOR POWER PLAN

DWG. NO. **E201** 


ECHINICS INC.

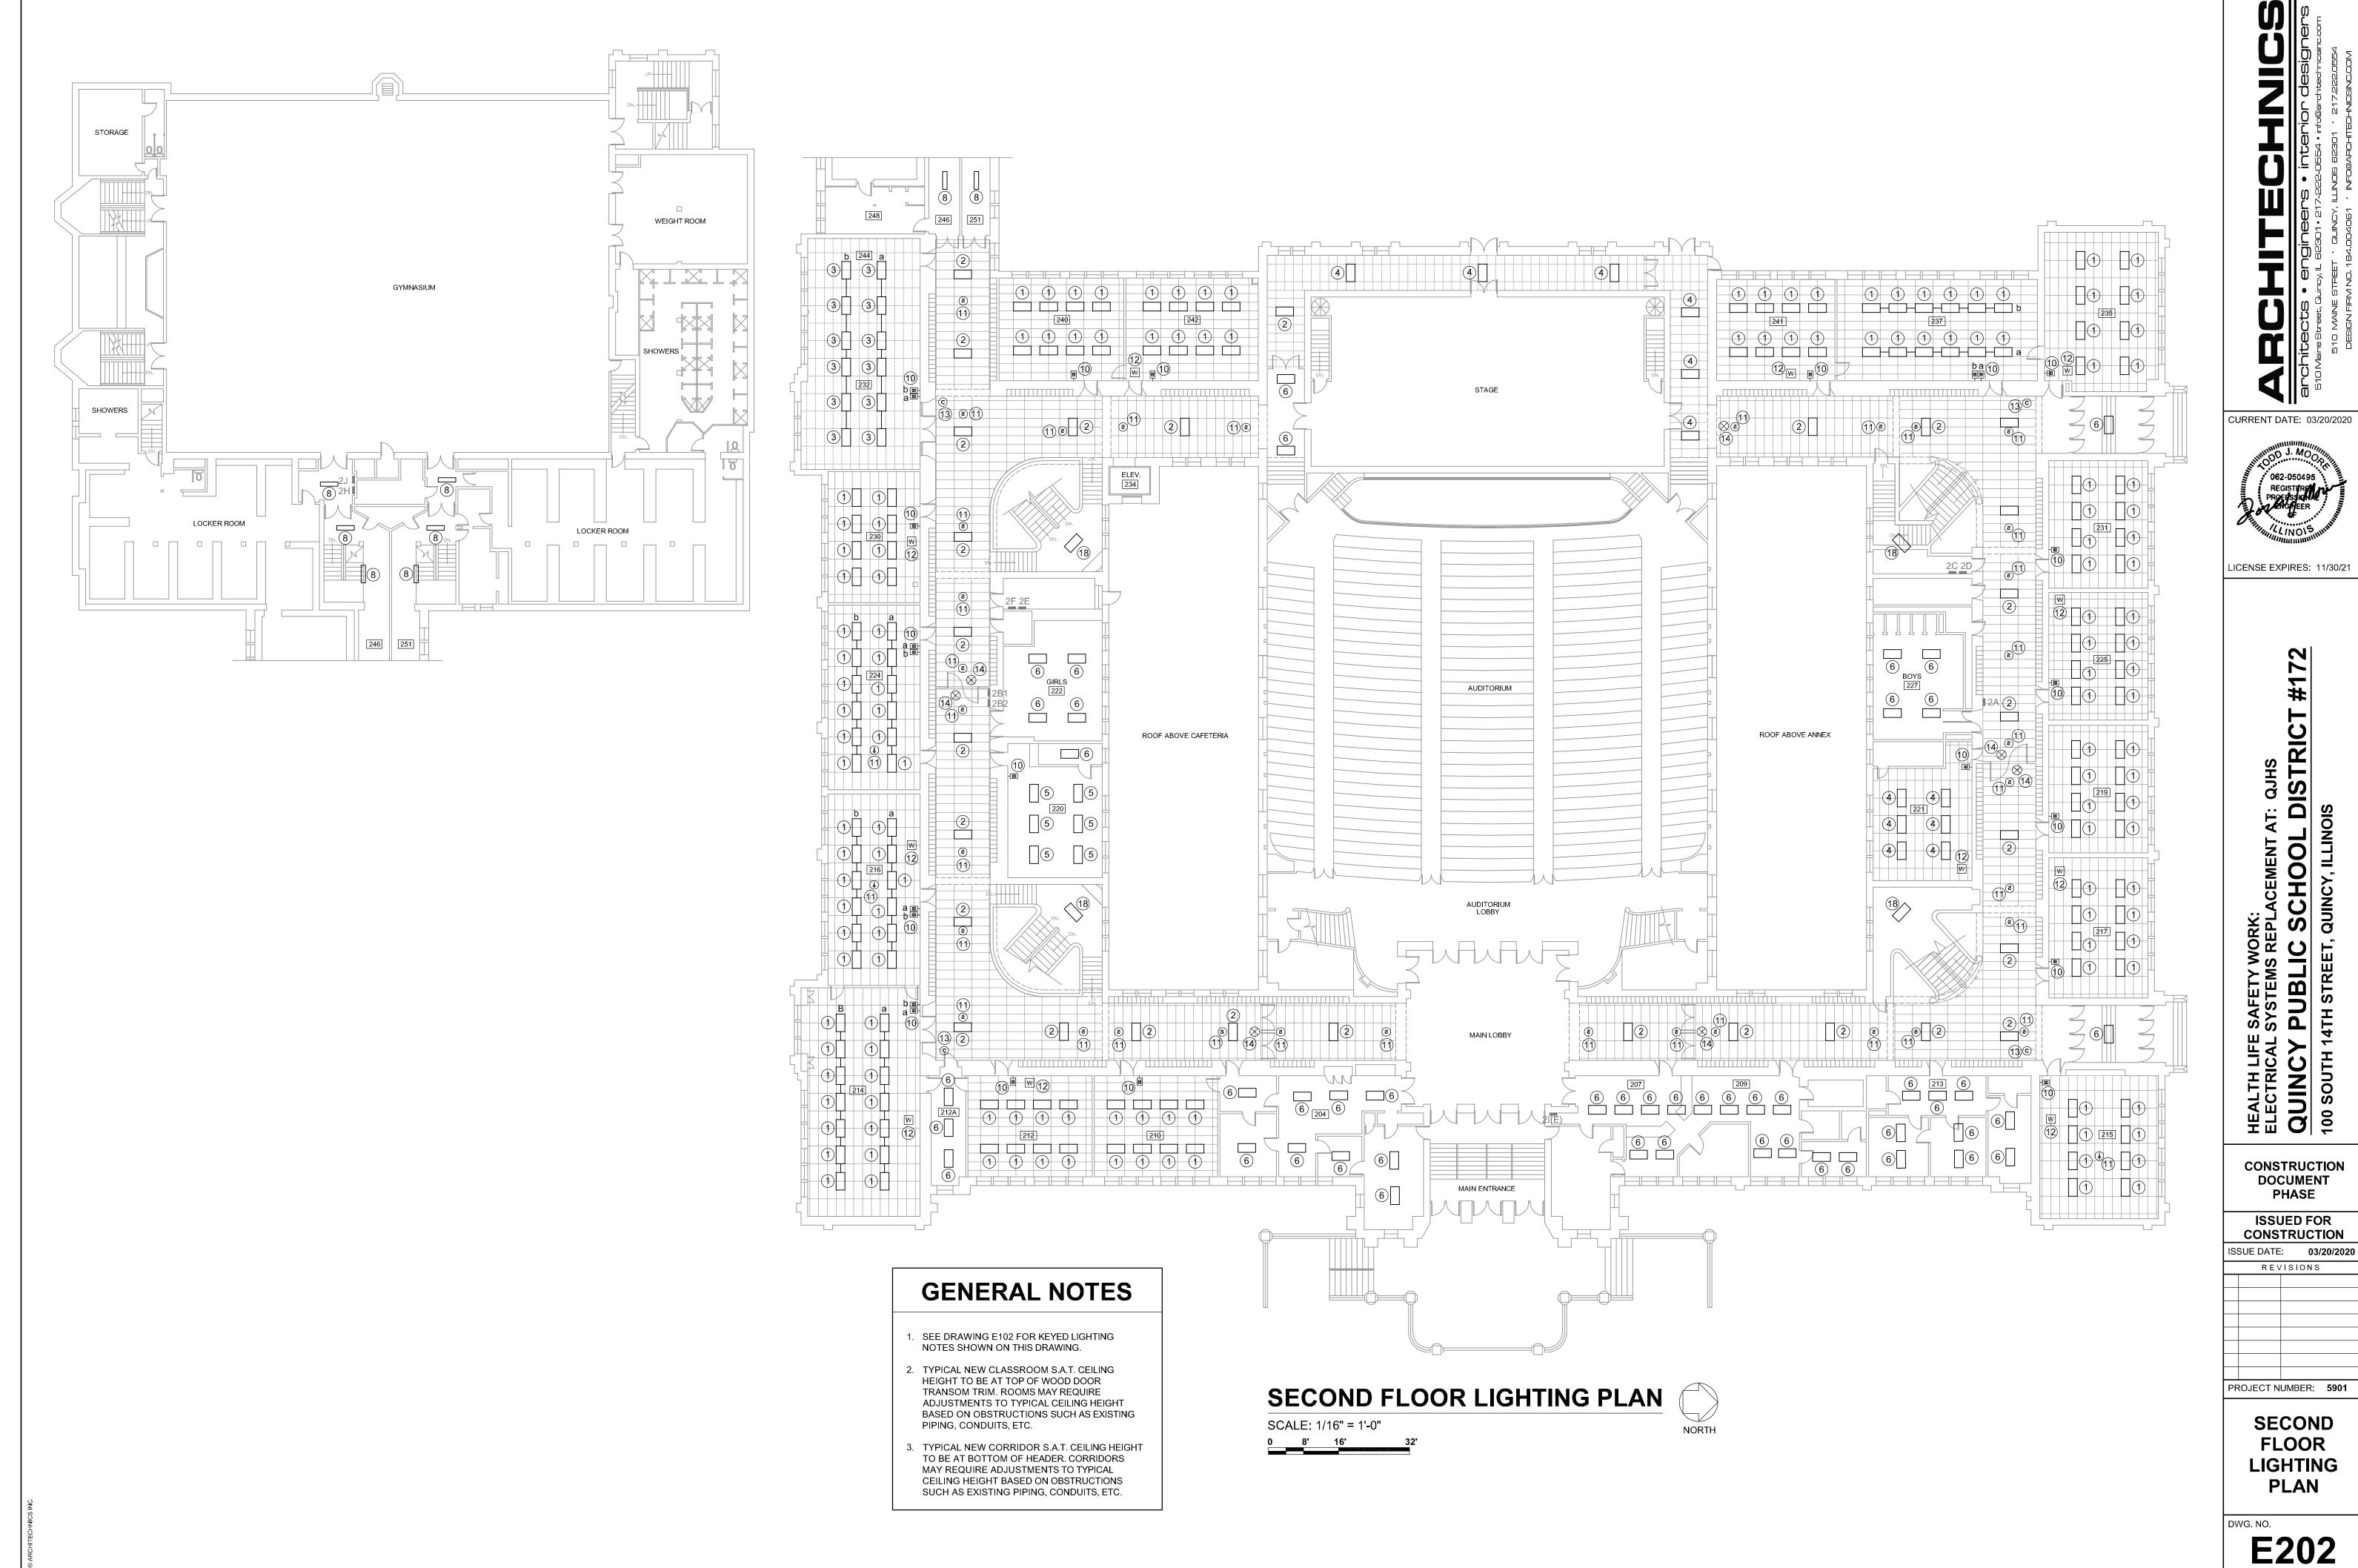

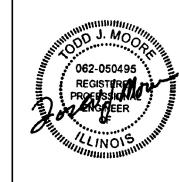

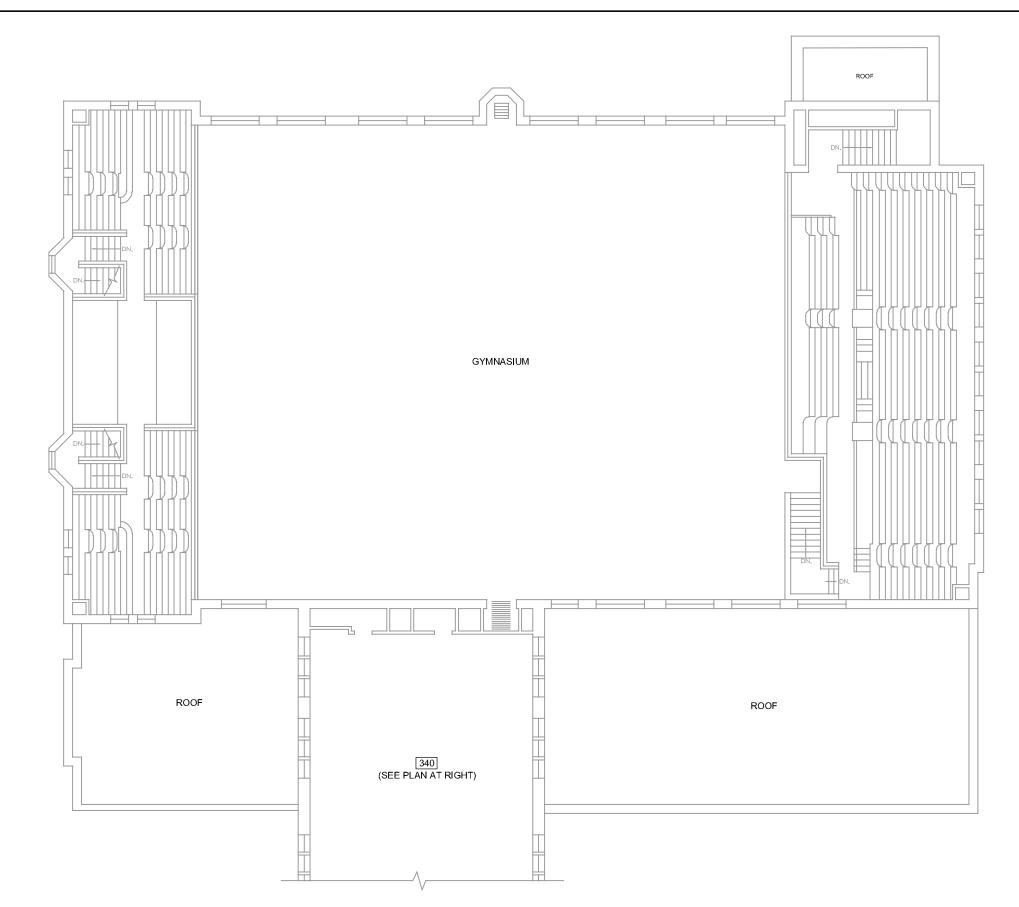

		THIRD FLOOR	CIRCUIT SCHEDULE
ROOM	PANEL	CIRCUITS AVAILABLE	REMARKS
306	3Н	EXISTING CIRCUITS #19, #21, #31, #33, #41, & #42	FEED NEW RECEPTACLES ON WALL AND IN NEW SURFACE RACEWAY FROM MINIMUN TWO AVAILABLE CIRCUITS IN EXISTING JUNCTION BOX IN ROOM
307	3G	NEW CIRCUITS TO BE DETERMINED IN FIELD	INSTALL NEW HOME RUN FROM PANEL 3G TO ROOM 313. FEED NEW RECEPTACLES IN NEW SURFACE RACEWAY WITH MINIMUM TWO CIRCUITS FROM PANEL 3G.
308	3H	EXISTING CIRCUITS TO BE DETERMINED IN FIELD	FEED NEW RECEPTACLES ON WALL AND IN NEW SURFACE RACEWAY FROM AVAILABLE CIRCUITS IN FORMER A/C JUNCTION BOX IN ROOM
309	3G	NEW CIRCUITS TO BE DETERMINED IN FIELD	INSTALL NEW HOME RUN FROM PANEL 3G TO ROOM 313. FEED NEW RECEPTACLES IN NEW SURFACE RACEWAY WITH MINIMUM TWO CIRCUITS FROM PANEL 3G.
313	3G	NEW CIRCUITS TO BE DETERMINED IN FIELD	INSTALL NEW HOME RUN FROM PANEL 3G TO ROOM 313. FEED NEW RECEPTACLES IN NEW SURFACE RACEWAY WITH MINIMUM TWO CIRCUITS FROM PANEL 3G.
314	3H	EXISTING CIRCUITS TO BE DETERMINED IN FIELD	FEED NEW RECEPTACLES ON WALL AND IN NEW SURFACE RACEWAY FROM MINIMUN TWO AVAILABLE CIRCUITS IN EXISTING JUNCTION BOX IN ROOM
316	3H	EXISTING CIRCUITS TO BE DETERMINED IN FIELD	FEED NEW RECEPTACLES ON WALL AND IN NEW SURFACE RACEWAY FROM MINIMUN TWO AVAILABLE CIRCUITS IN EXISTING JUNCTION BOX IN ROOM
317	3C	EXISTING CIRCUITS TO BE DETERMINED IN FIELD	FEED NEW RECEPTACLES ON WALL AND IN NEW SURFACE RACEWAY FROM MINIMUN TWO AVAILABLE CIRCUITS IN JUNCTION BOX IN ROOM
318	3F	EXISTING CIRCUITS TO BE DETERMINED IN FIELD	FEED NEW RECEPTACLES ON WALL AND IN NEW SURFACE RACEWAY FROM MINIMUN TWO AVAILABLE CIRCUITS IN EXISTING JUNCTION BOX IN ROOM
319	ЗА	EXISTING CIRCUITS #35, & #37	FEED NEW SURFACE RACEWAY RECEPTACLES FROM AVAILABLE CIRCUITS IN EXISTING SURFACE RACEWAY
320	3F	EXISTING CIRCUITS TO BE DETERMINED IN FIELD	FEED NEW RECEPTACLES ON WALL AND IN NEW SURFACE RACEWAY FROM MINIMUN TWO AVAILABLE CIRCUITS IN EXISTING JUNCTION BOX IN ROOM
323	3C	EXISTING CIRCUITS TO BE DETERMINED IN FIELD	FEED NEW RECEPTACLES ON WALL AND IN NEW SURFACE RACEWAY FROM MINIMUN TWO AVAILABLE CIRCUITS IN JUNCTION BOX IN ROOM
324	3F	EXISTING CIRCUITS TO BE DETERMINED IN FIELD	FEED NEW RECEPTACLES ON WALL AND IN NEW SURFACE RACEWAY FROM MINIMUN TWO AVAILABLE CIRCUITS IN EXISTING JUNCTION BOX IN ROOM
330	3F	EXISTING CIRCUITS TO BE DETERMINED IN FIELD	INSTALL NEW CONDUCTORS IN EXISTING CONDUIT RUN FROM PANEL 3F. FEED NEW RECEPTACLES ON WALL AND IN NEW SURFACE RACEWAY WITH MINIMUM TWO CIRCUITS FROM PANEL 3F RUN TO EXISTING JUNCTION BOX.
331	3C	EXISTING CIRCUITS TO BE DETERMINED IN FIELD	FEED NEW SURFACE RECEPTACLES FROM AVAILABLE CIRCUITS IN EXISTING ROOM
332	3F	EXISTING CIRCUITS TO BE DETERMINED IN FIELD	INSTALL NEW CONDUCTORS IN EXISTING CONDUIT RUN FROM PANEL 3F. FEED NEW RECEPTACLES ON WALL AND IN NEW SURFACE RACEWAY WITH MINIMUM TWO CIRCUITS FROM PANEL 3F RUN TO EXISTING JUNCTION BOX.
335	3C	EXISTING CIRCUITS TO BE DETERMINED IN FIELD	FEED NEW SURFACE RECEPTACLES FROM AVAILABLE CIRCUITS IN EXISTING ROOM
337	3C	EXISTING CIRCUITS #38, #40 & #42	FEED NEW SURFACE RACEWAY RECEPTACLES FROM AVAILABLE CIRCUITS IN EXISTING ROOM
338	3F	EXISTING CIRCUITS TO BE DETERMINED IN FIELD	INSTALL NEW CONDUCTORS IN EXISTING CONDUIT RUN FROM PANEL 3F. FEED NEW RECEPTACLES ON WALL AND IN NEW SURFACE RACEWAY WITH MINIMUM TWO CIRCUITS FROM PANEL 3F RUN TO EXISTING JUNCTION BOX.
342	3F	EXISTING CIRCUITS TO BE DETERMINED IN FIELD	INSTALL NEW CONDUCTORS IN EXISTING CONDUIT RUN FROM PANEL 3F. FEED NEW RECEPTACLES ON WALL AND IN NEW SURFACE RACEWAY WITH MINIMUM TWO CIRCUITS FROM PANEL 3F RUN TO EXISTING JUNCTION BOX.
346	3F	EXISTING CIRCUITS TO BE DETERMINED IN FIELD	INSTALL NEW CONDUCTORS IN EXISTING CONDUIT RUN FROM PANEL 3F. FEED NEW RECEPTACLES ON WALL AND IN NEW SURFACE RACEWAY WITH MINIMUM TWO CIRCUITS FROM PANEL 3F RUN TO EXISTING JUNCTION BOX.

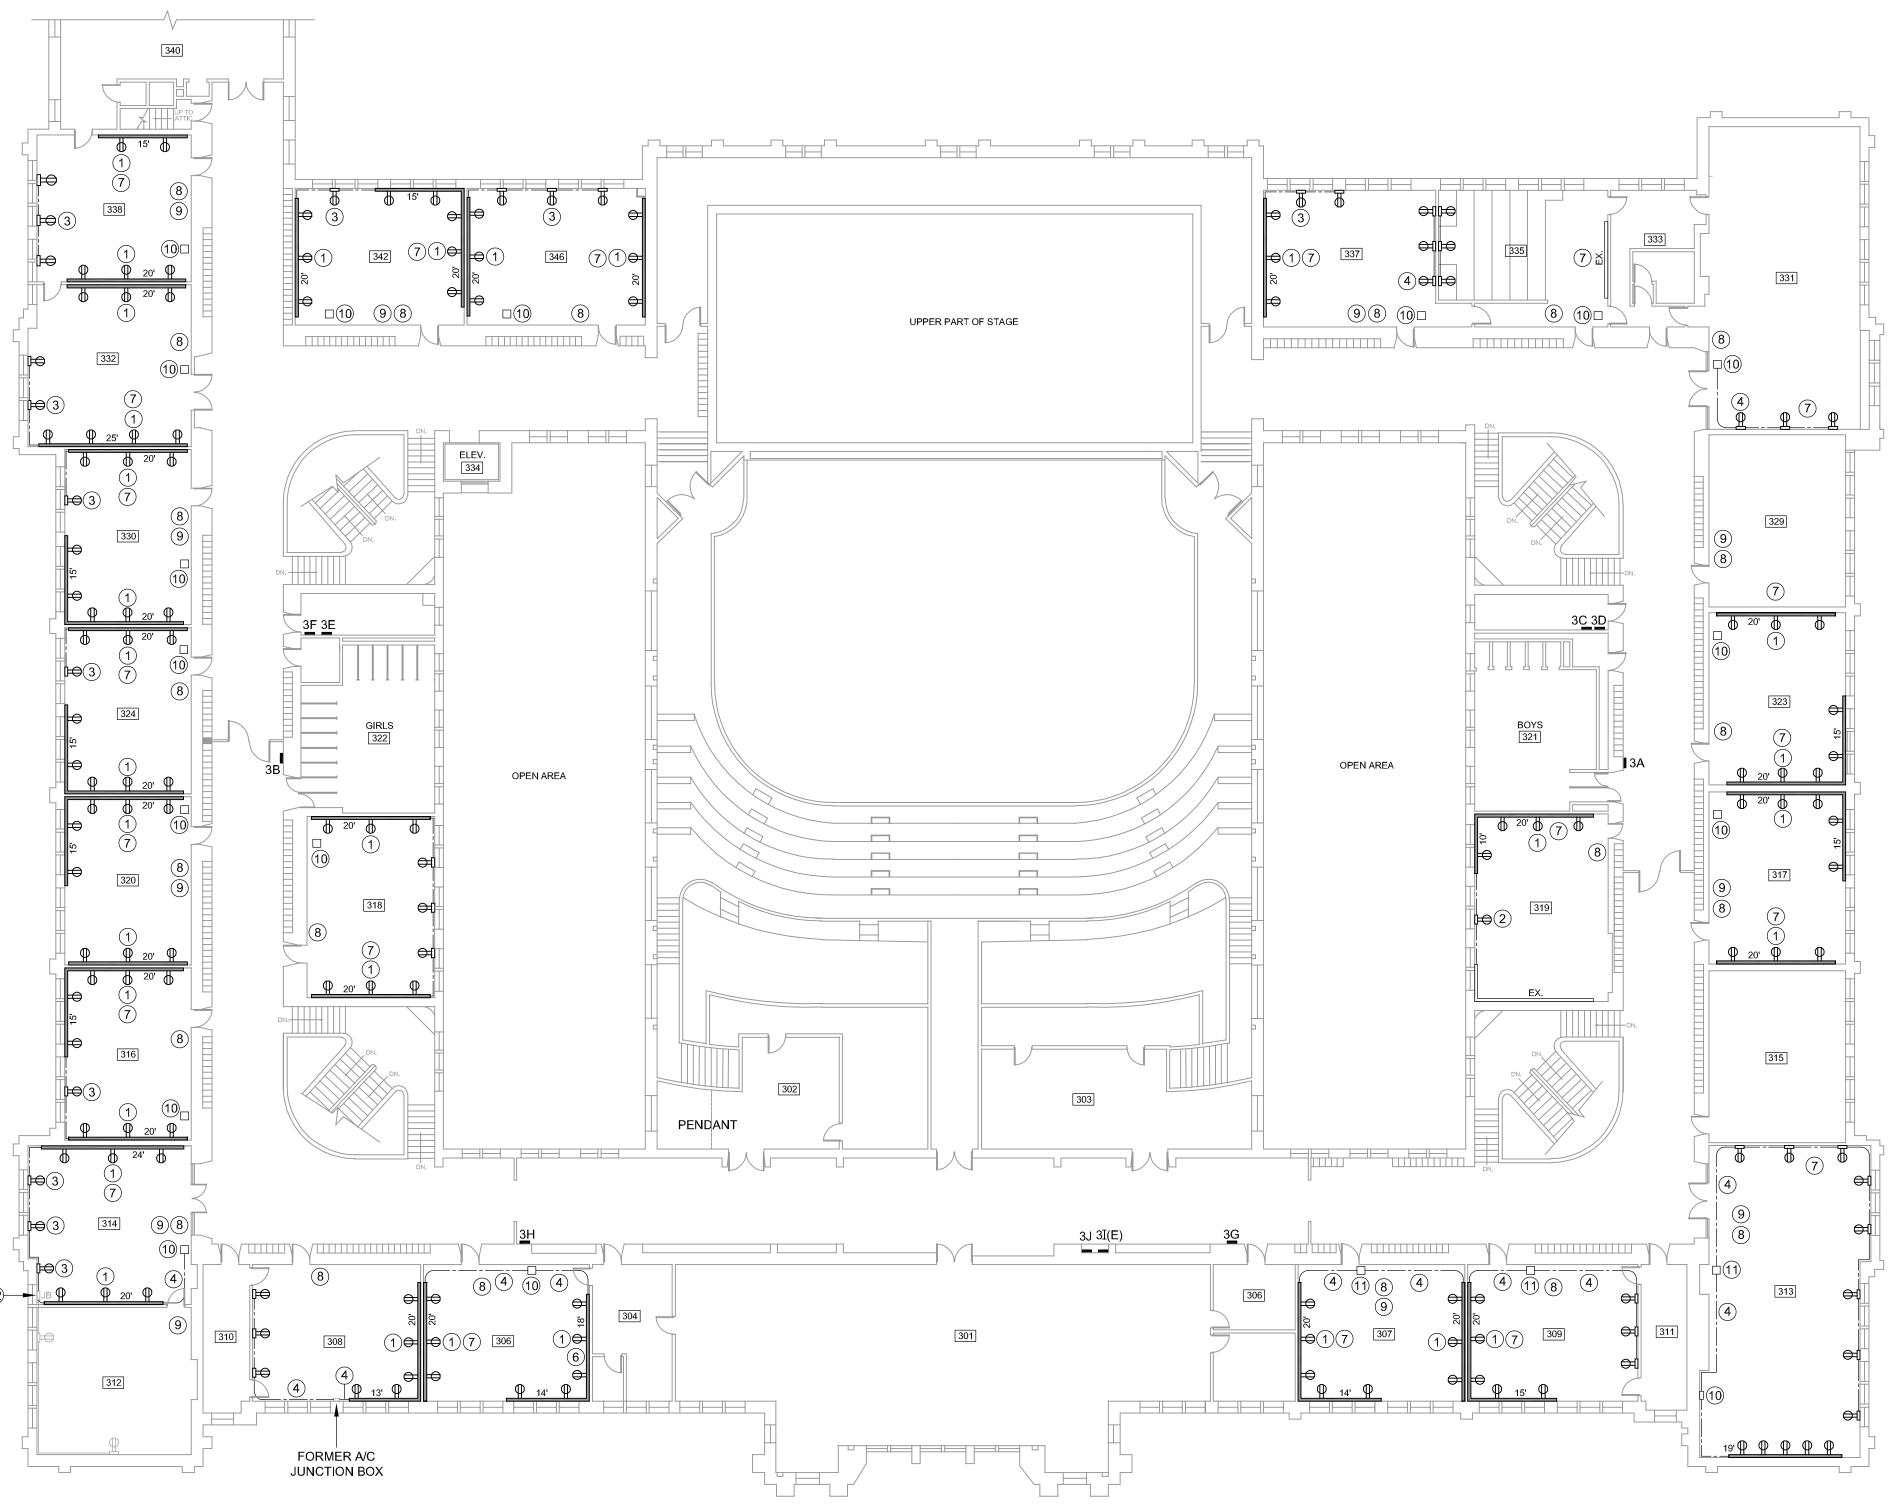

### **GENERAL NOTES**

- SEE DRAWING E101 FOR KEYED POWER NOTES SHOWN ON THIS DRAWING.
- INSTALL 3/4" THICK x 6" WIDE PLYWOOD SHIMS AT 24" CENTERS ALONG WALL WHERE REQUIRED TO ALLOW FOR SURFACE RACEWAY CLEARANCE AROUND EXISTING CLASSROOM SPEAKER CONDUIT.
- EXISTING CIRCUIT INFORMATION SHOWN IN CIRCUIT SCHEDULE IS FOR INFORMATIONAL PURPOSES ONLY, VERIFY EXISTING CIRCUITS AVAILABLE FOR NEW RECEPTACLE POWER PRIOR TO INSTALLATION. REARRANGE AND CONNECT OR RECONNECT EXISTING CIRCUITS IN PANELS AS REQUIRED.

## THIRD FLOOR POWER PLAN



CURRENT DATE: 03/20/2020

LICENSE EXPIRES: 11/30/21

T: QJHS
DISTRICT ; HEALTH LIFE SAFETY WORK:
ELECTRICAL SYSTEMS REPLACAUINCY PUBLIC SC


CONSTRUCTION DOCUMENT

PHASE **ISSUED FOR** 

CONSTRUCTION ISSUE DATE: 03/20/2020 REVISIONS PROJECT NUMBER: 5901

> **THIRD FLOOR POWER PLAN**

DWG. NO. E301

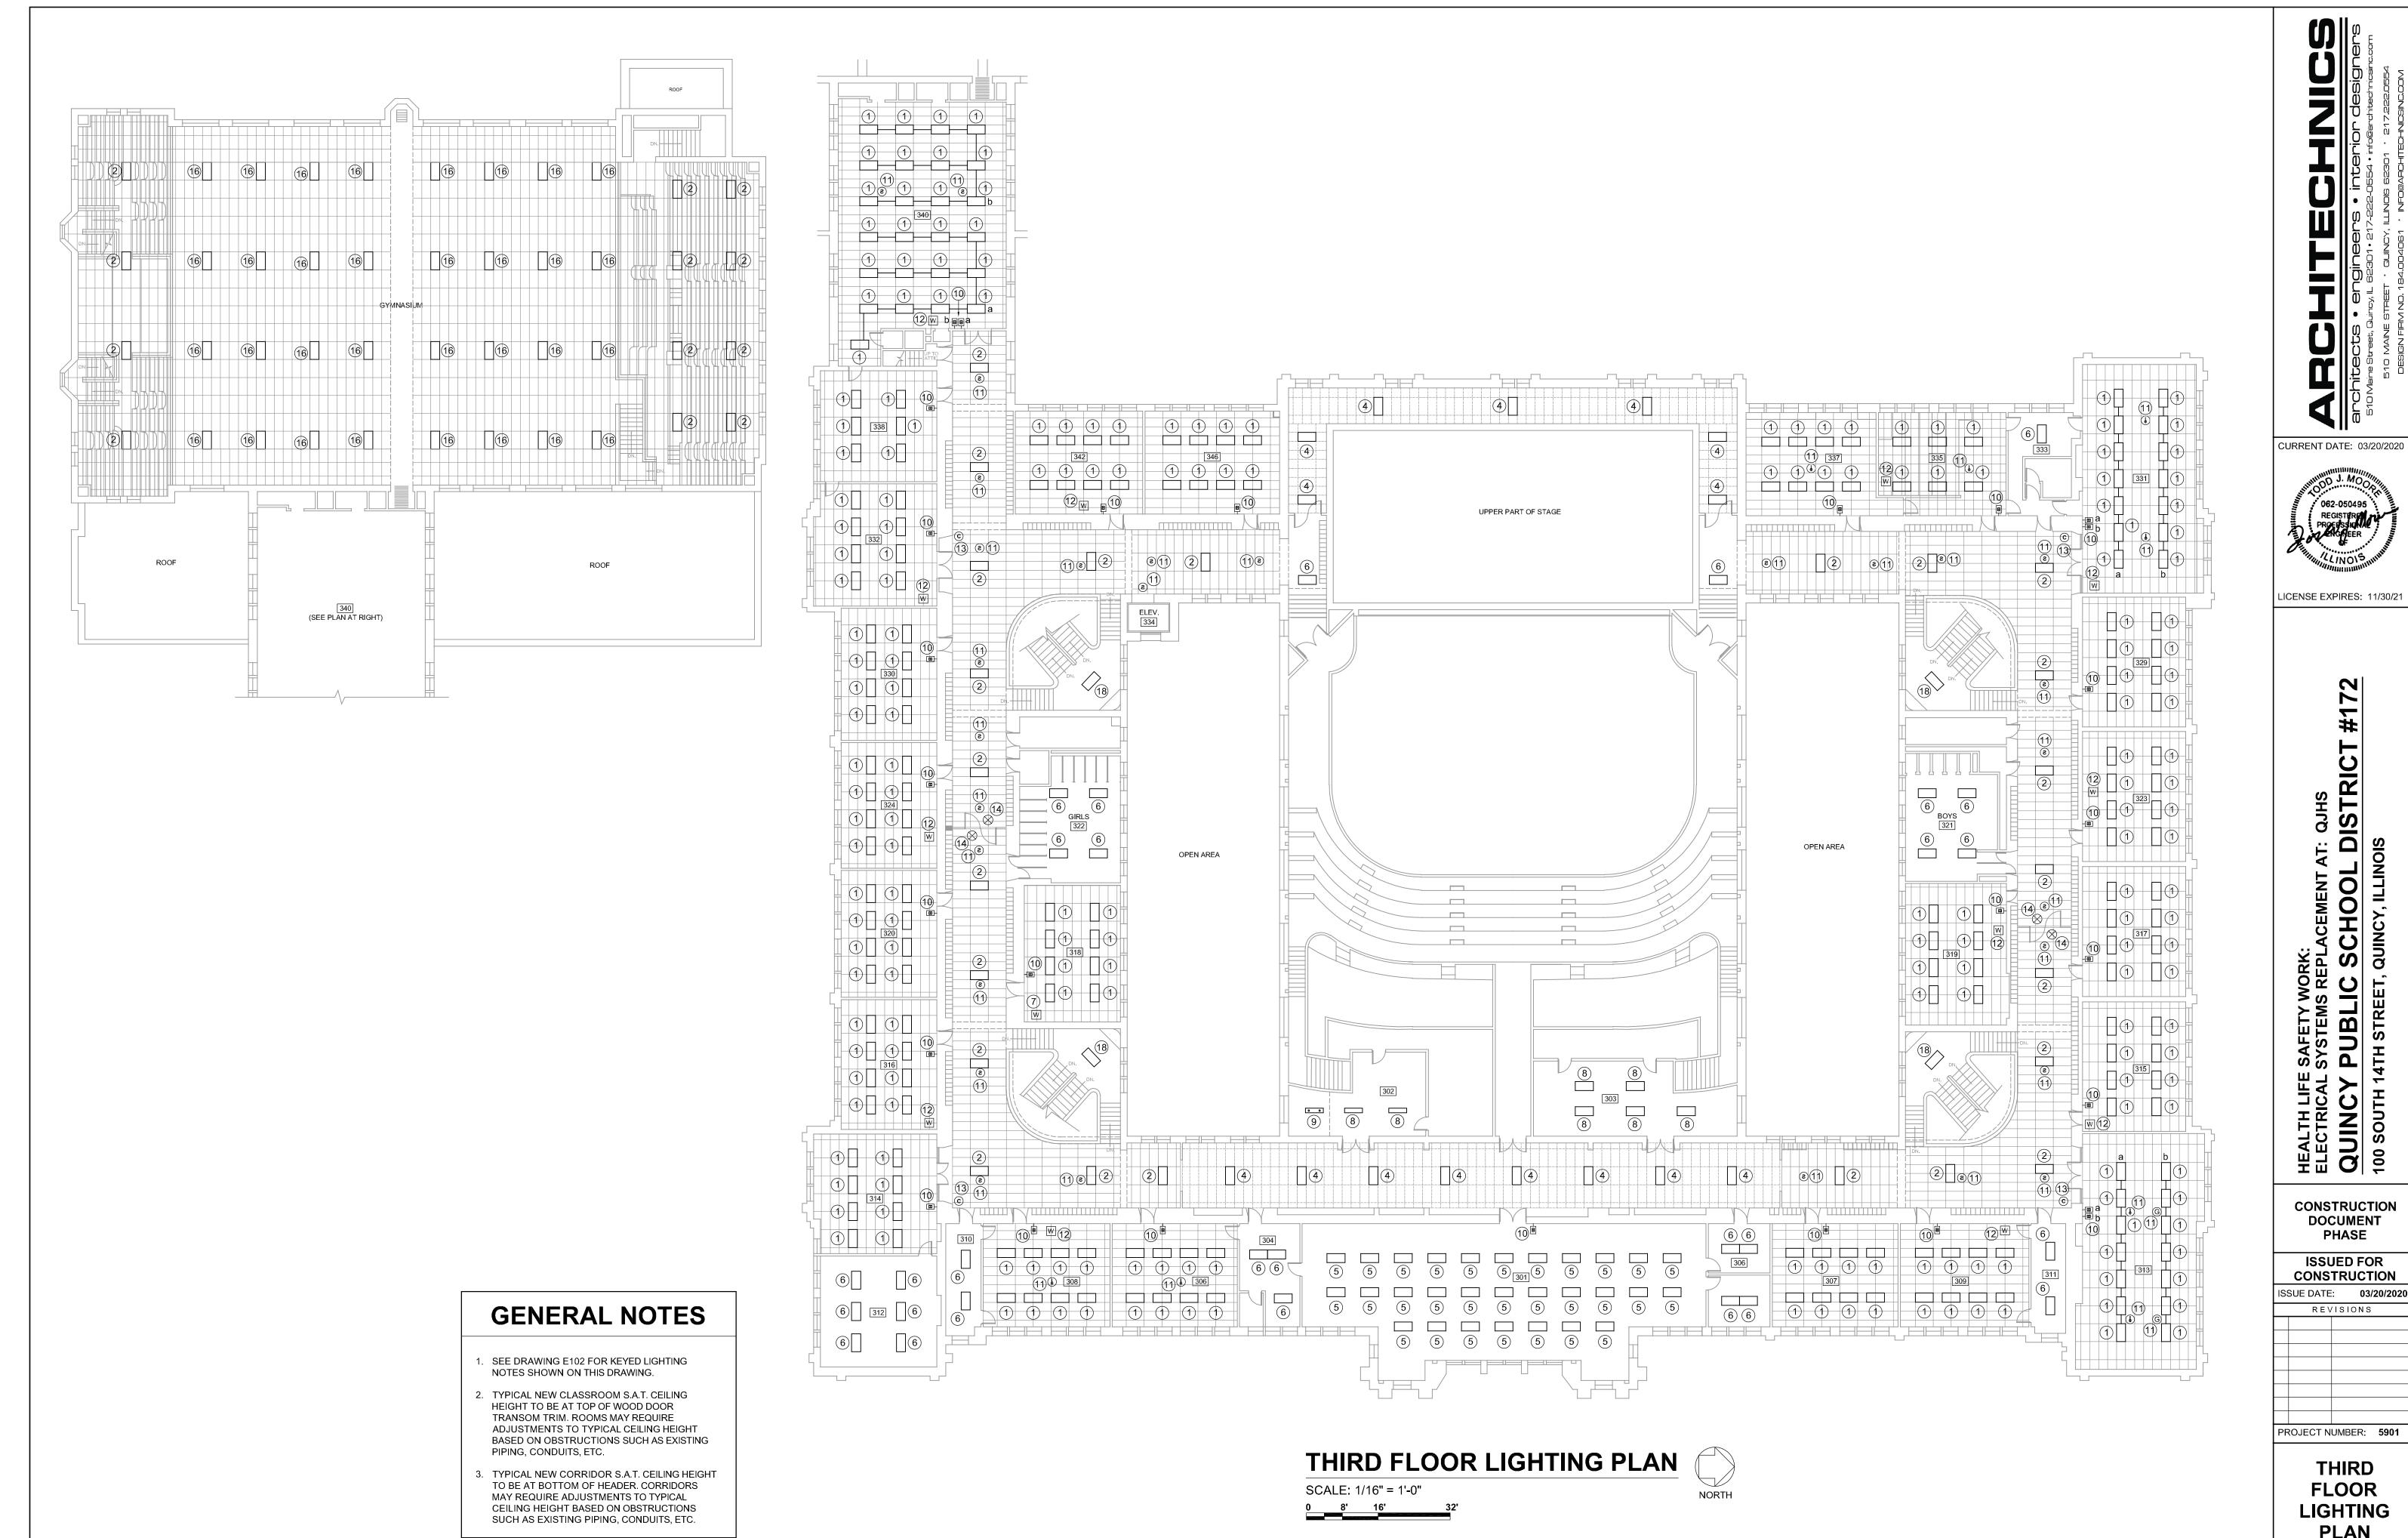

LICENSE EXPIRES: 11/30/21

T: QJHS

DISTRICT #172
DIS HEALTH LIFE SAFETY WORK:
ELECTRICAL SYSTEMS REPLACEMENT A
QUINCY PUBLIC SCHOOL

100 SOUTH 14TH STREET, QUINCY, ILLING


CONSTRUCTION DOCUMENT PHASE

**ISSUED FOR** CONSTRUCTION ISSUE DATE: 03/20/2020 REVISIONS


PROJECT NUMBER: 5901

THIRD **FLOOR LIGHTING PLAN** 

DWG. NO. E302

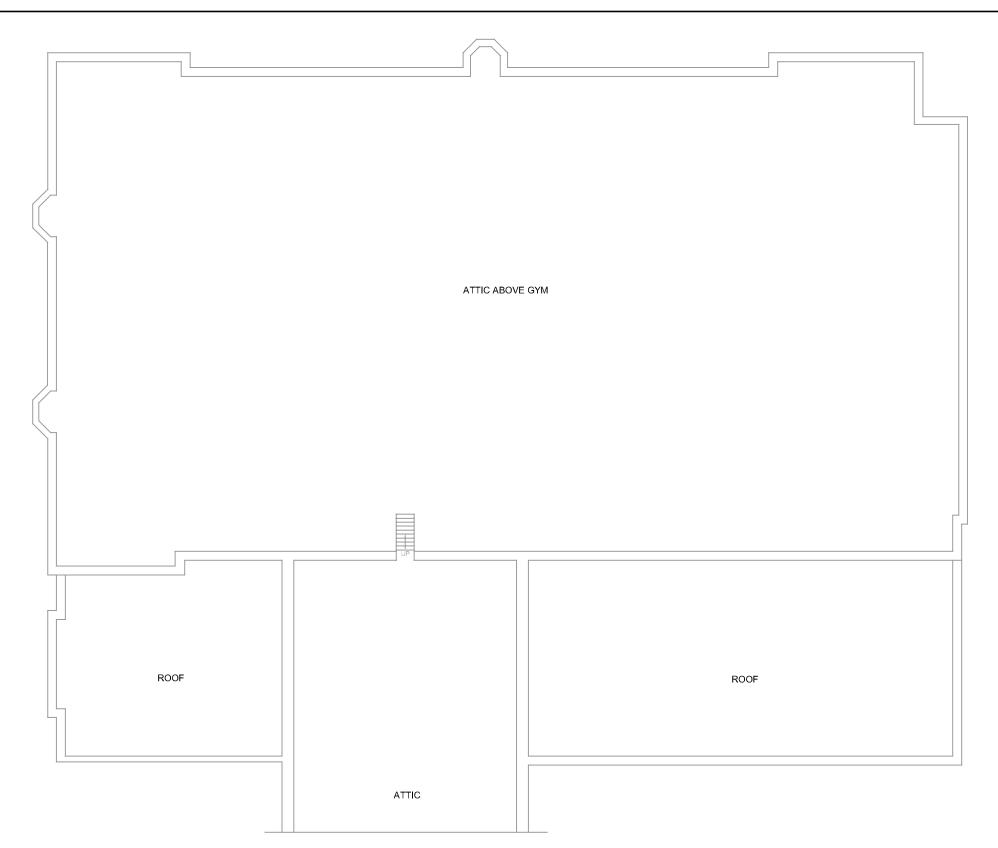

FOURTH FLOOR CIRCUIT SCHEDULE			
ROOM	PANEL	CIRCUITS AVAILABLE	REMARKS
408	4H	EXISTING CIRCUITS #34, #36, #38, #33, #40, & #42	FEED NEW RECEPTACLES IN NEW SURFACE RACEWAY FROM MINIMUN TWO AVAILABLE CIRCUITS IN EXISTING JUNCTION BOX IN ROOM
409	4G	EXISTING CIRCUITS #27, #29, #31, #33, & #35	FEED NEW RECEPTACLES IN NEW SURFACE RACEWAY FROM MINIMUN TWO AVAILABLE CIRCUITS IN EXISTING JUNCTION BOX IN ROOM
410	4H	EXISTING CIRCUITS #2, #4, #6, #8, & #12	FEED NEW RECEPTACLES IN NEW SURFACE RACEWAY FROM MINIMUN TWO AVAILABLE CIRCUITS IN EXISTING JUNCTION BOX IN ROOM
411	4G	EXISTING CIRCUITS #8, #10, #12, #37, #39, & #41	FEED NEW RECEPTACLES IN NEW SURFACE RACEWAY FROM MINIMUN TWO AVAILABLE CIRCUITS IN EXISTING JUNCTION BOX IN ROOM
413	4G	EXISTING CIRCUITS #20, #22, #24, #26, #28, #30, #32, #34, & #36	FEED NEW RECEPTACLES IN NEW SURFACE RACEWAY FROM MINIMUN TWO AVAILABLE CIRCUITS IN EXISTING JUNCTION BOX IN ROOM
417	4G	EXISTING CIRCUITS #1, #3, #5, #7, #9, #11, #13, & #15	FEED NEW RECEPTACLES IN NEW SURFACE RACEWAY FROM MINIMUN TWO AVAILABLE CIRCUITS IN EXISTING JUNCTION BOX IN ROOM
418	4F	EXISTING CIRCUITS #16, #18, #20, & #22	FEED NEW RECEPTACLES IN NEW SURFACE RACEWAY FROM MINIMUN TWO AVAILABLE CIRCUITS IN EXISTING JUNCTION BOX IN ROOM
419	4G	EXISTING CIRCUITS #19, #21 & #23	FEED NEW RECEPTACLES IN NEW SURFACE RACEWAY FROM MINIMUN TWO AVAILABLE CIRCUITS IN EXISTING JUNCTION BOX IN ROOM
420	4F	EXISTING CIRCUITS #2, #4, #6, #39, & #41	FEED NEW RECEPTACLES IN NEW SURFACE RACEWAY FROM MINIMUN TWO AVAILABLE CIRCUITS IN EXISTING JUNCTION BOX IN ROOM
421	4D	EXISTING CIRCUITS #39, & #41	FEED NEW RECEPTACLES IN NEW SURFACE RACEWAY FROM MINIMUN TWO AVAILABLE CIRCUITS IN EXISTING JUNCTION BOX IN ROOM
422	4F	EXISTING CIRCUITS #13, #15, #17, #25, #27, & #29	FEED NEW RECEPTACLES IN NEW SURFACE RACEWAY FROM MINIMUN TWO AVAILABLE CIRCUITS IN EXISTING JUNCTION BOX IN ROOM
423	4D	EXISTING CIRCUITS #14, #16, #18, & #30	FEED NEW RECEPTACLES IN NEW SURFACE RACEWAY FROM MINIMUN TWO AVAILABLE CIRCUITS IN EXISTING JUNCTION BOX IN ROOM
426	4F	EXISTING CIRCUITS #32, #34, #36, #38, #40, & #42	FEED NEW RECEPTACLES IN NEW SURFACE RACEWAY FROM MINIMUN TWO AVAILABLE CIRCUITS IN EXISTING JUNCTION BOX IN ROOM
427	4D	EXISTING CIRCUITS #32, #34, #36, #38, #40, & #42	FEED NEW RECEPTACLES IN NEW SURFACE RACEWAY FROM MINIMUN TWO AVAILABLE CIRCUITS IN EXISTING JUNCTION BOX IN ROOM
431	4D	EXISTING CIRCUITS #19, #21, #23, #25, #27, & #29	FEED NEW RECEPTACLES IN NEW SURFACE RACEWAY FROM MINIMUN TWO AVAILABLE CIRCUITS IN EXISTING JUNCTION BOX IN ROOM
432	4F	EXISTING CIRCUITS #20, #22, #24, #26, #28, & #30	FEED NEW RECEPTACLES IN NEW SURFACE RACEWAY FROM MINIMUN TWO AVAILABLE CIRCUITS IN EXISTING JUNCTION BOX IN ROOM
434	4F	EXISTING CIRCUITS #2, #4, #6, #37, #39, & #41	FEED NEW RECEPTACLES IN NEW SURFACE RACEWAY FROM MINIMUN TWO AVAILABLE CIRCUITS IN EXISTING JUNCTION BOX IN ROOM
435	4D	EXISTING CIRCUITS #31, #33, #35, & #37	FEED NEW RECEPTACLES ON WALL AND IN NEW SURFACE RACEWAY FROM AVAILABLE CIRCUITS IN FORMER A/C JUNCTION BOX IN ROOM
438	4F	EXISTING CIRCUITS #19, #21, #23, #25, #27, & #29	FEED NEW RECEPTACLES IN NEW SURFACE RACEWAY FROM MINIMUN TWO AVAILABLE CIRCUITS IN EXISTING JUNCTION BOX IN ROOM
439	4D	EXISTING CIRCUITS #20, #22, & #24	FEED NEW RECEPTACLES IN NEW SURFACE RACEWAY FROM MINIMUN TWO AVAILABLE CIRCUITS IN EXISTING JUNCTION BOX IN ROOM
441	4D	EXISTING CIRCUITS TO BE DETERMINED IN FIELD	FEED NEW RECEPTACLES IN NEW SURFACE RACEWAY FROM MINIMUN TWO AVAILABLE CIRCUITS IN EXISTING JUNCTION BOX IN ROOM
442	4F	EXISTING CIRCUITS #1, #3, #5, #7, #9, & #11	FEED NEW RECEPTACLES IN NEW SURFACE RACEWAY FROM MINIMUN TWO AVAILABLE CIRCUITS IN EXISTING JUNCTION BOX IN ROOM

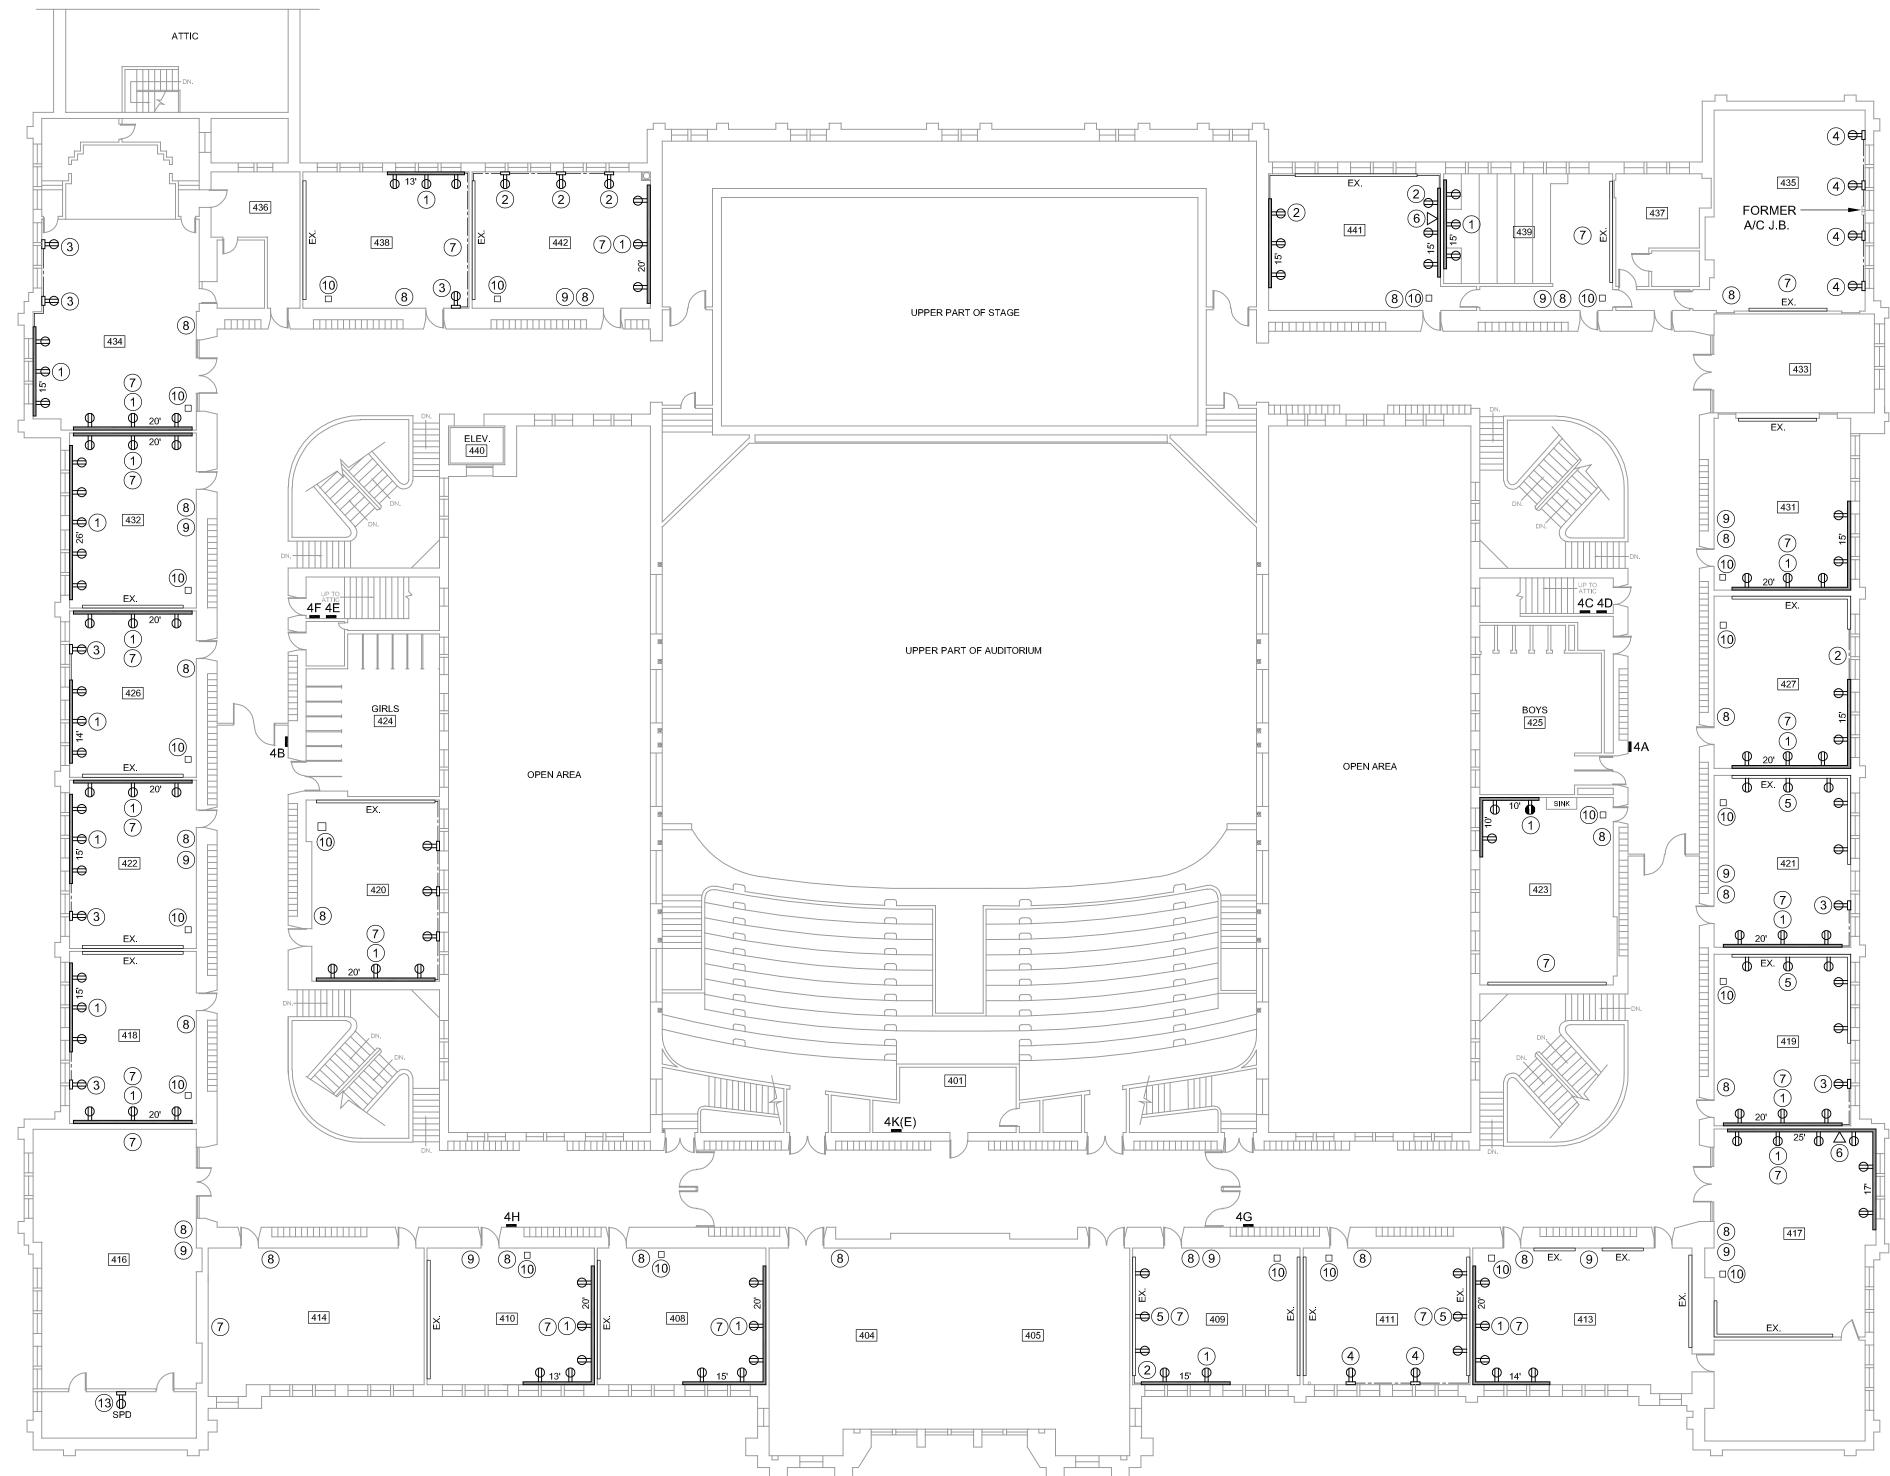

### **GENERAL NOTES**

- SEE DRAWING E101 FOR KEYED POWER NOTES SHOWN ON THIS DRAWING.
- 2. INSTALL 3/4" THICK x 6" WIDE PLYWOOD SHIMS AT 24" CENTERS ALONG WALL WHERE REQUIRED TO ALLOW FOR SURFACE RACEWAY CLEARANCE AROUND EXISTING CLASSROOM SPEAKER CONDUIT.
- EXISTING CIRCUIT INFORMATION SHOWN IN CIRCUIT SCHEDULE IS FOR INFORMATIONAL PURPOSES ONLY, VERIFY EXISTING CIRCUITS AVAILABLE FOR NEW RECEPTACLE POWER PRIOR TO INSTALLATION. REARRANGE AND CONNECT OR RECONNECT EXISTING CIRCUITS IN PANELS AS REQUIRED.

## FOURTH FLOOR POWER PLAN

SCALE: 1/16" = 1'-0" 0 8' 16'



CURRENT DATE: 03/20/2020

LICENSE EXPIRES: 11/30/21

T: QJHS
DISTRICT ;

CONSTRUCTION DOCUMENT PHASE

**ISSUED FOR** CONSTRUCTION ISSUE DATE: 03/20/2020 REVISIONS PROJECT NUMBER: 5901

> **FOURTH FLOOR ELECTRICAL PLAN**



CURRENT DATE: 03/20/2020 LICENSE EXPIRES: 11/30/21

T: QJHS

DISTRICT HEALTH LIFE SAFETY WORK:
ELECTRICAL SYSTEMS REPLACEMENT AT
QUINCY PUBLIC SCHOOL I
100 SOUTH 14TH STREET, QUINCY, ILLINOI


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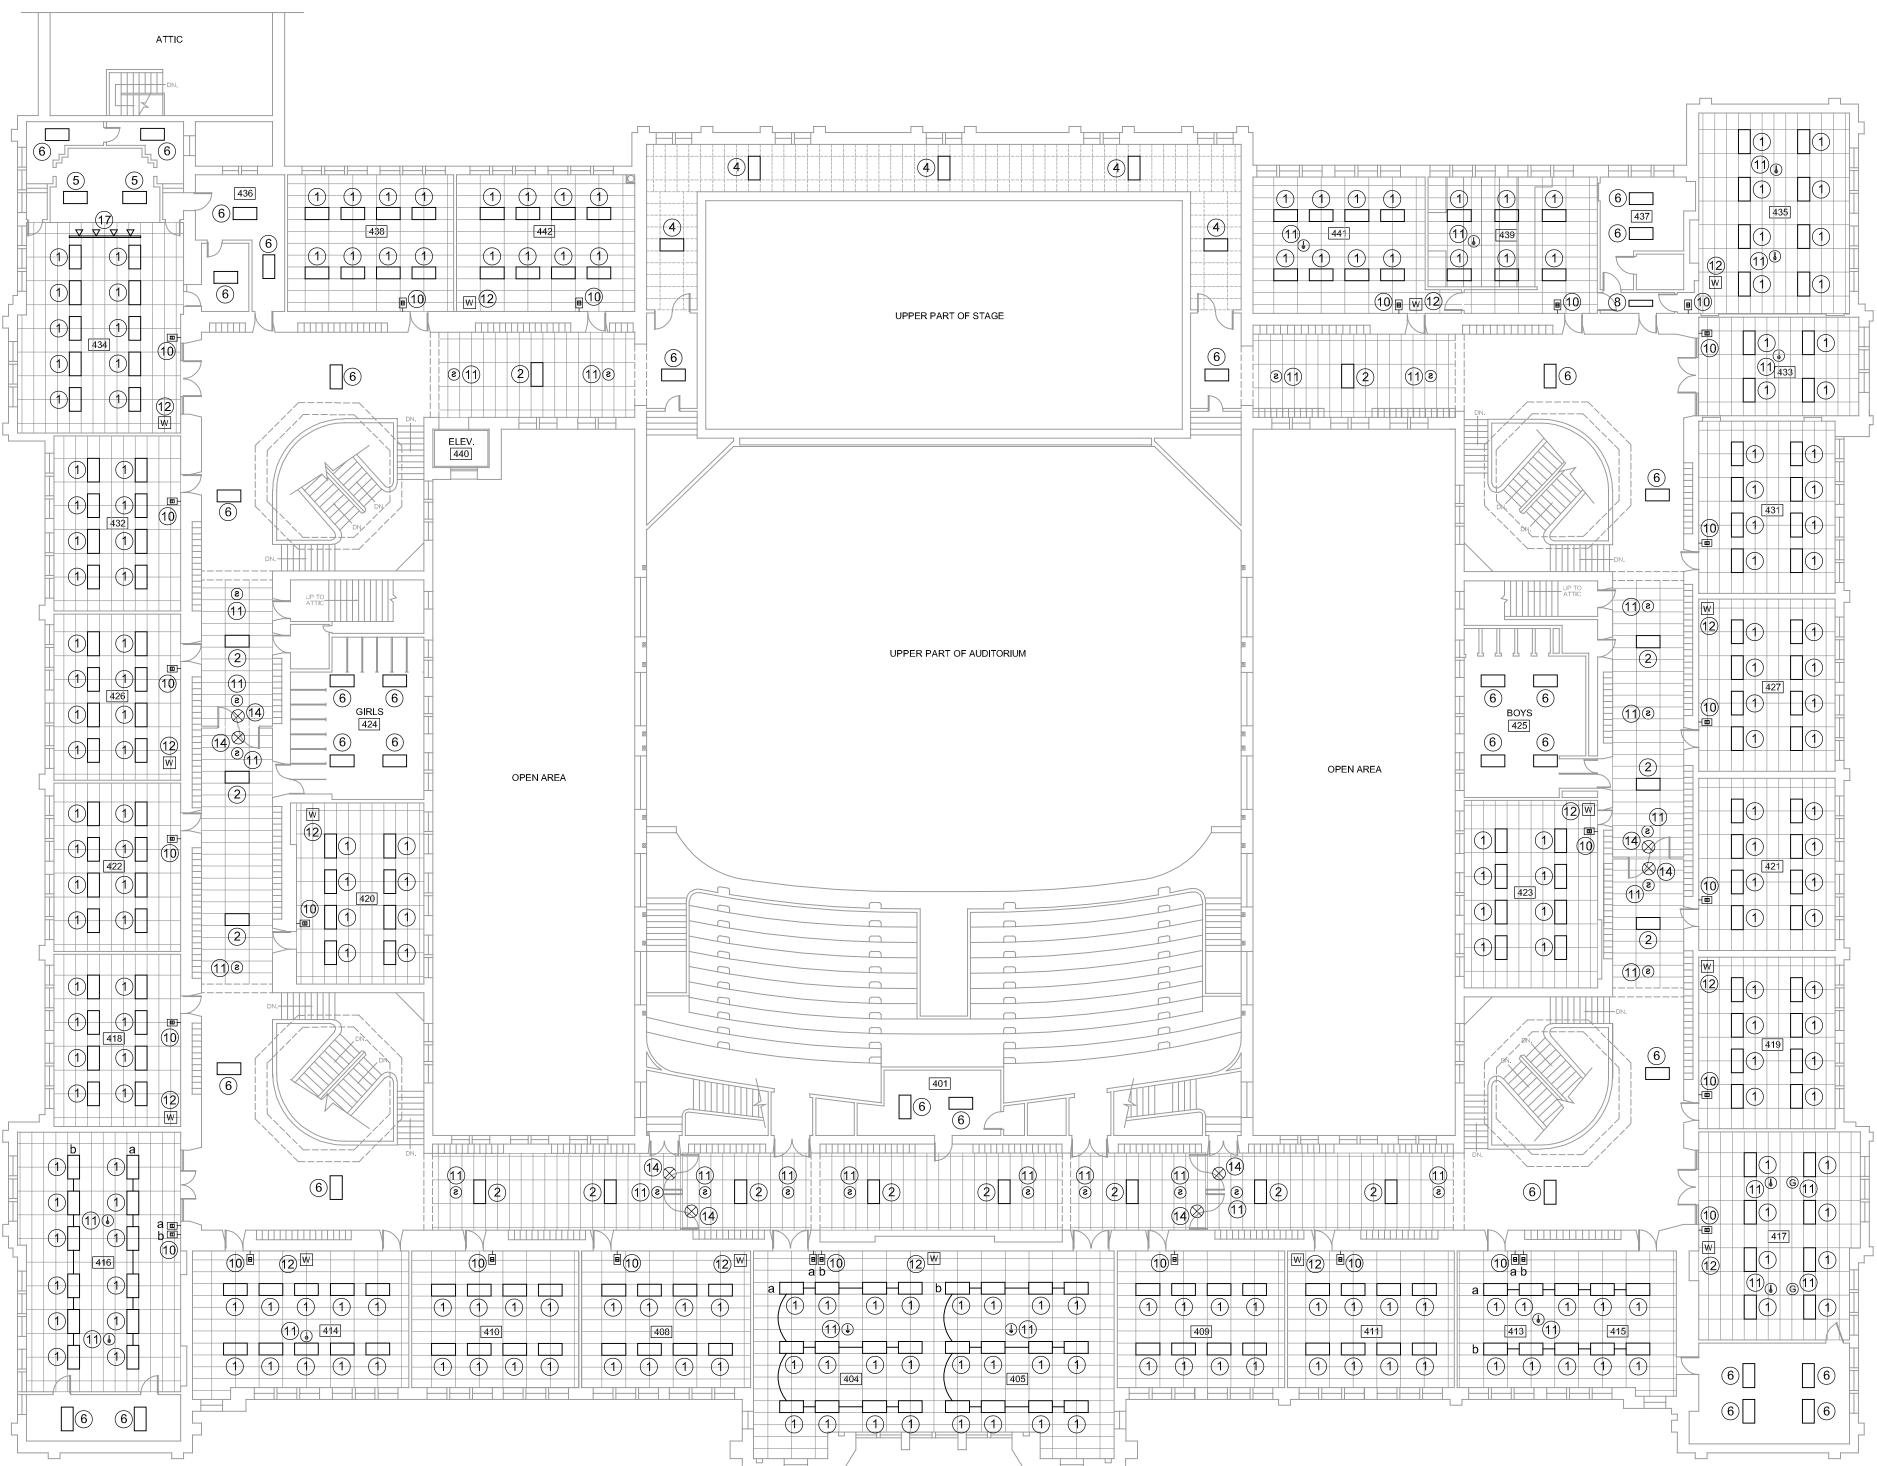
**PHASE ISSUED FOR** CONSTRUCTION ISSUE DATE: 03/20/2020 REVISIONS

PROJECT NUMBER: 5901 **FOURTH FLOOR LIGHTING** 

**PLAN** 

DWG. NO. E402



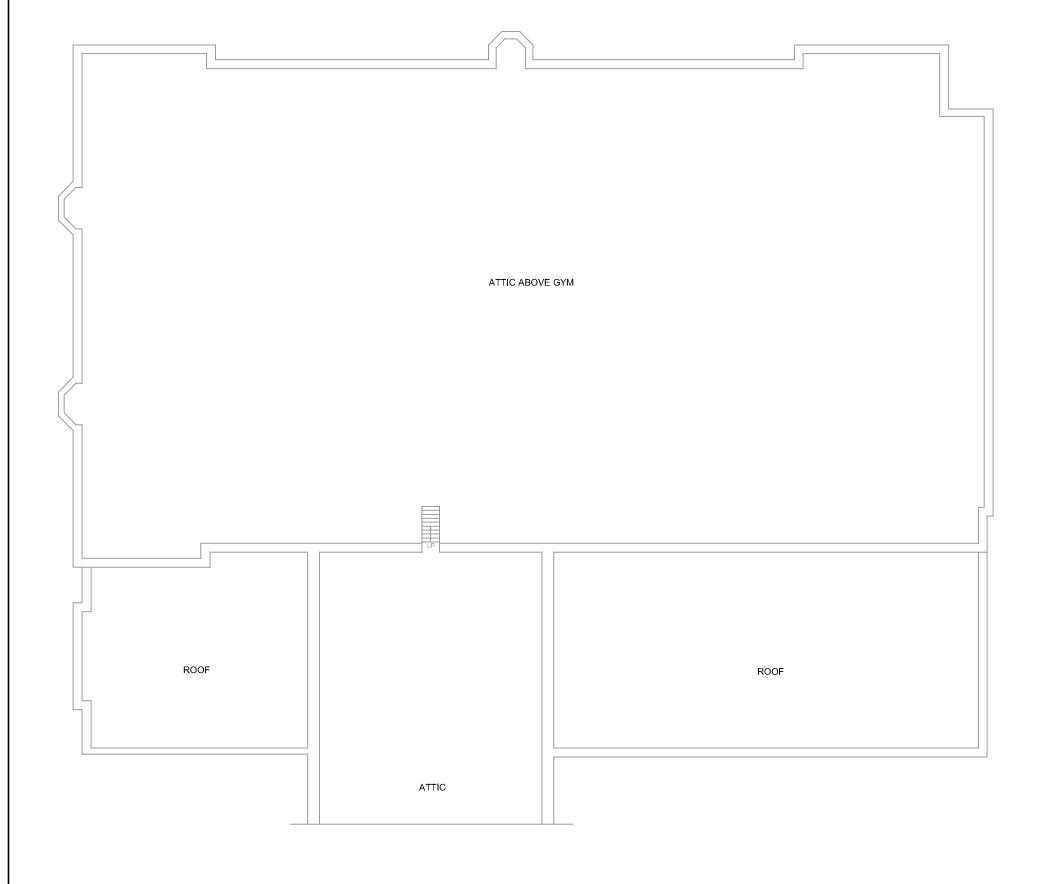


#### **GENERAL NOTES**

- SEE DRAWING E102 FOR KEYED LIGHTING NOTES SHOWN ON THIS DRAWING.
- 2. TYPICAL NEW CLASSROOM S.A.T. CEILING HEIGHT TO BE AT TOP OF WOOD DOOR TRANSOM TRIM. ROOMS MAY REQUIRE ADJUSTMENTS TO TYPICAL CEILING HEIGHT BASED ON OBSTRUCTIONS SUCH AS EXISTING PIPING, CONDUITS, ETC.
- 3. TYPICAL NEW CORRIDOR S.A.T. CEILING HEIGHT TO BE AT BOTTOM OF HEADER. CORRIDORS MAY REQUIRE ADJUSTMENTS TO TYPICAL CEILING HEIGHT BASED ON OBSTRUCTIONS SUCH AS EXISTING PIPING, CONDUITS, ETC.

## FOURTH FLOOR LIGHTING PLAN

SCALE: 1/16" = 1'-0"
0 8' 16' 32'

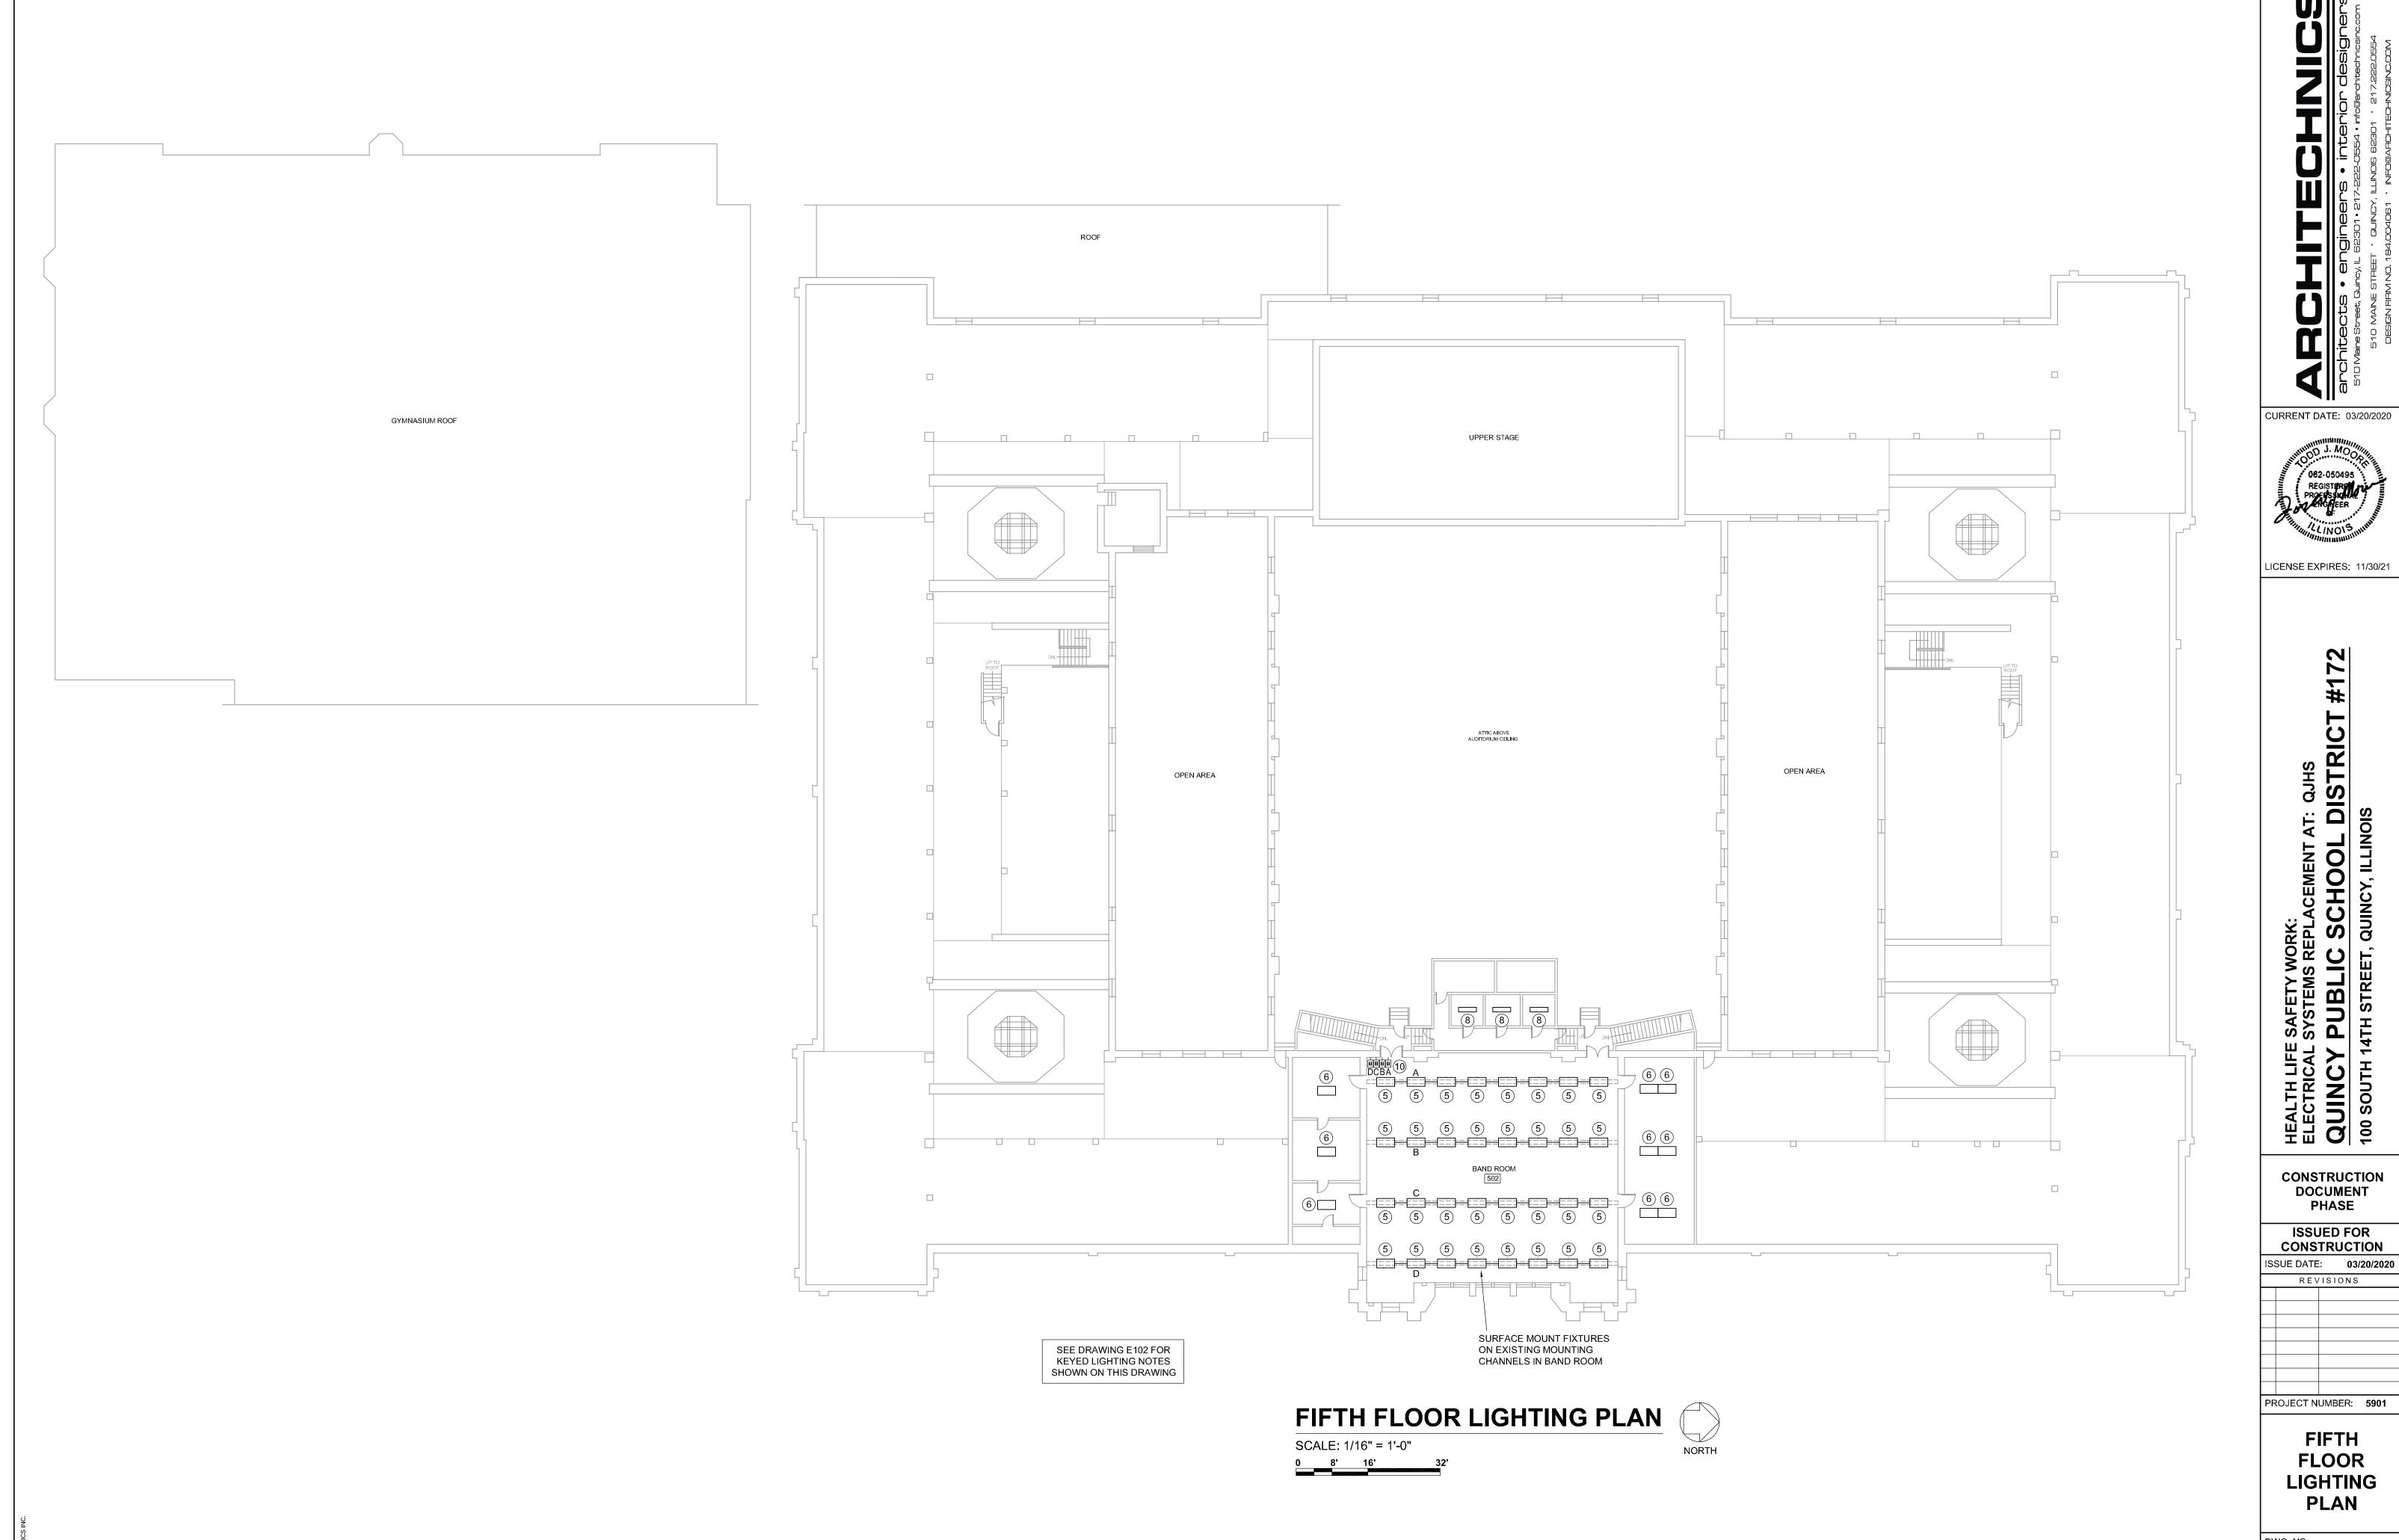

DWG. NO.