TITLE III GRANT- BUILDING "A" FIRST FLOOR - SCIENCE LABORATORY RENOVATIONS QUINCY UNIVERSITY - NORTH CAMPUS

GENERAL NOTES

- 1. CONTRACTOR TO VERIFY ALL DIMENSIONS.
- 2. ANY DISCREPANCIES BETWEEN STATED AND EXISTING CONDITIONS SHALL BE REPORTED IMMEDIATELY TO THE ARCHITECT.
- 3. DISCREPANCIES OR CONFLICTS BETWEEN SPECIFICATIONS AND DRAWINGS SHALL BE MADE KNOWN TO THE ARCHITECT FOR CLARIFICATION.
- 4. THE CONTRACTOR SHALL BE RESPONSIBLE FOR PROTECTING THOSE AREAS TO REMAIN UNDISTURBED DURING CONSTRUCTION.
- 5. THE CONTRACTOR SHALL TAKE NECESSARY PRECAUTIONS, AS PER THE WRITTEN SPECIFICATIONS, TO MAINTAIN SAFETY AT THE CONSTRUCTION SITE AND HE IS SOLELY RESPONSIBLE FOR SAFETY MEASURES. THE CONTRACTOR IS ALSO SOLELY RESPONSIBLE FOR CONSTRUCTION MEANS, METHODS, AND TECHNIQUES REGARDING EXECUTION OF THE WORK.
- 6. THE CONTRACTOR SHALL CONFORM TO ALL LOCAL AND STATE CODES AND RECEIVE LOCAL AND STATE APPROVAL WHERE NECESSARY PRIOR TO CONSTRUCTION.
- 7. THE CONTRACTOR SHALL GIVE ALL NECESSARY NOTICES AND OBTAIN ALL PERMITS AND PAY ALL LEGAL FEES. HE SHALL ALSO COMPLY WITH ALL CITY, COUNTY, AND STATE BUILDING LAWS, ORDINANCES, OR REGULATIONS.
- 8. THE CONTRACTOR SHALL BE RESPONSIBLE FOR THE DAMAGE OR LOSS OF ANY REFERENCE POINTS, MONUMENTS, HUBS AND STAKED LOT CORNERS DURING THE CONSTRUCTION OF HIS WORK, AND SHALL BEAR THE COST OF REPLACING SAME.
- 9. THE CONTRACTOR SHALL BE RESPONSIBLE FOR ANY DAMAGE DONE TO THE PREMISES OR ADJACENT PREMISES, OR INJURIES TO THE PUBLIC DURING THE CONSTRUCTION OF THE WORK, CAUSED BY HIMSELF, HIS SUBCONTRACTORS, OR THE CARELESSNESS OF ANY OF HIS EMPLOYEES.
- 10. THE CONTRACTOR MUST UNDERSTAND THAT THE WORK IS ENTIRELY AT HIS RISK UNTIL SAME IS ACCEPTED, AND HE WILL BE HELD RESPONSIBLE FOR ITS
- 11. THE CONTRACTOR SHALL FURNISH AND INSTALL ALL NECESSARY TEMPORARY MEASURES FOR THE PROTECTION OF THE WORK, INCLUDING BARRICADES, WARNING SIGNS, LIGHTS, ETC.
- 12. SITE LAYOUT IS TO BE AS PER ARCHITECTURAL DRAWINGS AND SPECIFICATIONS PREPARED BY ARCHITECT/ENGINEER.
- 13. THE CONTRACTOR SHALL PROVIDE THE ARCHITECT WITH ONE SET OF PRINTS MARKED WITH ANY CHANGES FROM ORIGINAL CONTRACT DOCUMENTS AT THE COMPLETION OF PROJECT.

 $+\Box$

SOAP

DISPENSER

DISPENSER

UTILITY INFORMATION IS FOR THE CONVENII CONSTRUCTION BEGINS, THE CONTRACTOR 1-800-892-0123 AND INDIVIDUAL UTILITY COM SYSTEM FOR THE PRESENCE AND LOCATION	SHALL CONTACT J.U.L.I.E. AT PANIES NOT BELONGING TO THE J.U.L.I
QUINCY UNIVERSITY CONTACT: MARK STRI	EKER 217-228-5237
J.U.L.I.E	1 (800) 892-0123
WATER AND SEWER: CITY OF QUINCY 730 MAINE, QUINCY, IL 62301	GENERAL (217) 228-4500 SEWER AND WATER (217) 228- 4580 AFTER HOURS (217) 228-4590
ELECTRIC & GAS: AMEREN-CIPS 700 JERSEY, QUINCY, IL 62301	GENERAL (888) 789-2477 GAS (217) 221- 0869 ELECT. (217) 221-0805
TELEPHONE: AT&T COMMERCIAL SERVICE	1-(800) 660-3000
CABLE: COMCAST COMMUNICATIONS 2930 STATE, QUINCY, IL 62301	(888) 736-6695 or (217) 223-5388
UTILITIES DEPT. CITY OF QUINCY - JEFFERY CITY OF QUINCY 2930 STATE, QUINCY, IL 62301	CONTE (217) 228-4500
CITY OF QUINCY PLANNING AND DEVELOPMENT DEPARTMEN	T (PLANNING, ZONING, AND BUILDING):
CHUCK BEVELHEIMER: DIRECTOR CITY OF QUINCY -706 MAINE ST. QUINCY IL ((217) 228-4515 62301
MICHAEL SEAVER: BUILDING INSPECTOR CITY OF QUINCY -706 MAINE ST. QUINCY IL 6	(217) 228-4540 62301
CENTRAL SERVICES (STREETS): CITY OF QUINCY - 2020 JENNIFER LANE QUI	(217) 228-4520 NCY IL 62301
FIRE DEPARTMENT: CITY OF QUINCY CHIEF JOE HENNING QUINCY FIRE DEPARTMENT 906 VERMONT ST. QUINCY IL 62301	(217) 228-4460
ARCHITECT/ ENGINEER: ANTHONY E. CRANE, A.I.A.	(217) 222-0554

ADDITIONAL LOWER HOOK IN

HOOKS

CLOTHES/

HOOKS

TOWEL

HOOK

- DRYING ROD - MOP HOLDERS

UTILITY SHELF W/

MOP AND BROOM

HOLDERS

HC ROOM ONLY

NAPKIN

DISPENSER



FIRE ALARM SIGNAL/STROBE WALL MOUNTED FIRE EXTINGUISHER FIRE EXTINGUISHER SIGN RECESSED FIRE OUTLET @ **EXTINGUISHER** MANUAL PULL CASEWORK -TEMPERATURE **EMERGENCY** IDENTIFICATION STATION SENSOR SIGN PUSH OUTLET BUTTON OUTLET NOTE: LATCH FOR F.E.C. SHOULD BE 44" A.F.F.

MISCELLANEOUS MOUNTING HEIGHTS

TYPICAL TOILET ACCESSORIES MOUNTING HEIGHTS


NAPKIN

DISPOSAL

TOILET PAPER TOILET PAPER

DISPENSER

HOLDER

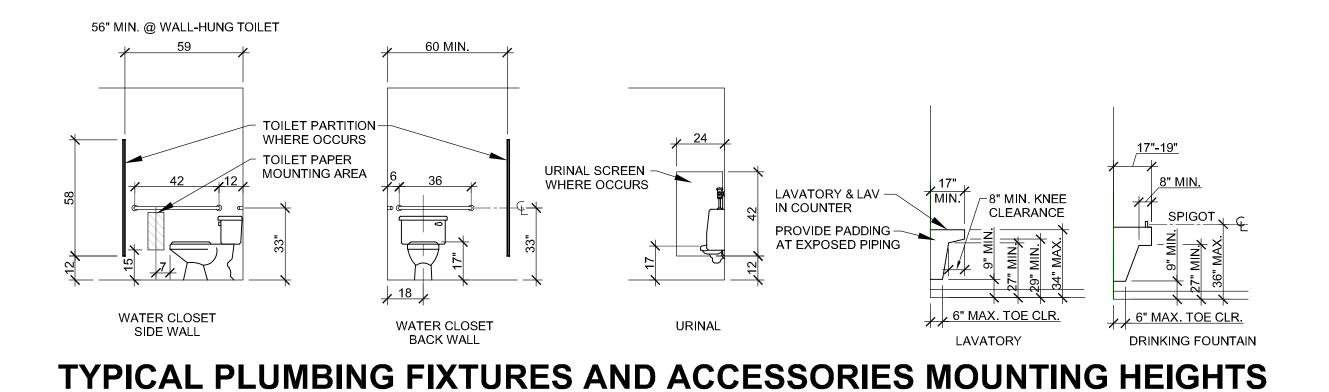

MAINTAIN INTEGRITY OF FIRE RATING WHERE SEE SPECIFICATIONS SECTION NO. 10800 **ELEVATIONS FOR OVER-RIDING DIMENSIONS** INSTALL ACCESSORIES WITH MANUFACTURER'S RECOMMENDED HARDWARE FOR APPLICABLE SUBSTRATE, TYPICAL.

A.D.A. COMPLIANCE

THIS PROJECT SHALL BE IN COMPLIANCE WITH GUIDELINES OF THE AMERICANS WITH DISABILITIES ACT (A.D.A.)

AMERICANS WITH DISABILITIES ACT (A.D.A.)

EXERCISED PROFESSIONAL EFFORTS TO INTERPRET THE INTENT OF THE "AMERICANS WITH DISABILITIES ACT", AND OTHER APPLICABLE FEDERAL, STATE AND LOCAL CODES AND REQUIREMENTS. ARCHITECHNICS, INC. CANNOT GUARANTEE TOTAL COMPLIANCE WITH ANY WORK DIRECTLY RELATED TO THE A.D.A., WHEN THE OWNER PERFORMS AND/OR AUTHORIZES WORK USING THESE DOCUMENTS AND/OR DRAWINGS.

INDEX OF DRAWINGS

GENERAL / TITLE SHEET / NOTES

LABORATORIES - DEMOLITION / FLOOR PLANS / DETAILS / NOTES SCIENCE LABORATORIES - CASEWORK PLAN / SPECIFICATIONS / SCHEDULES

SCIENCE CASEWORK ELEVATIONS / SPECIFICATIONS

SCIENCE LABORATORIES - PLUMBING PLAN


ELEVATIONS, SCHEDULES, DETAILS

EQUIPMENT SCHEDULES, DETAILS

SCIENCE LABORATORIES - MECHANICAL PLAN

SCIENCE LABORATORIES ELECTRICAL DEMOLITION AND LIGHTING PLAN

SCIENCE LABORATORIES - ELECTRICAL POWER PLAN

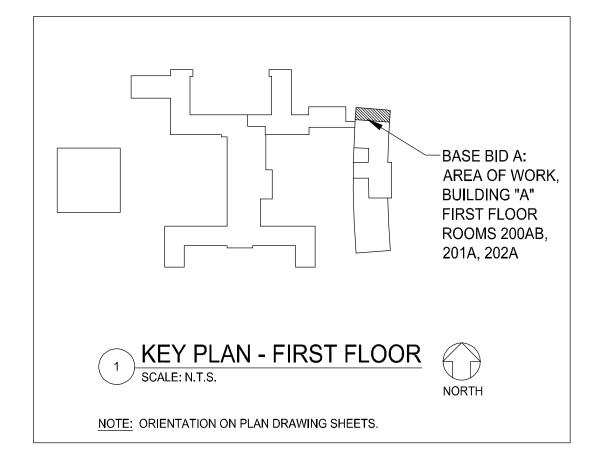

ABBREVIATIONS

A D) /	A DOVE	INICLII	INICHHATION
ABV ALT	ABOVE ALTERNATE	INSUL JB	INSULATION
			JUNCTION BOX
ALUM	ALUMINUM	JT	JOINT
B.BD.	BULLETIN BOARD	LAV	LAVATORY
BETW	BETWEEN	MAU	MAKE-UP AIR UNIT
BITUM	BITUMINOUS	MFGR	MANUFACTURER
BLDG	BUILDING	MECH	MECHANICAL
BUR	BUILT-UP ROOF	MEMB	MEMBRANE
CAT	CATALOG	MET	METAL
СВ	CONCRETE BLOCK	M.O.	MASONRY OPENING
CFM	CUBIC FEET/MINUTE	MTD	MOUNTED
CI	CAST IRON	NO	NUMBER
CLG	CEILING	NOM	NOMINAL
CLOS	CLOSET	OC	ON CENTER
CO	COMPANY	OFF	OFFICE
C.O.	CLEAN OUT	OPNG	OPENING
CONC	CONCRETE	PVC	POLYVINYL CHLORIDE
COND	CONDENSING	RA	RETURN AIR
CONT	CONTINUOUS	RECEP	RECEPTACLE
CORR	CORRIDOR	RI	ROUGH-IN
DET	DETAIL	RM	ROOM
DIA	DIAMETER	R.O.W.	RIGHT-OF-WAY
DWG	DRAWING	SAN	SANITARY SEWER
EL	ELEVATION	SECT	SECTION
ELEC	ELECTRIC	S.G.T.	STRUCTURAL GLAZED TILE
EWC	ELECTRIC WATER COOLER	SIM	SIMILAR
EXIST	EXISTING	STOR	STORAGE
EXP JT	EXPANSION JOINT	ST.	STORM SEWER
EXT	EXTERIOR	TH	THICK
F.E.C.	FIRE EXTINGUISHER CABINET	TK	THICKNESS
FL	FLOW	VCP	VITRIFIED CLAY PIPE
FIN	FINISH	VEST	VESTIBULE
FND	FOUNDATION	V.T.	VITRIFIED
FTG	FOOTING	W.BD.	WHITE BOARD
GA	GAUGE	W.C.	WATER CLOSET
GALV	GALVANIZED	W/O	WITHOUT
G.B.	GRADEBEAM	***	
GYP BD	GYPSUM WALLBOARD		
HC	HANDICAP		
1.0	1.7.41010/1		

HOLLOW METAL

HEIGHT

HT

URRENT DATE: 1/31/2020



LICENSE EXPIRES: 11/30/202

CONSTRUCTION DOCUMENT PHASE

ISSUED FOR BIDDING 3/31/2020


SUE DATE: 1/31/2020 REVISIONS

PROJECT NUMBER: 5899

GENERAL / TITLE SHEET **NOTES**

DWG. NO.

G1

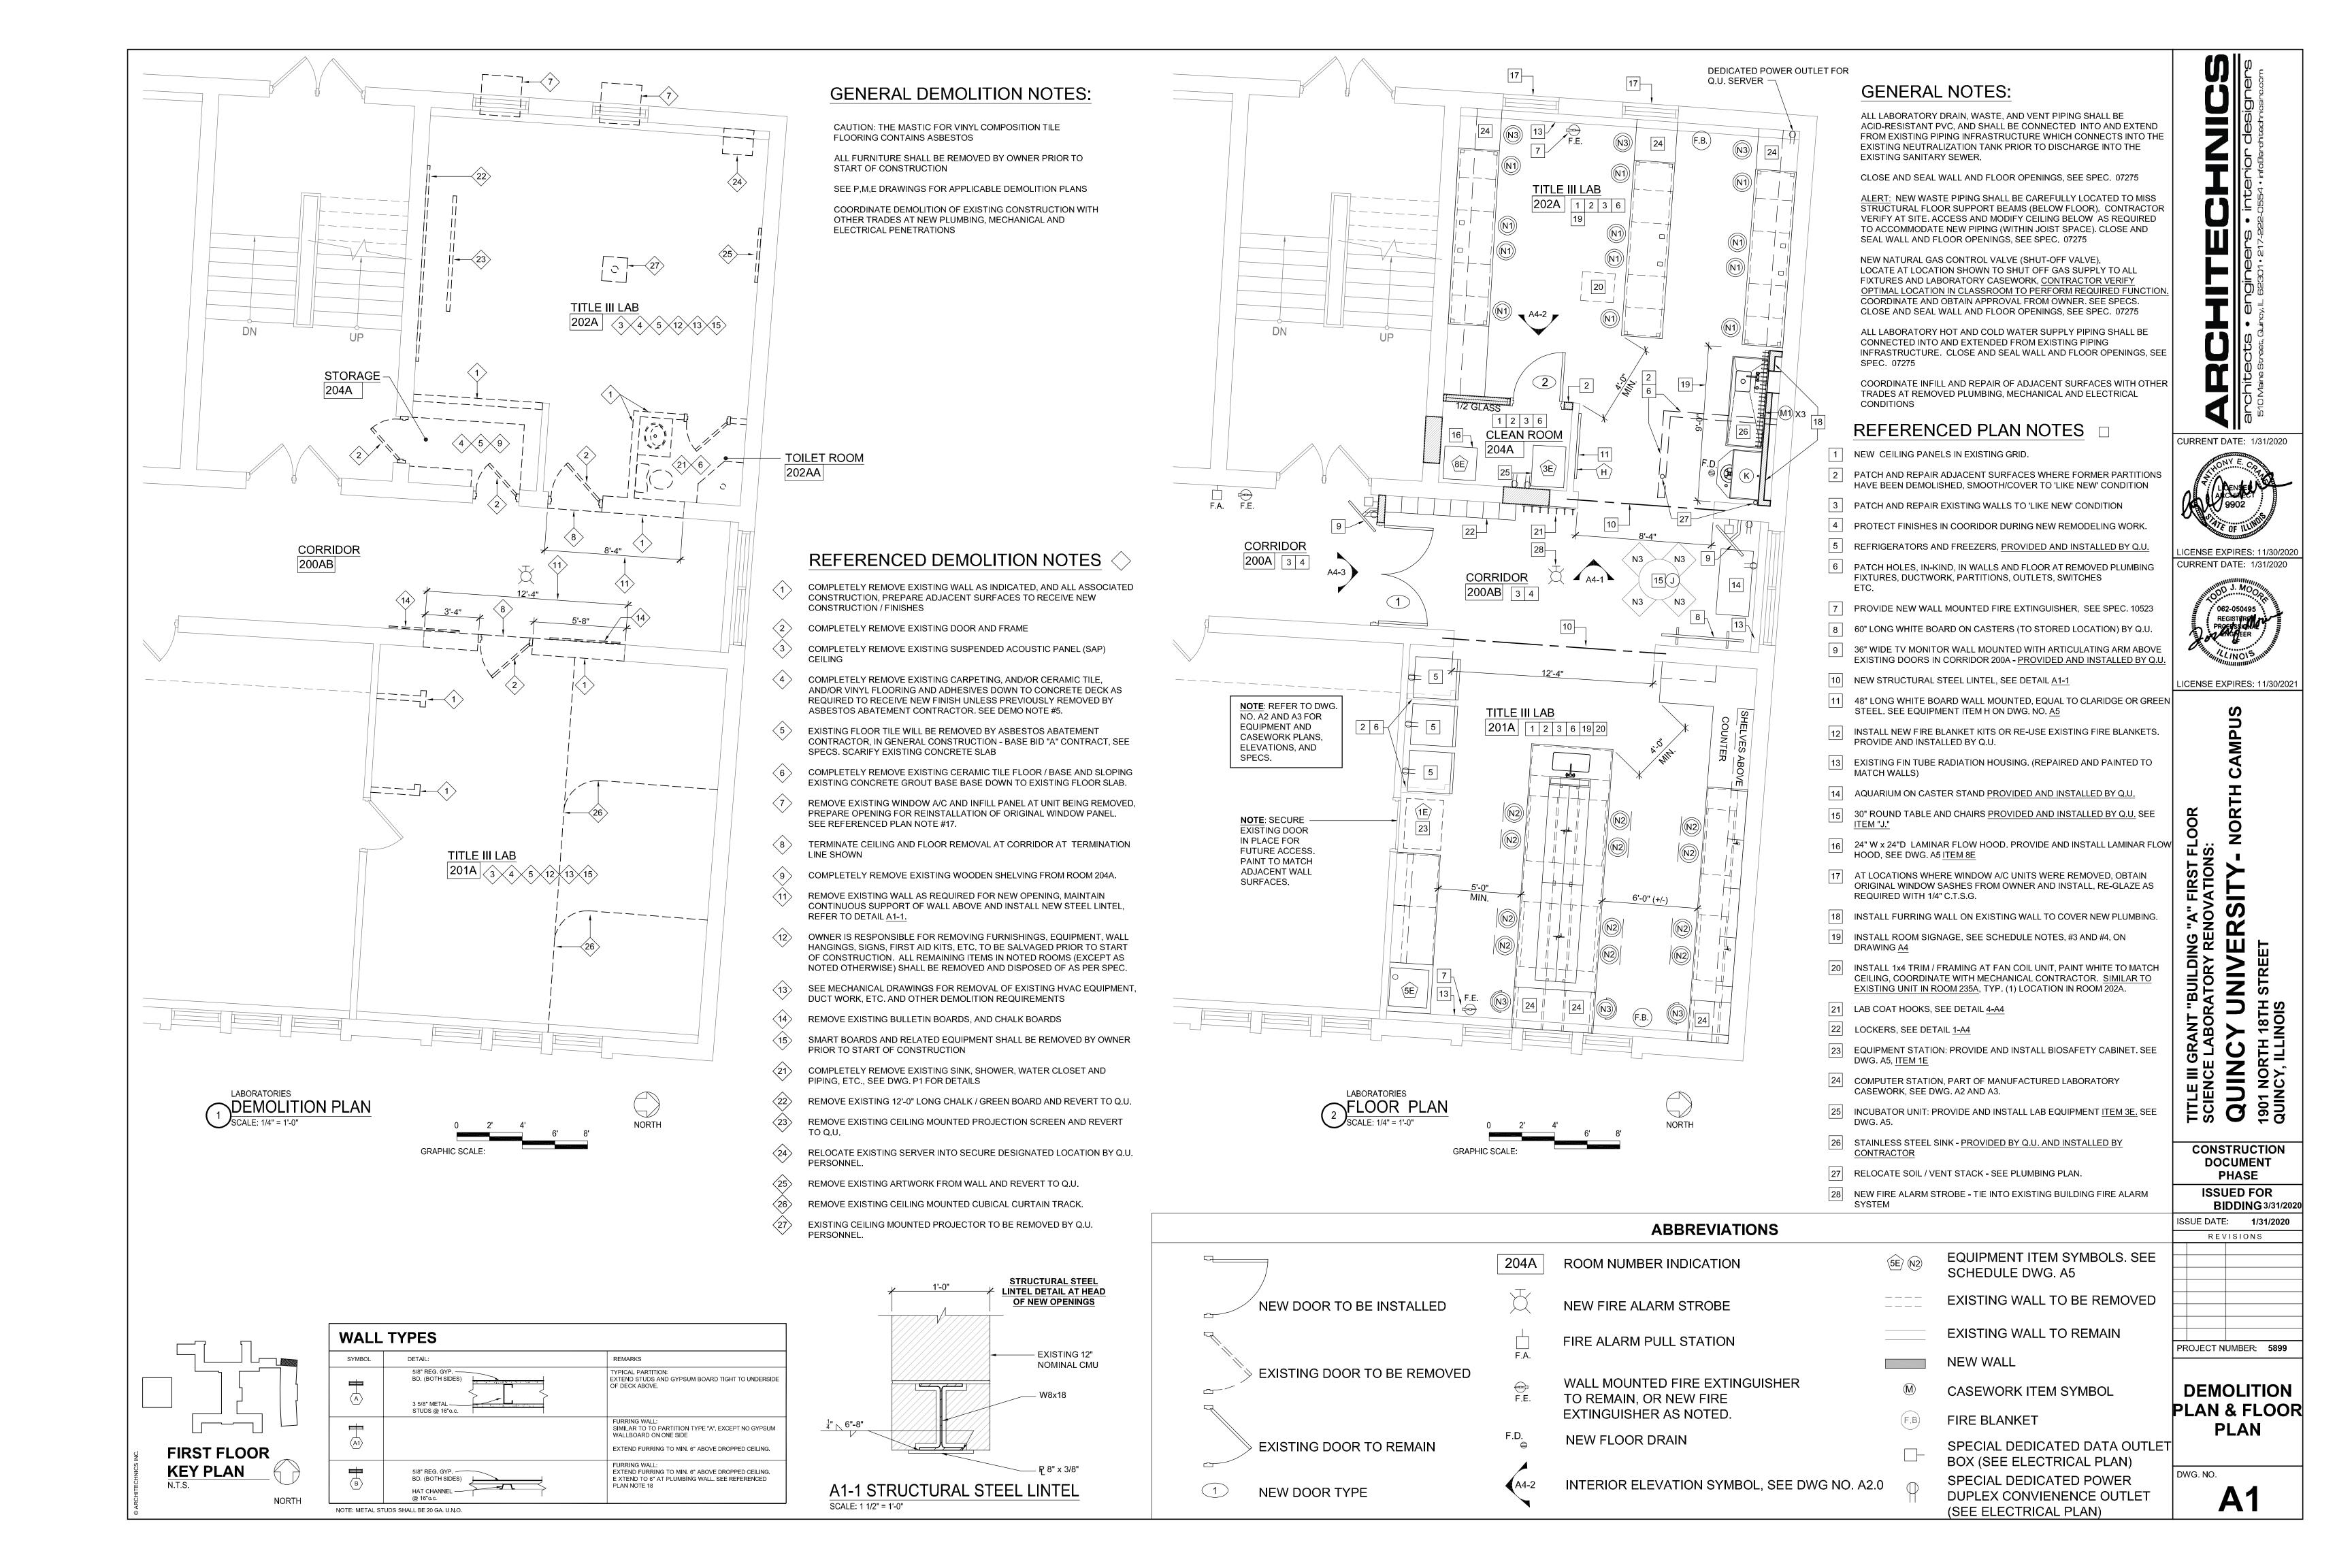

NOTE: MANUFACTURED LABORATORY CASEWORK BASED ON:

FISCHER SCIENTIFIC 300 INDUSTRY DRIVE PITTSBURG, PA 15275 PH: 724-517-1500

GENERAL NOTES: LAB CASEWORK / EQUIPMENT SCHEDULE / LEGEND

ALL COUNTERTOPS TO BE 1" THICK LAB GRADE PHENOLIC RESIN MATERIAL

E633- DECK MOUNT QUAD DOUBLE FACED ELECTRICAL PEDESTAL

L414- DECK MOUNT HCW FAUCET

EW1022- DUAL HEAD HAND HELD EYEWASH W/8' HOSE

SSBF2152- RECESSED EMERGENCY SHOWER/EYEWASH STATION ADA ACCESSABLE

L684- TIN LINED GOOSE NECK DI WATER FAUCET

SBF- SIDE BASER FILLER

FBF- FRONT BASE FILLER

LL-29- 28.5"H X 29"D END SUPPORT PANEL.

LL-22- 28.5"H X 22.5"D END SUPPORT PANEL

ABOVE COUNTER SHELVES TO BE 1" THICK BLACK PHENOLIC RESIN MATERIAL MOUNTED ON BOOK END BRACKETS

L2880-132SWS- 180 DEGREE DECK MOUNT GAS FIXTURE.

ML-6924X49- HEAVY DUTY COUNTER MOUNTED SHELVING ASSEMBLY W/12"D BACK TO BACK SHELVES BOTH SIDES.

UN1000-0*- ADJUSTABLE KNEESPACE PANEL

D50C- 25" X 15" X 10"H BLACK EPOXY RESIN DROP IN SINK W/STRAINER

ALL MEASUREMENTS AND ANGLES TO BE CONFIRMED, INCLUDING FLOORING MATERIAL PRIOR TO START OF PRODUCTION.

APPROVED DRAWINGS AND SUBMITTALS REQUIRED PRIOR TO START OF PRODUCTION

NOTE: REFER TO DWG.NO. A3 FOR CASEWORK ELEVATIONS

LEGEND B/O - BY OWNER WA - WALL ANGLE





UNITED HOSPITAL SUPPLY CORP.
LAB DESIGN * FENCO
PO BOX 1238
4422 ROUTE 130
BURLINGTON, NEW JERSEY 08016
T: (609) 387-7580 * FX: (609) 387-0803
UHSC/Lab Design Website: www.lab-design.com

Fenco Website: www.fencobankequipment.com

NORTH

SORATORY RENOVATIONS:

Y UNIVERSITY - NORTH CAMPUS

18TH STREET

NOIS

ICENSE EXPIRES: 11/30/2020

CURRENT DATE: 1/31/2020

PROJECT NUMBER: 5899

CASEWORK
PLANS

CONSTRUCTION DOCUMENT

PHASE ISSUED FOR


SSUE DATE: 1/31/2020


REVISIONS


BIDDING 3/31/2020

DWG. NO.

SCIENCE LABORATORIES - CASEWORK PLAN / SPECIFICATIONS / SCHEDULES
SCALE: 3/8" = 1'-0"

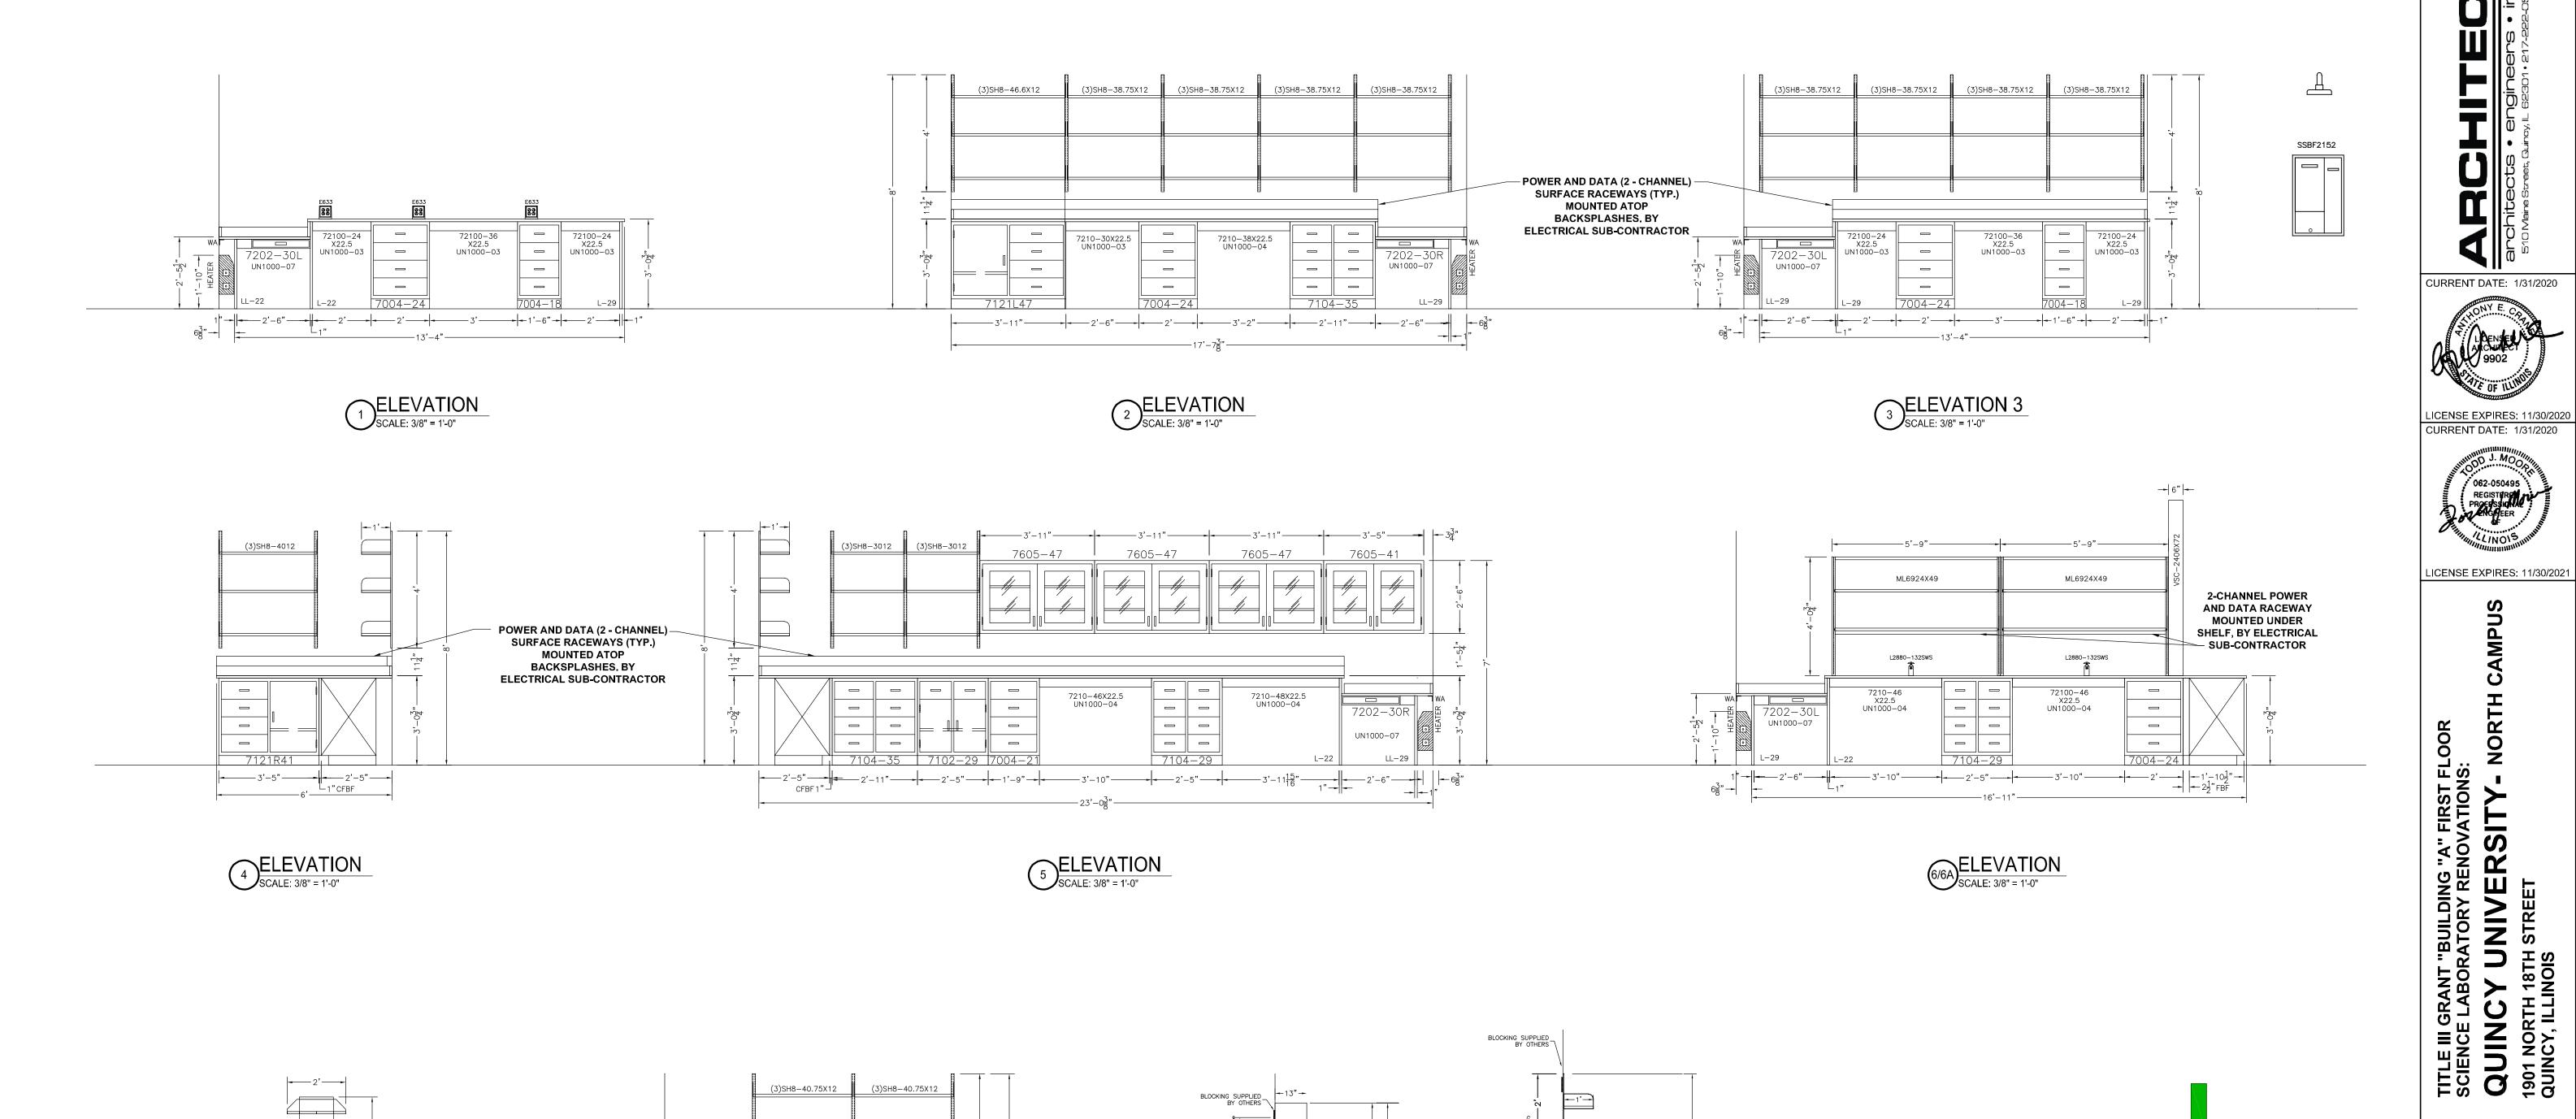

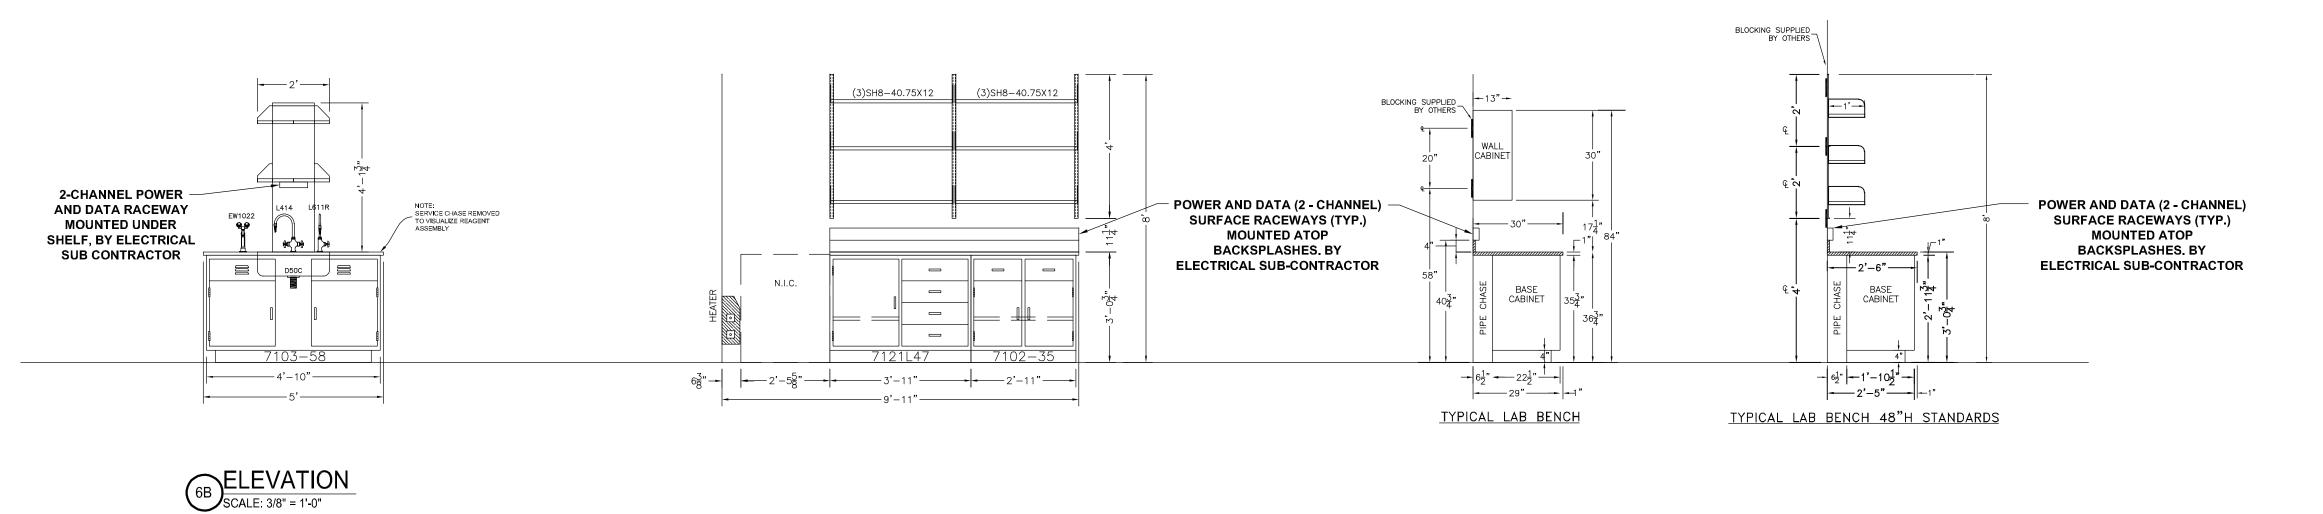

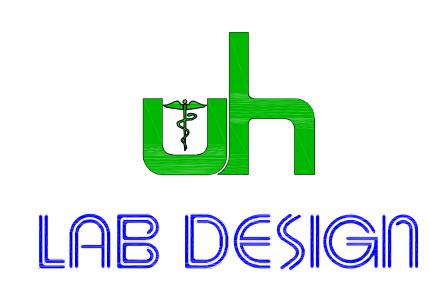



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PO BOX 1238
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UHSC/Lab Design Website: www.lab-design.com

Fenco Website: www.fencobankequipment.com

CASEWORK ELEVATIONS

PROJECT NUMBER: 5899

CONSTRUCTION DOCUMENT PHASE


ISSUED FOR

SSUE DATE: 1/31/2020

REVISIONS

BIDDING 3/31/2020

DWG. NO.

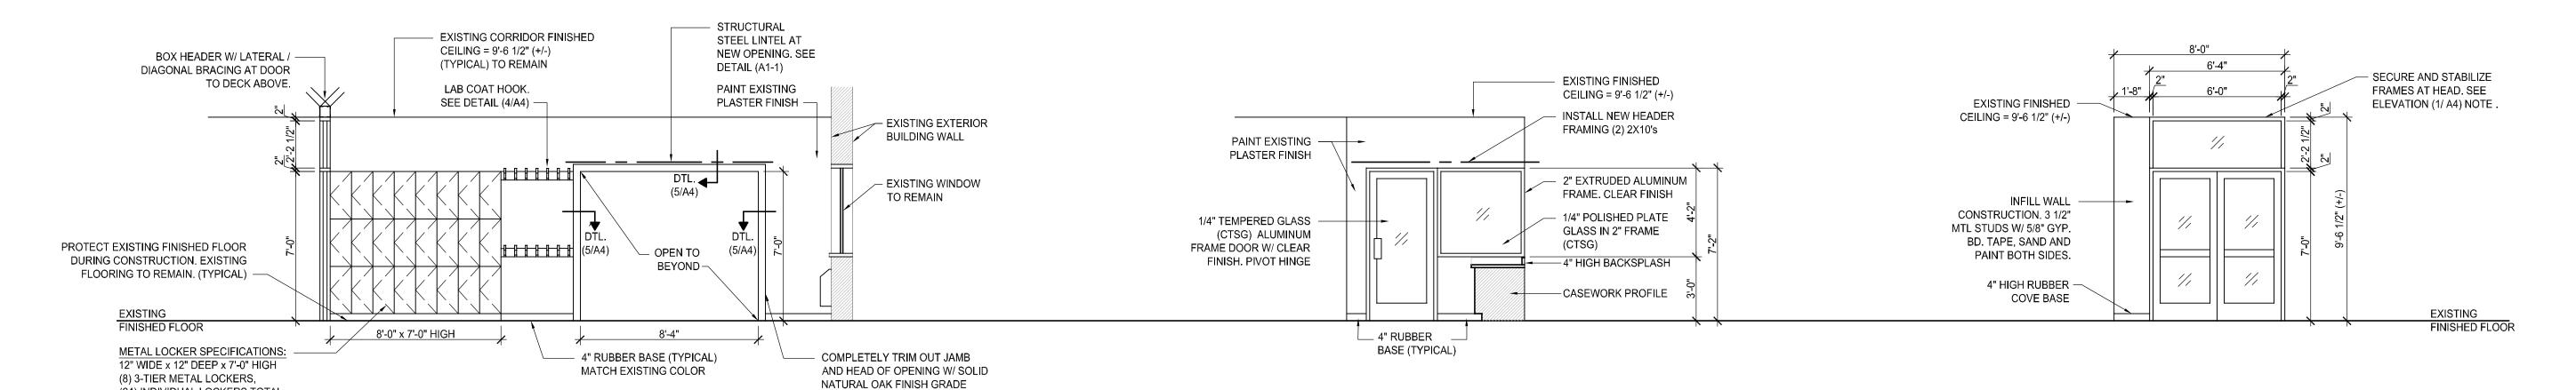

16 ga. FRAME, 16 ga. BODY, 16 ga. BACKS ON 4" HIGH SOLID KICK BASE (CLOSED) ELEVATION @ CORRIDOR WEST WALL

GRAPHIC SCALE:

DOOR SCHEDULE

ALUM.

ALUM.

PREFINISHED

2 PREFINISHED

| MATERIAL | TYPE | FINISH

PREFIN.

PREFIN.

LABORATORIES

ELEVATION @ CLEAN ROOM ENTRANCE

SCALE: 1/4" = 1'-0"

0 2' 4'

LEGEND - ROOM FINISH MATERIALS

GLAZED WALL TILE

GLAZED WALL TILE BASE

GYPSUM WALLBOARD

RUBBER COVE BASE

PORCELAIN FLOOR TILE

STRUCTURAL GLAZED TILE


VINYL COMPOSITION TILE

WOOD WALL PANEL SYSTEM

SUSPENDED ACOUSTIC CEILING

SUSPENDED LINEAR WOOD CEILING

WALL PANEL BASE (BLACK, 4" HIGH)

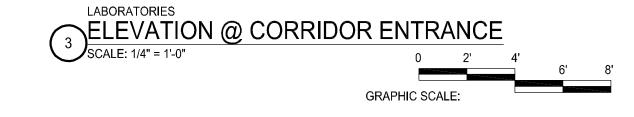

	ROOM FINISH SCHEDULE										
ROOM	DESCRIPTION	FLOOR			WALL		CEILING			DEL 44 DICO	ROOM
NO.	DESCRIPTION	MATERIAL	FINISH	BASE	MATERIAL	FINISH	MATERIAL	FINISH	HEIGHT	REMARKS	NO.
200AB	CORRIDOR	E. CONCRETE	EXISTING	RCB-2 / EXIST.	EXIST. PLAS. / CMU	PT. GI-OP-3L	EXISTING TO REMAIN	PREFIN. / EXIST.	9'-6 1/2"± M.E.	SEE NOTES #1, 2, 3, 4, 5	200AB
204A	CLEAN ROOM	E. CONCRETE	SHEET VINYL 1	RCB-1	EXIST. CMU / NEW GWB	PT. GI-OP-3L	2' X 2' S.A.T., TYPE 1	PRE-FINISHED	9'-6 1/2"± M.E.	SEE NOTES #1, 3, 4, 5	204A
201A	TITLE III LAB	E. CONCRETE	SHEET VINYL 1	RCB-1	EXISTING CMU / NEW AND EXISTING GWB	PT. GI-OP-3L	2' X 2' S.A.T., TYPE 1	PRE-FINISHED	9'-6 1/2"± M.E.	SEE NOTES #1, 2, 3, 4, 5	201A
202A	TITLE III LAB	E. CONCRETE	SHEET VINYL 1	RCB-1	EXISTING CMU / NEW AND EXISTING GWB	PT. GI-OP-3L	2' X 2' S.A.T., TYPE 1	PRE-FINISHED	9'-6 1/2"± M.E.	SEE NOTES #1, 2, 3, 4, 5	202A

WOOD TRIM. MATCH

SEE DETAIL (5/A4)

LABORATORY CASEWORK.

** REFER TO "SCHEDULE NOTES" BELOW **

1 (2) 3'-0" 7'-0" 1-3/4"

2 3'-0" 7'-0" 1-3/4"

DOOR

(24) INDIVIDUAL LOCKERS TOTAL,

PRE-ASSEMBLED, 14 ga. DOOR/

FLAT TOP. COLOR: BEIGE

P.O. BOX 671 AURORA, IL 60507 PH: 800-323-0082

FAX: 630-892-8966

LYON METAL CORPORATION

	ROOM FINISH SCHEDULE										
ROOM	DECODIDETON		FLOOR		WALL	-		CEILING		DEMANDICO.	ROOM
NO.	DESCRIPTION	MATERIAL	FINISH	BASE	MATERIAL	FINISH	MATERIAL	FINISH	HEIGHT	REMARKS	NO.
200AB	CORRIDOR	E. CONCRETE	EXISTING	RCB-2 / EXIST.	EXIST. PLAS. / CMU	PT. GI-OP-3L	EXISTING TO REMAIN	PREFIN. / EXIST.	9'-6 1/2"± M.E.	SEE NOTES #1, 2, 3, 4, 5	200AB
204A	CLEAN ROOM	E. CONCRETE	SHEET VINYL 1	RCB-1	EXIST. CMU / NEW GWB	PT. GI-OP-3L	2' X 2' S.A.T., TYPE 1	PRE-FINISHED	9'-6 1/2"± M.E.	SEE NOTES #1, 3, 4, 5	204A
201A	TITLE III LAB	E. CONCRETE	SHEET VINYL 1	RCB-1	EXISTING CMU / NEW AND EXISTING GWB	PT. GI-OP-3L	2' X 2' S.A.T., TYPE 1	PRE-FINISHED	9'-6 1/2"± M.E.	SEE NOTES #1, 2, 3, 4, 5	201A

LEGEND - DOOR TYPE/MATERIAL

FPBC	FLUSH PARTICLE BOARD CORE DOOR, SEE SPEC. SECTION 08211.
FMC	FLUSH MINERAL CORE DOOR, SEE SPEC. SECTION 08211.
FHM	FLUSH HOLLOW METAL DOOR, SE SPEC SECTION 08111.
FHM-L	FLUSH HOLLOW METAL DOOR - LABELED, SEE SPEC. SECTION 08111.
IG	INSULATED GLASS
PT	PORCELAIN TILE
SGT	STRUCTURAL GLAZED TILE
CTSG	CLEAR TEMPERED SAFETY GLASS
WWP	WOOD WALL PANEL SYSTEM

WALL PANEL BASE (BLACK, 4" HIGH)

GWTB

GWB

PFT

RCB


SAT

SLWC

SGT

VCT

WWP

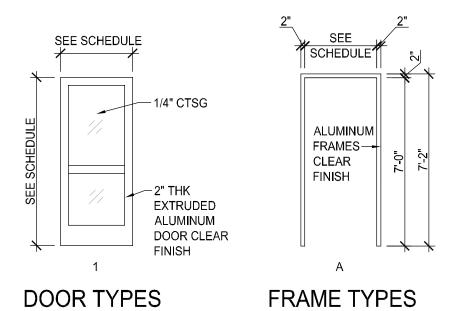

DOOR

ALUM.

NUMBER WIDTH HEIGHT THICK MATERIAL TYPE

SCHEDULE NOTES:

U.L. HARDWARE

LABEL SET

REMARKS

CLASSROOM STANDARD KEYED CORE TO MATCH Q.U. SYSTEM

STOREROOM NO KEYED LOCK REQUIRED

1. SHEET VINYL FLOORING IS ARMSTRONG COMMERCIAL FLOORING; COLORS TO MATCH PREVIOUS PHASE REMODELING PROJECTS AT Q.U. NORTH CAMPUS. COLOR #1 = ARMSTRONG 'MEDINTECH', GARDEN SAGE #88455 AND COLOR #2: (PATCH COLOR #2 AT CORRIDOR / CLASSROOM JOINT AS REQUIRED.) "RAFFIA" WARM WHEAT #55808


DOOR

NUMBER

- 2. PROVIDE NEW 2" ALUM. WINDOW BLINDS ON ALL WINDOWS IN INDICATED ROOMS, SEE SPEC 12505 HUNTER DOUGLAS #H2TN, COLOR: 269 "CHENILLE"
- 3. PROVIDE ONE (1) NEW ROOM SIGN ADJACENT TO EACH DOOR OF ROOMS NOTED ON PLAN, SEE SPEC. 10445:


RM. NO.	ROOM NAME	QUANTITY
200AB	CORRIDOR	1
204A	CLEAN ROOM	1
201A	TITLE III LAB	1
202A	TITLE III LAB	1

- 4. ROOM SIGNS SHALL MATCH SIGNS FROM PREVIOUS PHASED DEVELOPMENT FOR COMMON AREA RENOVATIONS @ NORTH CAMPUS BUILDING "A".
- 5. INSTALL NEW 2'X2' CEILING TILE PANELS IN EXISTING SUSPENSION GRID. EXTEND, MODIFY AND ADAPT GRID WITH NEW COMPONENTS AS REQUIRED FOR COMPLETE INSTALLATION.

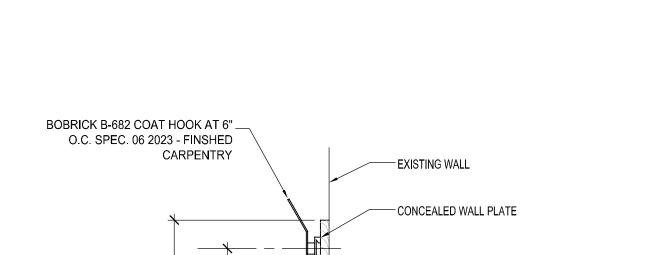

TOP PLATE @ 7-0" A F F

DETAIL @ COAT HOOK - CORRIDOR 200AB
SCALE: 1 1/2" = 1'-0"

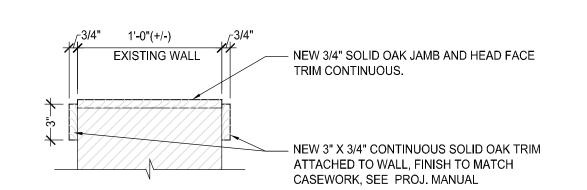


— 5" X 3/4" CONTINUOUS OAK STRIP ATTACHED TO WALL, FINISH TO MATCH

CASEWORK, SEE PROJ. MANUAL


DETAIL @ OPENING WOOD TRIM, JAMBS AND HEAD

SCALE: 1 1/2" = 1'-0"

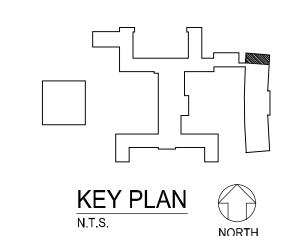

CURRENT DATE: 1/31/2020

ICENSE EXPIRES: 11/30/2020 CURRENT DATE: 1/31/2020

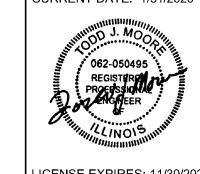

LICENSE EXPIRES: 11/30/2021

TITLE III GRANT "BUILDING "A" FIRST FLOOR SCIENCE LABORATORY RENOVATIONS:

QUINCY, ILLINOIS

DOCUMENT PHASE **ISSUED FOR**

CONSTRUCTION

BIDDING 3/31/2020 SSUE DATE: 1/31/2020 REVISIONS

PROJECT NUMBER: 5899

ELEVATIONS, SCHEDULES, **DETAILS**

DWG. NO.

A4

			MODEL#	QUANTITY	NOMI	NAL DIMEN	SIONS	DEMARKS / FOURMENT
ITEM	DESCRIPTION	BRAND			HEIGHT	LENGTH WIDTH	DEPTH	REMARKS / EQUIPMENT
H	DRY-ERASE WHITE BOARD WITH MARKER HOLDER			1	36"	48"		EQUAL TO CLARIDGE OR GREEN STEEL
J	CLASSROOM LAB TABLE			1	30"			30" ROUND TABLE - PROVIDED BY Q.U.
K	EYEWASH/ SHOWER STATION	KEWAUNEE	G85W902236-0	1	90"	36"	22"	EYEWASH UNIT & 10" D STAINLESS BOWL/ DRAIN, SAFETY SHOWER, ATTACH TO WALL
M1)	TEST TUBE DRYING RACK	KEWAUNEE	X-020004	3	30"	24"	3/4"	
N1)	ADJUSTABLE LAB STOOL	BIOFIT	1G65 TXG 2025	12	20"-25"	36"	24"	BIOFIT ENGINEERED PRODUCTS (800) 597-0246 OR THRU GLEN ALSPAUGH CO. (314) 993-6644
N2	ADJUSTABLE LAB STOOL W/ BACK	BIOFIT	1G65 TXG 2025 W/ BACK	12	20"-25"			BIOFIT ENGINEERED PRODUCTS (800) 597-0246 OR THRU GLEN ALSPAUGH CO. (314) 993-6644
N3	CLASSROOM CHAIR			10	18"			PROVIDED BY OWNER

NOTE: CASEWORK SPECIFIED AS <u>WOOD</u> FOR BASE BID "A", AND <u>PAINTED METAL</u> FOR BASE BID "B"

COLOR FOR WOOD SHALL BE "NATURAL OAK." COLOR FOR BASE BID "B" SHALL BE MANUFACTURER STANDARD COLOR "BEIGE"

ALL REQUIRED HANDLES, LOCKS, PULLS, HARDWARE, FILLERS, TRIMS, SHIMS AND RUBBER BASE MOLDING. OTHER EQUAL PRODUCTS: AS LISTED BELOW: SEE SPEC. 12300

STEVENS INDUSTRIES, INC. DIVERSIFIED WOODCRAFTS, INC. LSI CORPORATION OF AMERICA, INC. SARGENT-WELCH CAMPBELL RHEA / MOHON INTERNATIONAL KEWAUNEE SCIENTIFIC CORP. SCIENCE AND TECHNOLOGY 704 WEST MAIN STREET 300 S. KRUGER STREET P.O. BOX 4130 P.O. BOX 550 2100 XENIUM LANE **TEUTOPOLIS, IL 62467 SURING, WI 54174** BUFFALO, NY 14217 **PARIS, TN 38242** MINNEAPOLIS, MN 55441 217-540-3100 PHONE 920-842-2136 PHONE 800-727-4368 PHONE 731-642-4251 PHONE 763-559-4664 PHONE 217-540-3378 FAX 920-842-5420 FAX 800-676-2570 FAX 731-642-4262 FAX 763-559-4395 FAX WWW.STEVENSIND.COM WWW.DIVERSIFIEDWOODCRAFTS.COM WWW.LSI-CASEWORK.COM WWW.SARGENTWELCH.COM WWW.CAMPBELLRHEA.COM

LEONARD PETERSON & CO., INC. FISCHER / HAMILTON INDUSTRIES FISCHER SCIENTIFIC HAMILTON LABORATORY EQUIPMENT P.O. BOX 2277 **1316 18TH STREET** 300 INDUSTRY DR. 825 EAST ALBERT DRIVE **AUBURN, AL 36831** TWO RIVERS, WI 54241 PITTSBURGH, PA 15275 MANITOWOC, WI 54220 334-821-6832 PHONE 920-793-1121 PHONE 724-517-1500 PHONE 920-657-1970 PHONE 334-821-5904 FAX 920-793-3084 FAX WWW.FISHERSCI.COM 920-657-1976 FAX WWW.LPCO.COM WWW.FISCHERHAMILTON.COM

	EQUIPMENT SCHEDULE											
ITENA	DESCRIPTION	BRAND		QUANTITY	NOMIN	NAL DIMEN		REMARKS / EQUIPMENT				
ITEM			MODEL #		HEIGHT	LENGTH WIDTH	DEPTH	NEMANNS / EQUIPMENT				
(1E)	BIO SAFETY CABINET	"LABCONCO"	302411101	1	90"	48"	28"	PROVIDE WITH BASE STAND AND ACCESSORIES PACKAGE				
(3E)	INCUBATOR	"THERMO SCIENTIFIC"	IGS180	2	32"	29.1"	25.2"	PROVIDE STACKING HARDWARE AS REQUIRED, POWER SUPPLY, 120 60 Hz, PLUG TYPE NEMA 5-15				
	NEW VENT HOOD - DUCTLESS	"LABCONCO"		1	30"	28"	30.2"	DUCTLESS VENT / FUME HOOD				
(5E)	VENT HOOD - BASE STAND	OR	3746701	1	34.5"	30"	29"					
	VENT HOOD - WORK SURFACE	EQUAL	4882805	1	1.25"	36"	30"					
(8E)	LAMINAR FLOW HOOD W/ HEPA FILTER AND PRE FILTERS AND HEAVY DUTY BASE STAND	"LABCONCO," "FLOW," OR EQUAL		1	35"	24"	24"	SUGGESTED SIZE BASED ON AVAILABLE SPACE ALLOTED FOR EQUIPMENT				

CURRENT DATE: 1/31/2020


P.O. BOX 1842

704-873-7202 PHONE

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800-932-3296 FAX

STATESVILLE, NC 28687-1842

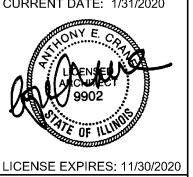

CURRENT DATE: 1/31/2020

LICENSE EXPIRES: 11/30/2021

TITLE III GRANT "BUILDING "A" FIRST FLOOR SCIENCE LABORATORY RENOVATIONS:

QUINCY, ILLINOIS

CONSTRUCTION DOCUMENT PHASE

ISSUED FOR BIDDING 3/31/2020 REVISIONS


SSUE DATE: 1/31/2020


PROJECT NUMBER: 5899

EQUIPMENT SCHEDULES / **DETAILS**


DWG NO


A5

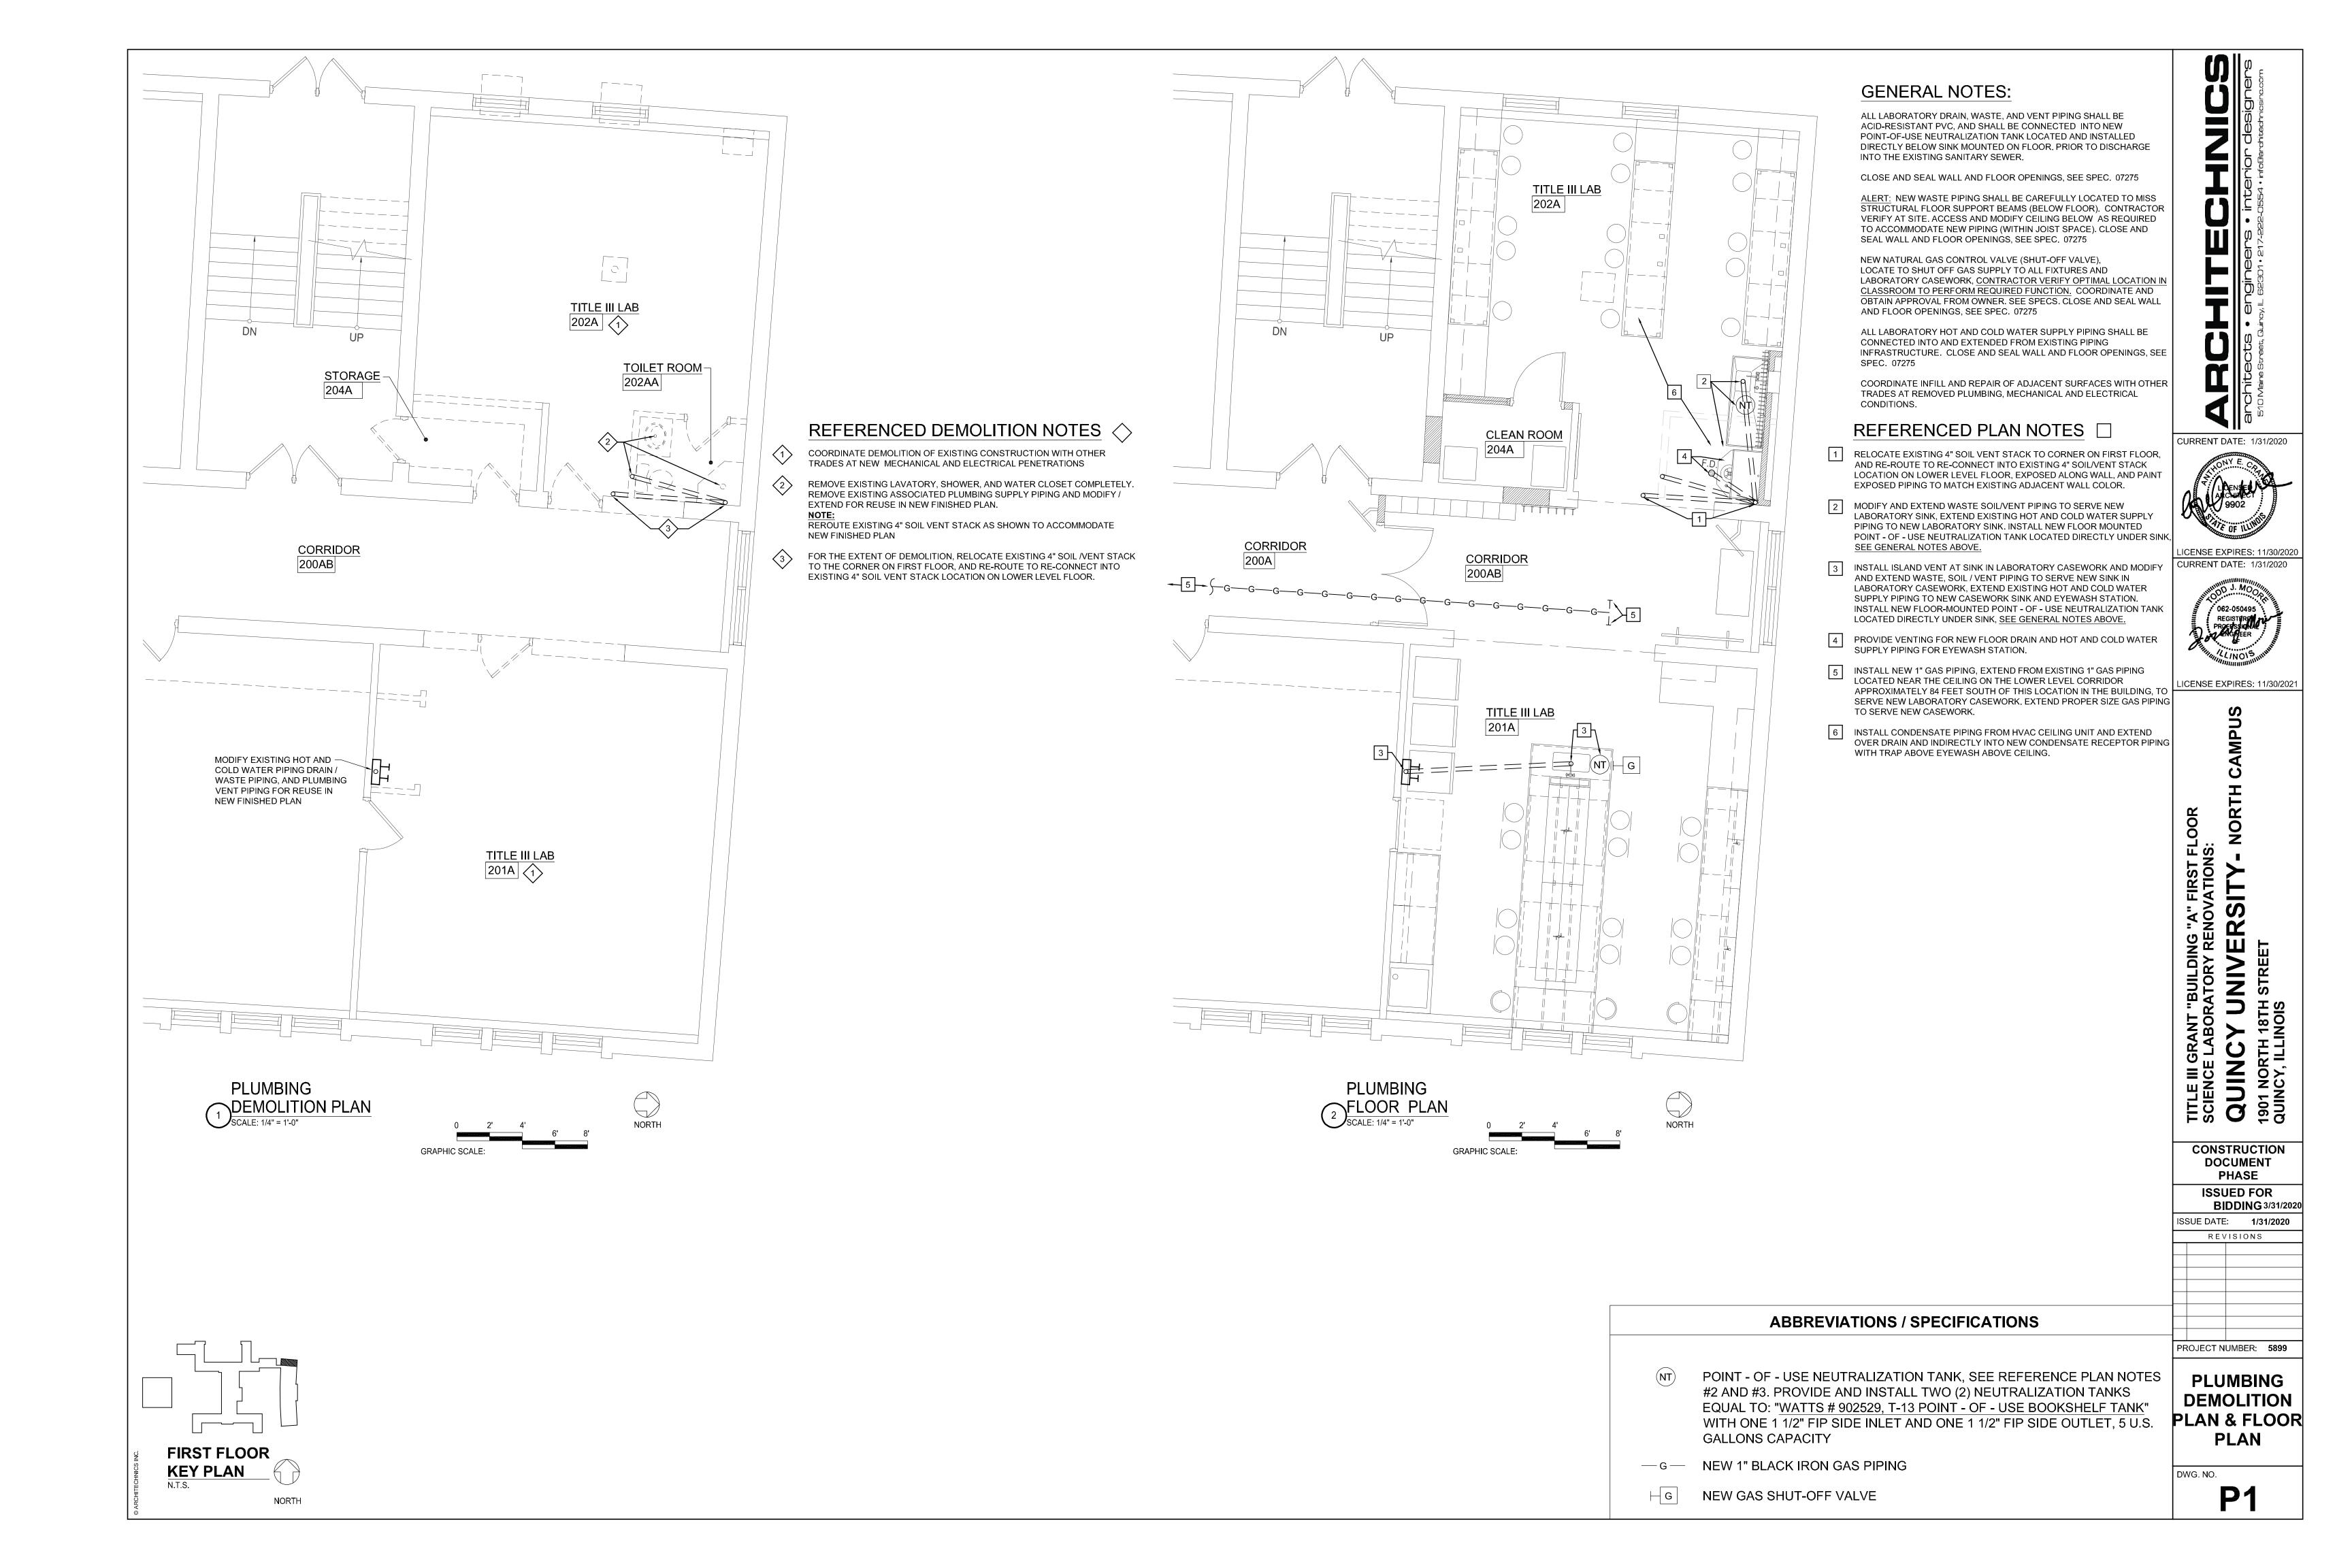

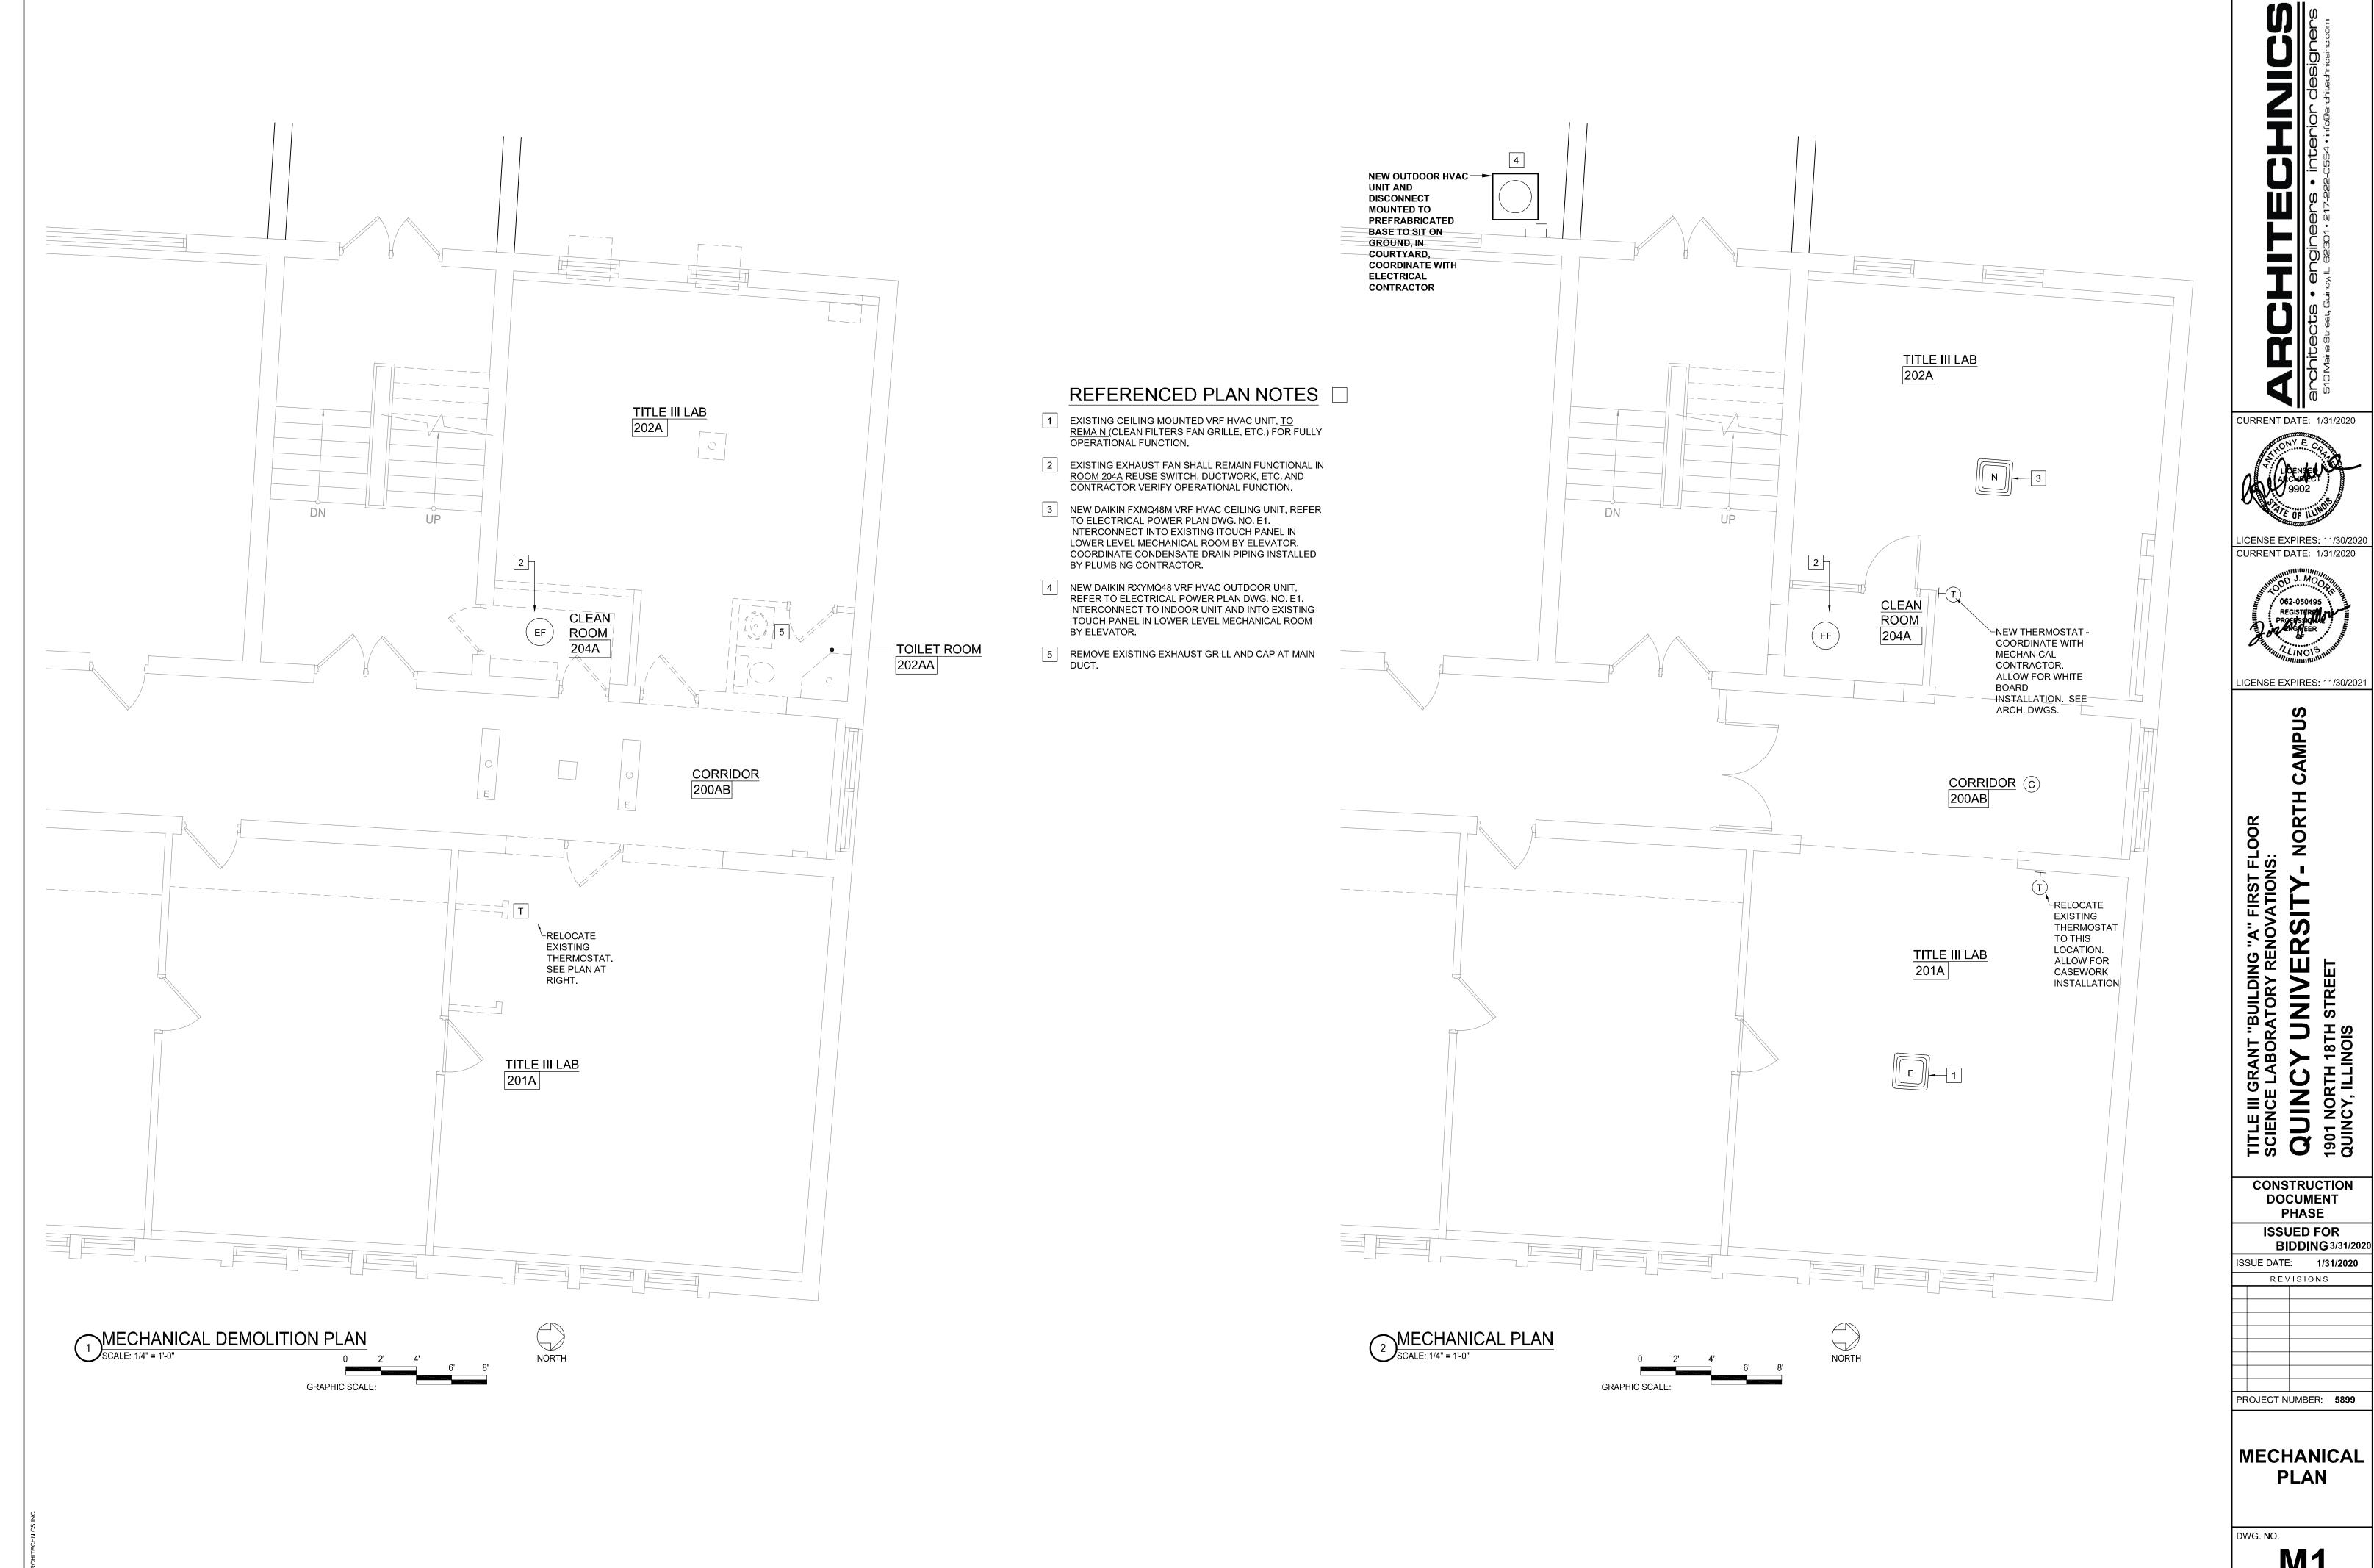

M1

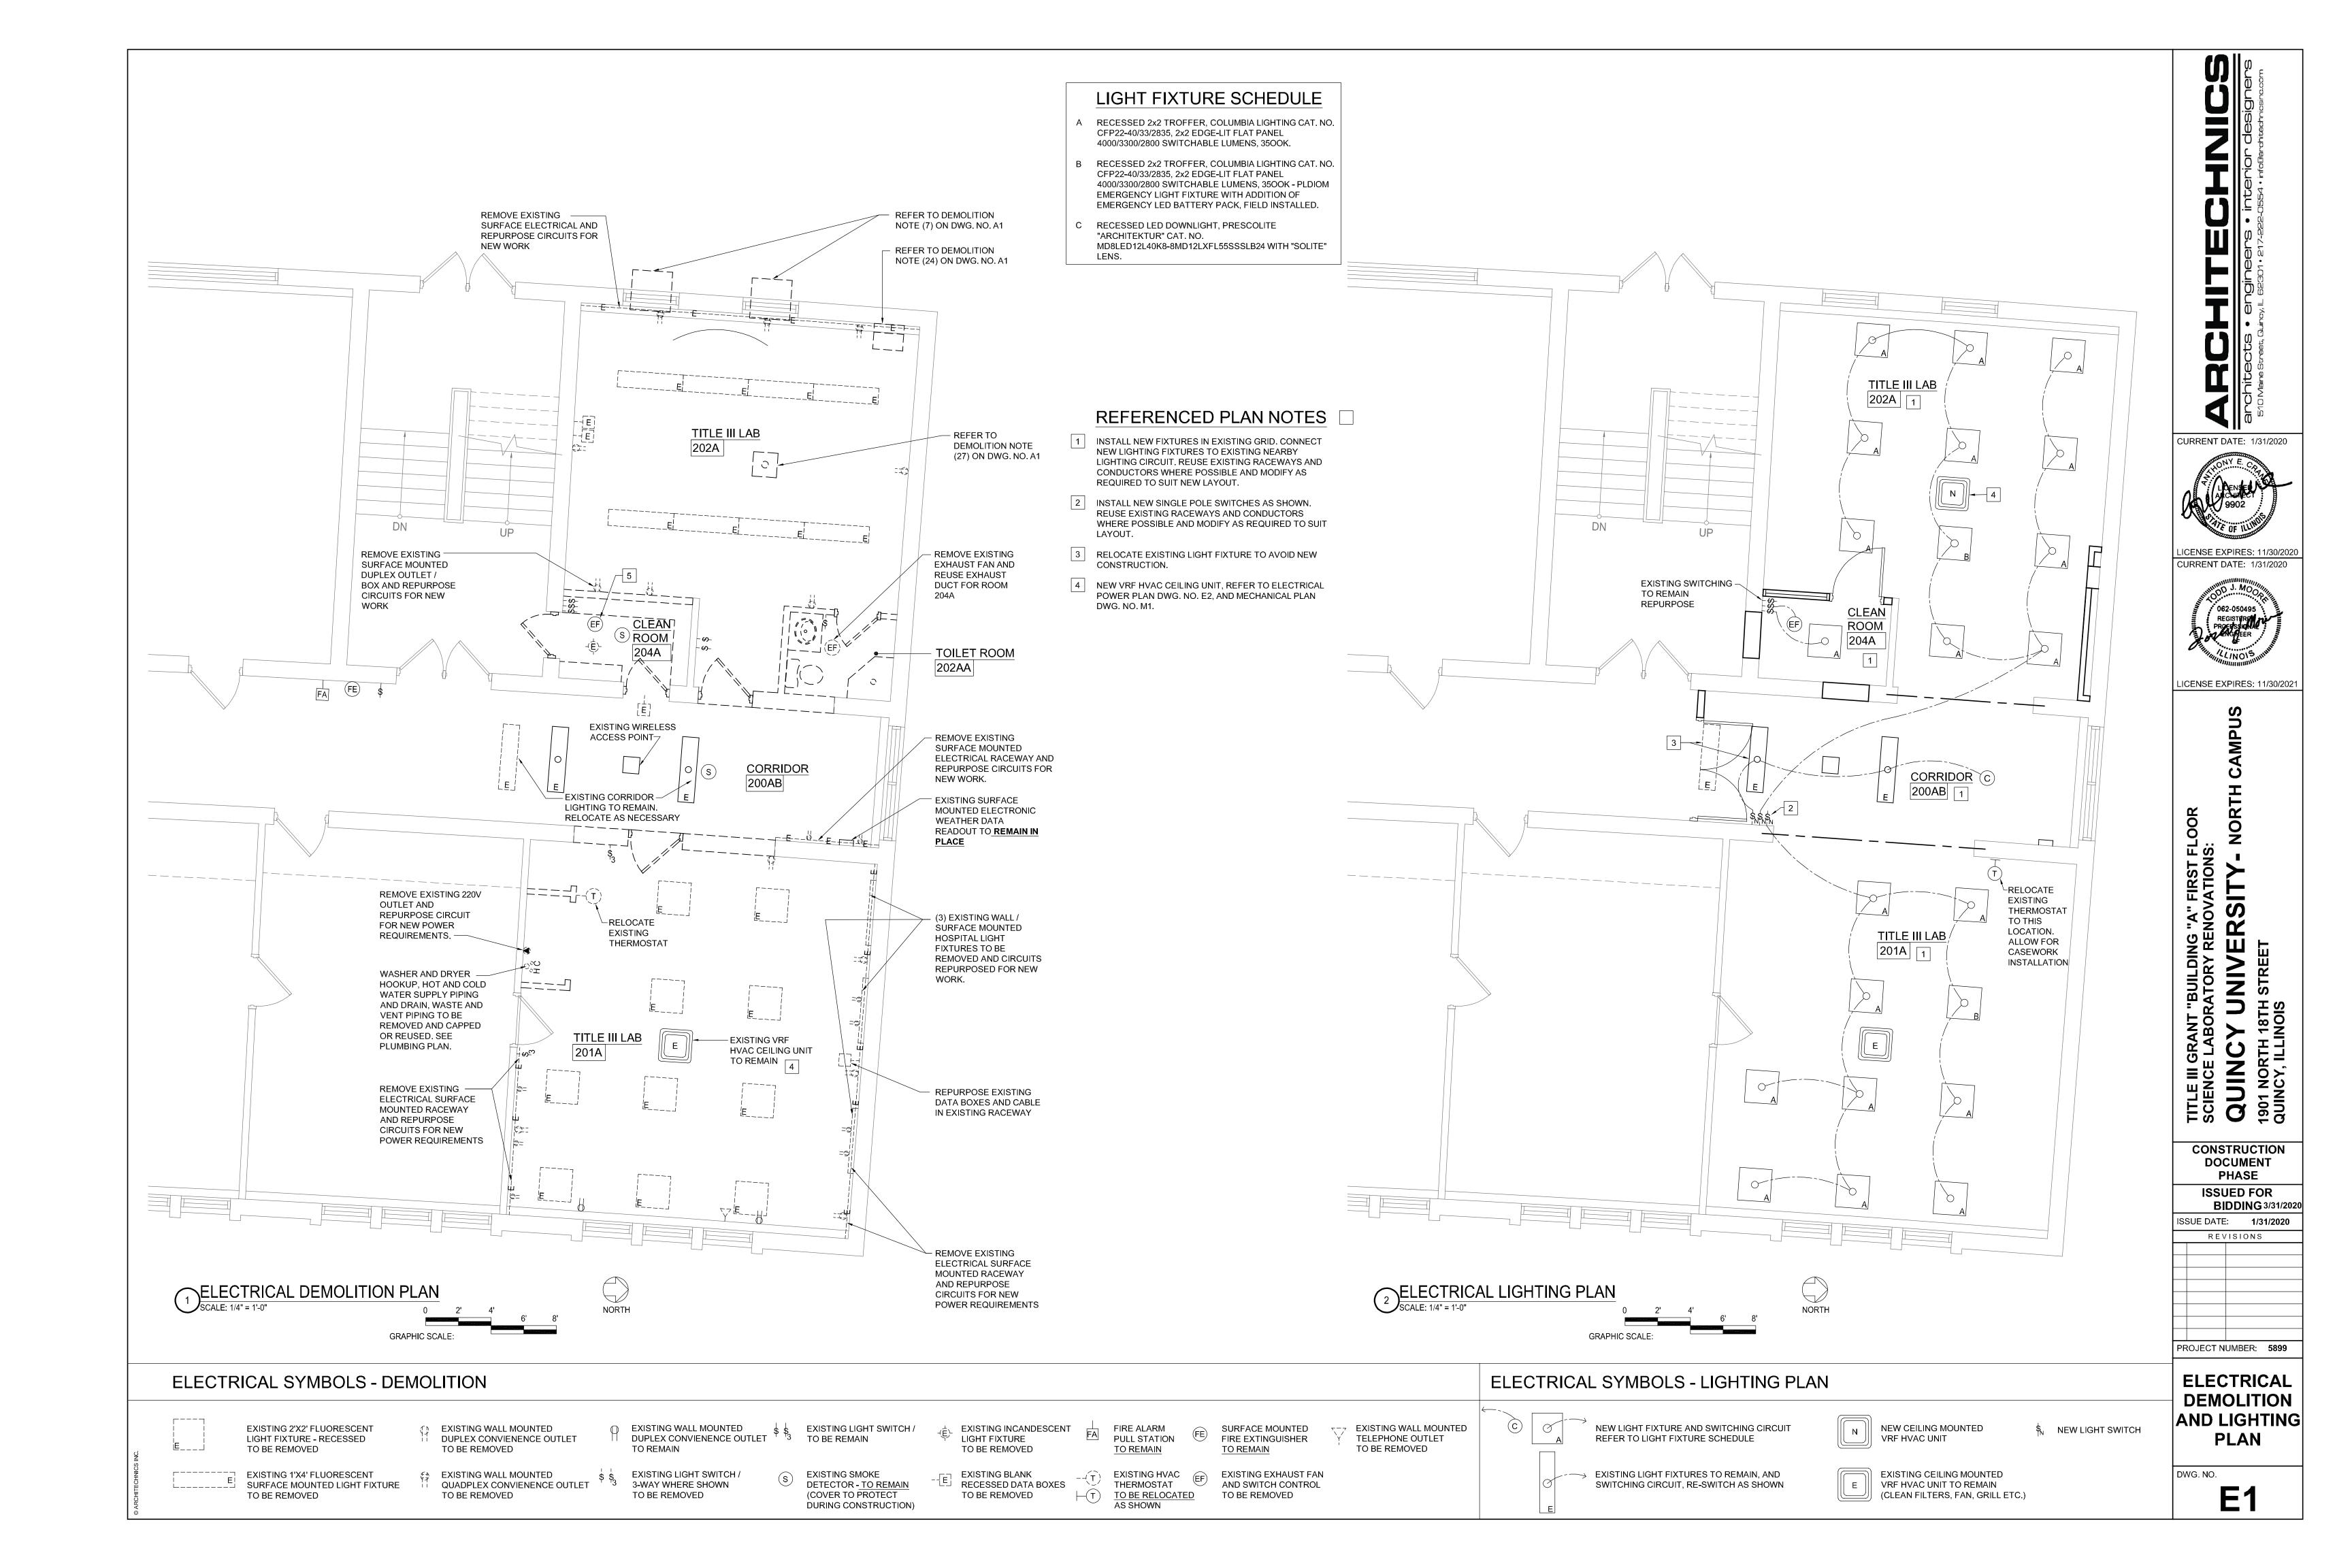

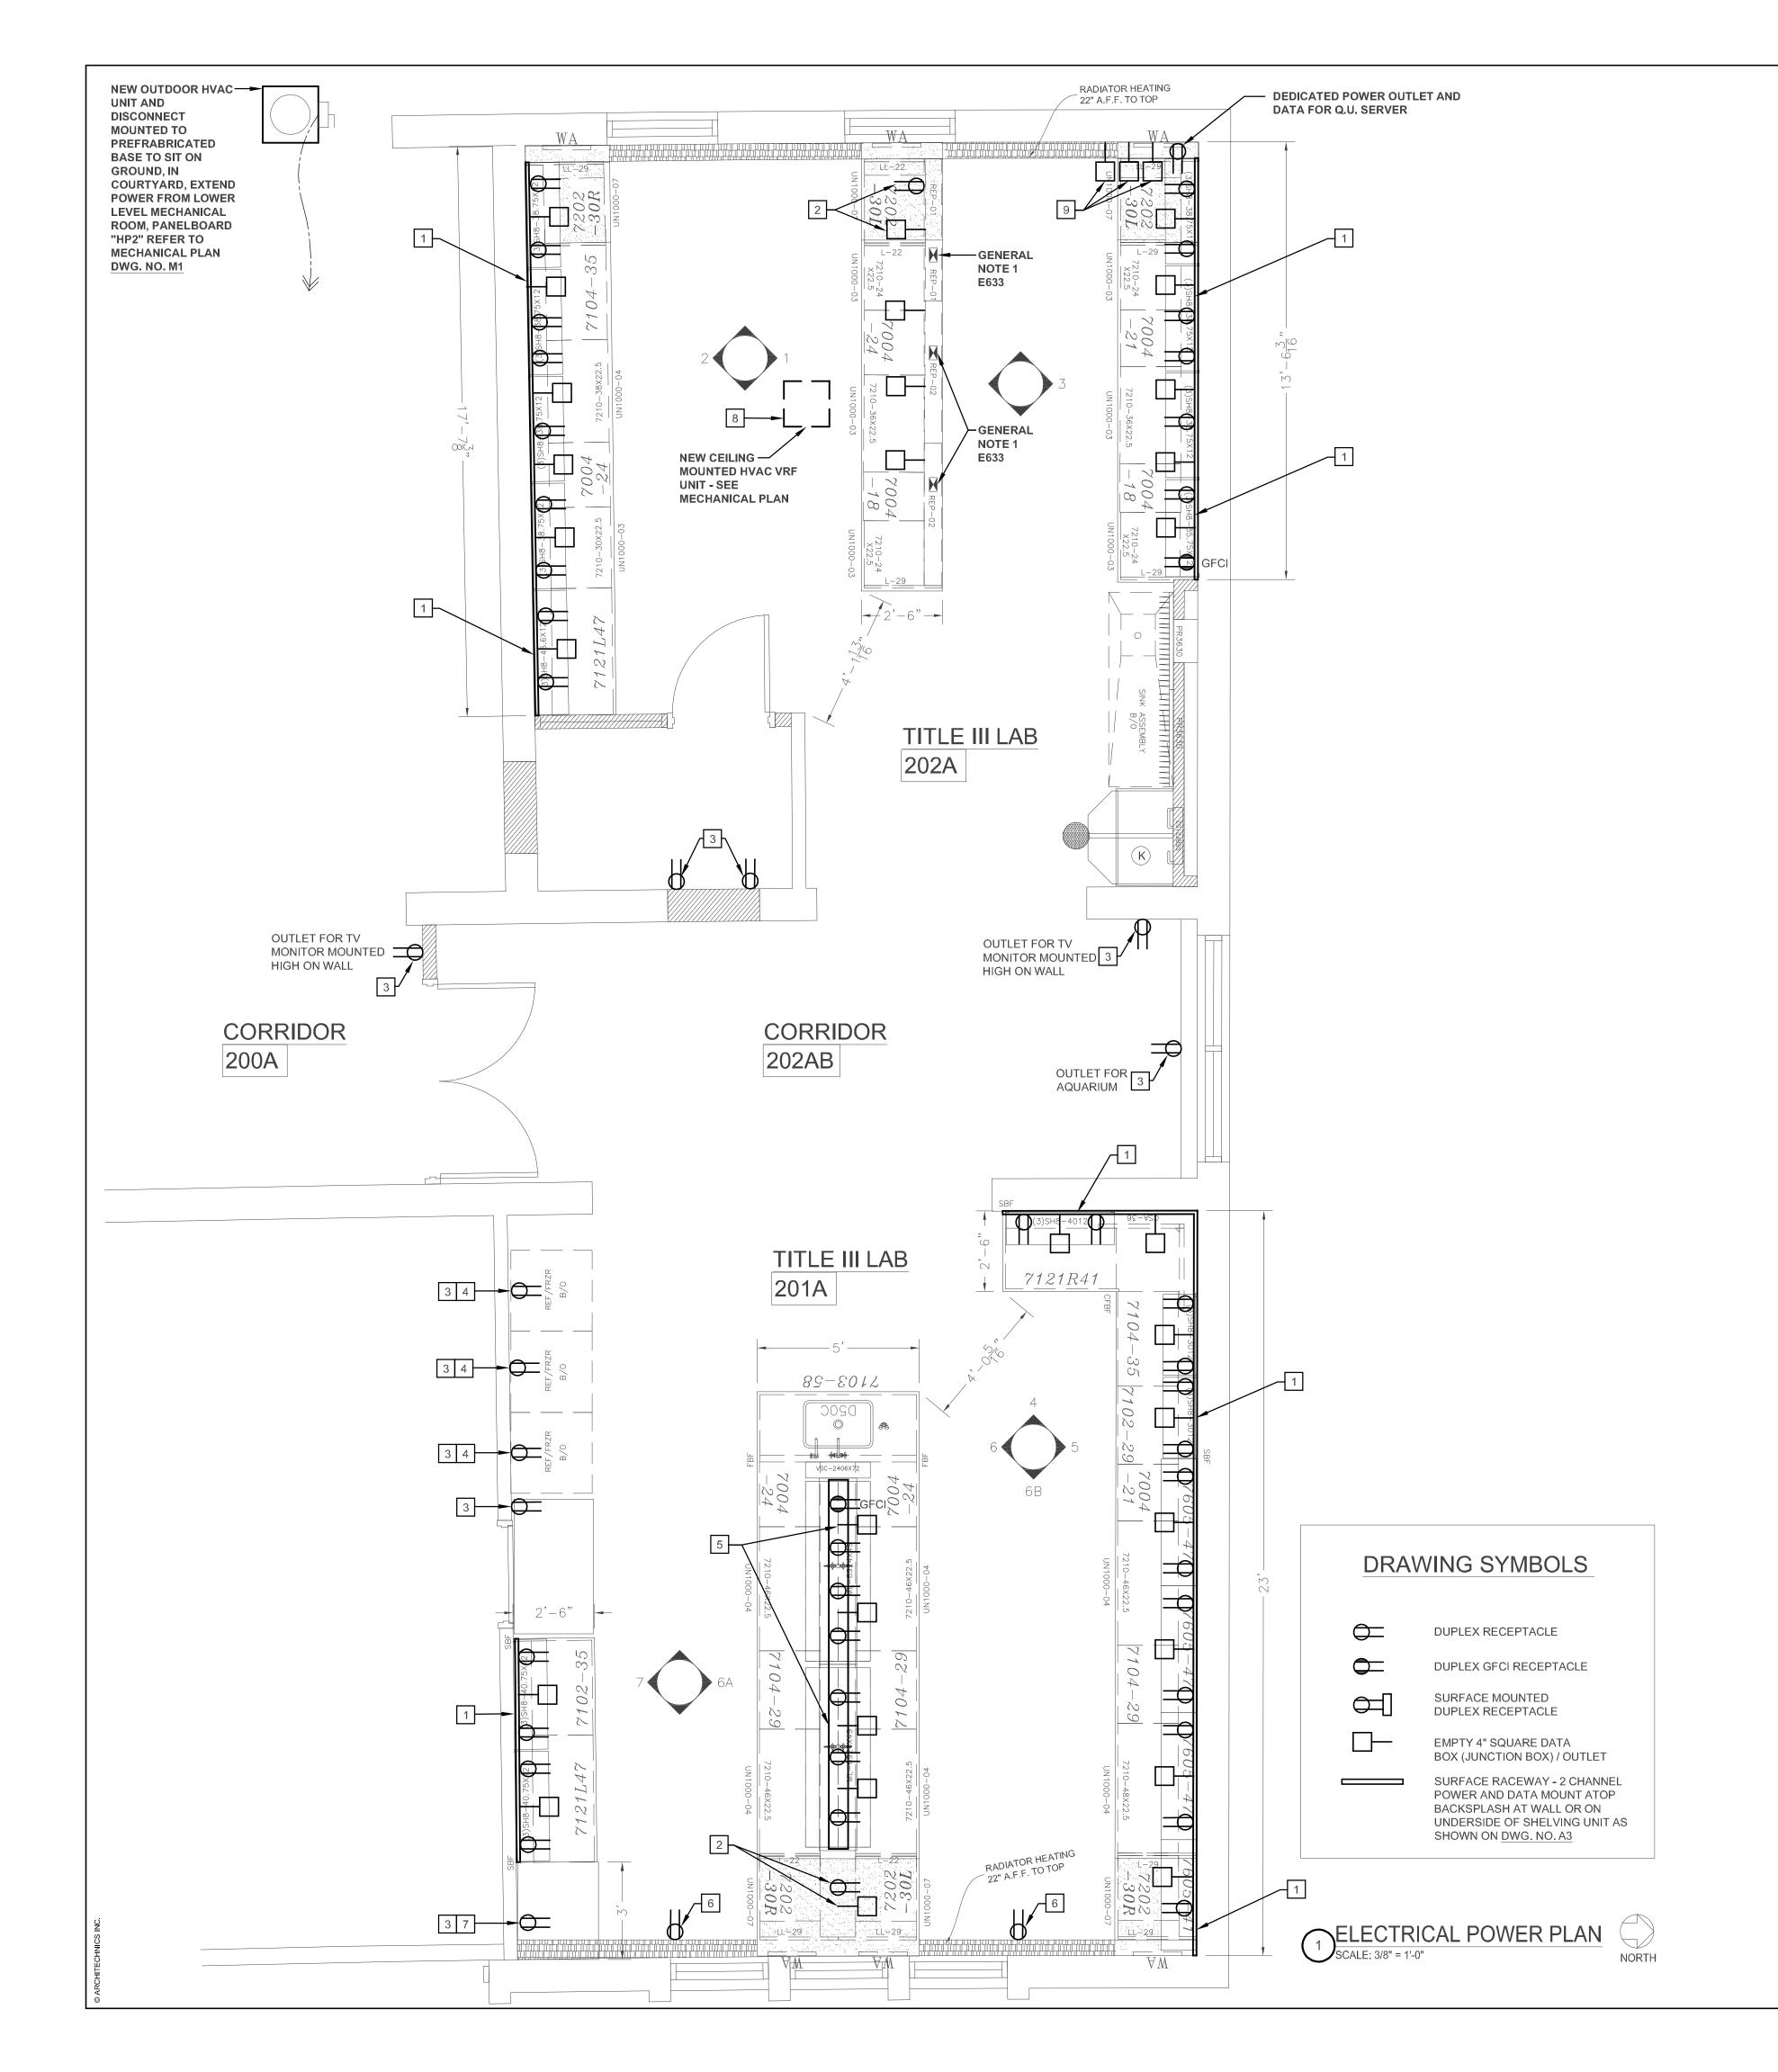

GENERAL NOTES

1. E633- DECK MOUNT QUAD DOUBLE FACED ELECTRICAL PEDESTAL SUPPLIED WITH CASEWORK. CONTRACTOR TO INSTALL POWER CIRCUITS ACCORDINGLY

REFERENCED PLAN NOTES

- NEW SURFACE RACEWAY INSTALLED ON WALL ABOVE BACKSPLASH. CONNECT RECEPTACLES TO NEW DEDICATED CIRCUIT FROM EXISTING ABANDON CIRCUITS. REUSE EXISTING BREAKER IF NECESSARY, INSTALL CONDUIT TO SURFACE RACEWAY ON FACE OF WALL FROM CEILING SPACE ABOVE. PAINT CONDUIT TO MATCH WALL.
- (1) RECESSED DUPLEX DESK MOUNTED RECEPTACLE AND DATA BOX OUTLET. POWER OUTLET CONNECTED TO FORMER COUNTER RECEPTACLE CIRCUIT. REUSE EXISTING BREAKER, RACEWAYS AND CONDUCTORS WHERE POSSIBLE AND MODIFY AS REQUIRED TO SUIT NEW LAYOUT.
- NEW RECEPTACLE FOR EQUIPMENT POWER TO BE CONNECTED TO NEW DEDICATED CIRCUIT FROM EXISTING ABANDON CIRCUITS. INSTALL NEW 20A, 1-P BREAKER OR REUSE EXISTING BREAKER IF NECESSARY. CONDUIT TO SURFACE BOX INSTALLED WALL MOUNTED FROM EXISTING CIRCUITS. PAINT CONDUIT TO MATCH WALL.
- 4 NEW RECEPTACLE FOR REFRIGERATOR POWER TO BE CONNECTED TO NEW DEDICATED CIRCUIT FROM EXISTING ABANDON CIRCUITS. INSTALL NEW 20A, 1-P BREAKER OR REUSE EXISTING BREAKER IF NECESSARY. CONTRACTOR VERIFY EQUIPMENT LOAD. CONDUIT TO SURFACE BOX INSTALLEDFROM EXISTING CIRCUITS. PAINT CONDUIT TO MATCH WALL.
- (7) DUPLEX RACK MOUNTED RECEPTACLES IN 2-CHANNEL RACEWAY TO BE CONNECTED TO FORMER RECEPTACLE CIRCUIT. REUSE EXISTING BREAKER, RACEWAYS AND CONDUCTORS WHERE POSSIBLE AND MODIFY AS REQUIRED TO SUIT NEW LAYOUT.
- 6 EXISTING RECEPTACLE LOCATION; INSTALL NEW DEVICE AND COVER PLATE.
- 7 NEW RECEPTACLE FOR DUCTLESS VENT HOOD POWER TO BE CONNECTED TO EXISTING CIRCUIT FROM EXISTING ABANDON CIRCUITS. INSTALL NEW 20A, 1-P BREAKER OR REUSE EXISTING BREAKER IF NECESSARY. CONDUIT TO SURFACE BOX INSTALLED FROM EXISTING CIRCUITS. PAINT CONDUIT TO MATCH WALL.
- 8 POWER NEW HVAC / VRF UNIT WITH EXTENSION OF EXISTING CIRCUITS, CONNECTED TO DEDICATED CIRCUIT FROM ABANDON CIRCUITS.
- 9 PROVIDE (3) EMPTY 4" SQUARE SQUARE BOX IN WALL WITH PLASTER RING AT 16" A.F.F. FOR FUTURE DATA CABLES, PROVIDE 1" EMPTY CONDUIT EXTENDED FROM EACH BOXUP TO ABOVE ACCESSIBLE CEILING FACE PLATE, JACK MODULES, AND CABLING BY OWNER.



UNITED HOSPITAL SUPPLY CORP. LAB DESIGN * FENCO

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CURRENT DATE: 1/31/2020



ICENSE EXPIRES: 11/30/2020 CURRENT DATE: 1/31/2020



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CONSTRUCTION

DOCUMENT PHASE **ISSUED FOR** BIDDING 3/31/2020

SSUE DATE: 1/31/2020 REVISIONS

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ELECTRICAL POWER PLAN

DWG NO

E2