
HEALTH LIFE SAFETY WORK:

ROOF REPLACEMENT AT: BALDWIN ELEMENTARY SCHOOL

QUINCY PUBLIC SCHOOL DISTRICT #172

3000 MAINE STREET, QUINCY, ILLINOIS

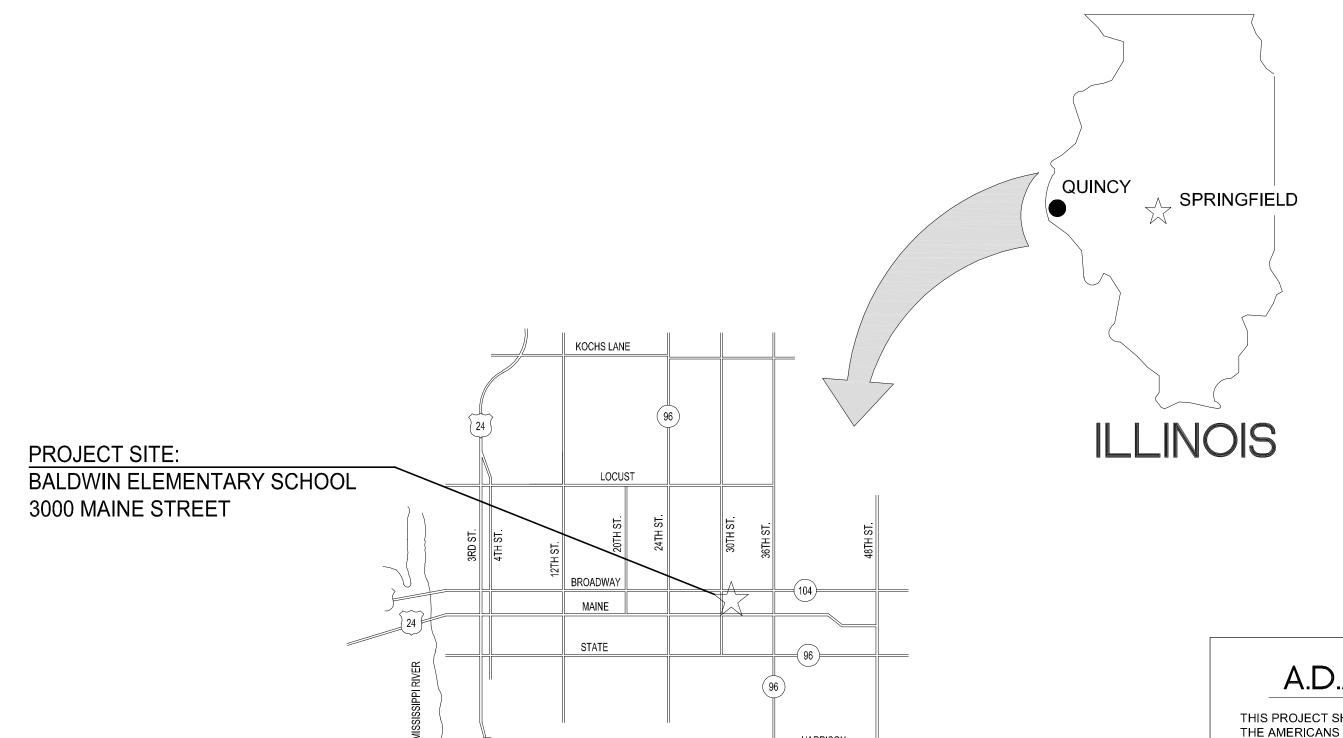

AREA LOCATION - MAP

CITY OF QUINCY



A.D.A. COMPLIANCE

AMERICANS WITH DISABILITIES ACT (A.D.A.)

ARCHITECHNICS, TO THE BEST OF ITS ABILITY, HAS EXERCISED PROFESSIONAL EFFORTS TO INTERPRET THE INTENT OF THE "AMERICANS WITH DISABILITIES ACT", AND OTHER APPLICABLE FEDERAL, STATE AND LOCAL CODES AND REQUIREMENTS. ARCHITECHNICS CANNOT GUARANTEE TOTAL COMPLIANCE WITH ANY WORK DIRECTLY RELATED TO THE A.D.A., WHEN THE OWNER PERFORMS AND/OR AUTHORIZES WORK USING THESE DOCUMENTS AND/OR DRAWINGS.

GENERAL NOTES

- 1. CONTRACTOR TO VERIFY ALL DIMENSIONS.
- 2. ANY DISCREPANCIES BETWEEN STATED AND EXISTING CONDITIONS SHALL BE REPORTED IMMEDIATELY TO THE ARCHITECT.
- 3. DISCREPANCIES OR CONFLICTS BETWEEN SPECIFICATIONS AND DRAWINGS SHALL BE MADE KNOWN TO THE ARCHITECT FOR CLARIFICATION.
- 4. THE CONTRACTOR SHALL BE RESPONSIBLE FOR PROTECTING THOSE AREAS TO REMAIN UNDISTURBED DURING CONSTRUCTION.
- 5. THE CONTRACTOR SHALL TAKE NECESSARY PRECAUTIONS, TO MAINTAIN SAFETY AT THE CONSTRUCTION SITE, AND HE IS SOLELY RESPONSIBLE FOR SAFETY MEASURES. THE CONTRACTOR IS ALSO SOLELY RESPONSIBLE FOR CONSTRUCTION MEANS, METHODS, AND TECHNIQUES REGARDING EXECUTION OF THE WORK.
- 6. THE CONTRACTOR SHALL CONFORM TO ALL LOCAL AND STATE CODES AND RECEIVE LOCAL AND STATE APPROVAL WHERE NECESSARY PRIOR TO CONSTRUCTION.
- 7. THE CONTRACTOR SHALL GIVE ALL NECESSARY NOTICES AND OBTAIN ALL PERMITS AND PAY ALL LEGAL FEES. HE SHALL ALSO COMPLY WITH ALL CITY, COUNTY, AND STATE BUILDING LAWS, ORDINANCES, OR REGULATIONS.
- 8. THE CONTRACTOR SHALL BE RESPONSIBLE FOR ANY DAMAGE DONE TO THE PREMISES OR ADJACENT PREMISES, OR INJURIES TO THE PUBLIC DURING THE CONSTRUCTION OF THE WORK, CAUSED BY HIMSELF, HIS SUBCONTRACTOR, OR THE CARELESSNESS OF ANY OF HIS EMPLOYEES.
- 9. THE CONTRACTOR MUST UNDERSTAND THAT THE WORK IS ENTIRELY AT HIS RISK UNTIL SAME IS ACCEPTED, AND HE WILL BE HELD RESPONSIBLE FOR
- 10. THE CONTRACTOR SHALL FURNISH AND INSTALL ALL NECESSARY TEMPORARY WORKS FOR THE PROTECTION OF THE WORK, INCLUDING BARRICADES, WARNING SIGNS, LIGHTS, ETC.
- 11. THE CONTRACTOR SHALL PROVIDE THE ARCHITECT WITH ONE SET OF PRINTS MARKED WITH ANY CHANGES FROM ORIGINAL CONTRACT DOCUMENTS.

INDEX OF DRAWINGS

G1.0 **COVER SHEET**

ROOF PLAN

ENLARGED ROOF PLAN

ENLARGED ROOF PLAN

ROOF DETAILS

ROOF DETAILS

ROOF DETAILS A6.0

NOTE:
G.C. SHALL COORDINATE WITH MAAS CONSTRUCTION FOR ON-GOING PROJECT AT THE

ADD'N.

A.H.U.

ALUM

A.D.A.

ANCS. AUTO.

BR'G.

BITUM. BLK'G.

BLDG

BTM.

BÛR

CAT

C.T.

CLG.

C.W.B.

C.B. CLOS. C.O.

COMP.

CONC C.M.U.

CONN.

C.J.

CONST.

CONT CONTR.

COR'D

CORR. CNTR C.R.

C.F.M.

DEMO

DETAIL

DIAMETER

DIMENSION

DISPENSER

DOWNSPOUT

DIVISION

DOOR

DOUBLE

DET

DIA

DIV.

DR.

DBL.

D.S.

B.P.

	MATERIALS
•	PROPERTY CORNER
714_	EXISTING CONTOUR
714_	NEW CONTOUR
	EARTH
	CRUSHED ROCK
	CONCRETE
	FACE BRICK
	CONCRETE BLOCK
	PARTITION, SEE CODE
2 4	DIMENSION LUMBER
	FINISH LUMBER
	GYPSUM WALLBOARD
	PLYWOOD
	BATT INSULATION
	METALS

SHEET SIMILAR

SPECIFICATION

STAIN AND VARNISH

ABBREVIATIONS

		ABBREVIAII			O N 2	
	A DOVE	DWG	DDAMING	M.A.U.	MAKEUP AIR UNIT	
	ABOVE ABOVE FINISHED FLOOR	D.F.	DRAWING DRINKING FOUNTAIN	M.H.	MANHOLE	
	ADDITION	EA.	EACH	MFGR.	MANUFACTURER	
		E.W.	EACH WAY	M.T.	MARBLE TILE	
	AIR CONDITIONING	E.M.R.	ELASTOMERIC MEMBRANE	MK	MARK	
	AIR HANDLING UNIT	E.IVI.N.	ROOFING	M.O.	MASONRY OPENING	
	ALTERNATE	ELEC.	ELECTRIC	MATL.	MATERIAL	
	ALUMINUM	E.P.	ELECTRIC PANELBOARD	MECH.	MECHANICAL	
	AMERICANS WITH DISABILITIES ACT	E.F.	ELECTRIC PANELBOARD ELEVATION	MET.	METAL	
		ELEV.	ELEVATOR	MIN.	MINIMUM	
	ANCHORS	EXH.	EXHAUST	MISC.	MISCELLANEOUS	
	AUTOMATIC	E.F.	EXHAUST FAN	M.R.	MOISTURE RESISTA	
	BEAM	EXIST	EXISTING	MTD.	MOUNTED	
	BEARING	E. J.	EXPANSION JOINT	N.D.	NAPKIN DISPENSER	
	BITUMINOUS	E. J. EXT	EXTERIOR	N.I.C.	NOT IN CONTRACT	
	BLOCKING	E.I.F.S.	EXTERIOR INSULATION	NOM.	NOMINAL	
	BUILDING	E.I.F.S.	FINISH SYSTEM	NO.	NUMBER	
	BOARD	F.W.C.	FABRIC WALL COVERING	OFC.	OFFICE	
	BOTTOM	F.V.	FIELD VERIFY	0.C.	ON CENTER	
	BRICK PAVERS	FIN.	FINISH	O.C. OPG.	OPENING	
	BUILDING	F.E.C.	FIRE EXTINGUISHER	OPP. HND.	OPPOSITE HAND	
	BUILT-UP ROOF	F.E.G.	CABINET	OH.	OVERHEAD	
	CARPET	FIX.	FIXTURE	PT.	PAINT	
	CAST IRON	FL.	FLOOR			
	CATALOG	F.D.	FLOOR FLOOR DRAIN	PR.	PAIR	
	CEILING	FLOUR	FLOURESCENT	PARTN. PERF	PARTITION	
	CERAMIC TILE	FTG	FOOTING		PERFORATED	
	CERAMIC WALL BASE	FND.	FOUNDATION	P.D. PLAS	PRESSURE DROP PLASTIC	
	CHALK BOARD	G.P.M.	GALLONS PER MINUTE	PLAS.		
	CLOSET	GALV	GALVANIZED		PLUMBING STACK	
	CLEAN OUT	GALV	GAUGE	P.V.	PLUMBING VENT	
	COMPANY	G.W.T.	GLAZED WALL TILE	PLYWD.	PLYWOOD	
	COMPOSITION	G.B.	GRAB BAR	P.V.C.	POLYVINYL CHLORI	
	CONCRETE	G.F.B.	GROUND FACE BRICK	P.S.F.	POUNDS PER SQUA FOOT	
	CONCRETE MASONRY	GYP. BD.	GYPSUM WALLBOARD	DDEEN		
	UNIT	H.D.	HAIR/HAND DRYER	PREFIN.	PREFINISHED	
	CONDENSATION				PROJECT MANUAL	
	CONNECTION	HC	HANDICAPPED HANDRAIL	QTY.	QUANTITY	
-	CONSTRUCTION	HR. HDWE.	HARDWARE	Q.T.	QUARRY TILE	
	CONSTRUCTION JOINT	H.V.A.C.		RAD.	RADIUS	
	CONTINUOUS	П.V.А.С.	HEATING, VENTILATING, & AIR CONDITIONING	RECEP.	RECEPTACLE	
	CONTRACTOR	UT		REF.	REFERENCE	
	CORRUGATED	HT. H.C.	HEIGHT	R.A.	RETURN AIR	
	CORRIDOR		HOLLOW METAL	R.H.	RIGHT HAND	
	COUNTER	H.M. HOR I Z.	HOLLOW METAL	R.	RISERS	
	CRUSHED ROCK	INC.	HORIZONTAL INCORPORATED	R.D.	ROOF DRAIN	
	CUBIC FEET PER	INC. INSUL.	INSULATION	R.B.	RUBBER BASE	
	MINUTE	INSUL. INSUL.G.		R.C.B.	RUBBER COVE BAS	
	DEMOLITION	JAN	INSULATED GLASS JANTOR	REQD.	REQUIRED	
	DETAIL	I JANIN.	JANTUR	- D() (M	DIGHT OF WAY	

JAN.

JST.

J.B.

LAM.

LAV.

L.H.

LG.

JOINT

JOINT FILLER

JUNCTION BOX

LAMINATE

LAVATORY

LEFT HAND

LONG

M.A.U.	MAKEUP AIR UNIT	SECI.
M.H.	MANHOLE	SHT.
MFGR.	MANUFACTURER	SIM.
M.T.	MARBLE TILE	S.C.
MK.	MARK	SPEC.
м.о.	MASONRY OPENING	S.& V.
MATL.	MATERIAL	SS
MECH.	MECHANICAL	STD.
MET	METAL	STL.
MIN.	MINIMUM	STOR.
MISC	MISCELLANEOUS	ST. S.
M.R.	MOISTURE RESISTANT	S.G.T.
MTD	MOUNTED	
N.D.	NAPKIN DISPENSER	S.A.P.
N.I.C.	NOT IN CONTRACT	0.,
NOM.	NOMINAL	T.B.
NO.	NUMBER	T & S.
OFC.	OFFICE	TDD
	ON CENTER	1.0.0.
0.C.		T.G.
OPG.	OPENING	T.R.G.
	OPPOSITE HAND	1.K.G.
OH.	OVERHEAD	T-7
PT.	PAINT	TZ.
PR.	PAIR	T.T.
PARTN.	PARTITION	THK.
PERF.	PERFORATED	T'HOLI
P.D.	PRESSURE DROP	T.P.
PLAS.	PLASTIC	T. & G.
P.S.	PLUMBING STACK	T. & B.
P.V.	PLUMBING VENT	TRANS
PLYWD.	PLYWOOD	T.
P.V.C.	POLYVINYL CHLORIDE	TYP.
P.S.F.	POUNDS PER SQUARE	U.L.
	FOOT	
PREFIN.	PREFINISHED	U.N.O.
PROJ. MAN.	PROJECT MANUAL	
QTY.	QUANTITY	U.P.
Q.T.	QUARRY TILE	V.P.
RAD.	RADIUS	VERT.
RECEP.	RECEPTACLE	VEST.
REF.	REFERENCE	V.C.T.
R.A.	RETURN AIR	
R.H.	RIGHT HAND	V.W.C.
R.	RISERS	
R.D.	ROOF DRAIN	V.C.P.
R.B.	RUBBER BASE	W.C.
R.C.B.	RUBBER COVE BASE	W.W.F
REQD.	REQUIRED	W.
R.O.W.	RIGHT OF WAY	WDW
RM.	ROOM	W.G
R.I.	ROUGH IN	W/
R.O.	ROUGH OPENING	W/O
R.S.T.	RUBBER STAIR TREAD	WD.
R.T.	RUBBER TILE	T
Γ.Ι.	NUBBER TILE	T.(D

SANITARY (SEWER)

SCHED. SCHEDULE

S.S.	STAINLESS STEEL
STD.	STANDARD
STL.	STEEL
STOR.	STORAGE
ST.S.	STORM SEWER
S.G.T.	STRUCTURAL GLAZED
	TILE
S.A.P.	SUSPENDED ACCOUSTICAL
0.7 (PANELS
T.B.	TACK BOARD
T & S	TAPE AND SAND
T.D.D.	TELECOMMUNICATIONS
1.0.0.	DEVICE FOR DEAF
T.G.	TEMPERED GLASS
T.R.G.	TEMPERED REFLECTIVE
I.R.G.	GLASS
T-7	TERRAZZO
TZ. T.T.	
	TERRAZZO TILE
THK.	THICK/THICKNESS
T'HOLD	THRESHOLD
T.P.	TOILET PAPPER
T. & G.	TONGUE AND GROOVE
T. & B.	TOP AND BOTTOM
TRANS.	TRANSITION
T.	TREADS
TYP.	TYPICAL
U.L.	UNDERWRITERS
	LABORATORIES
U.N.O.	UNLESS NOTED
	OTHERWISE
U.P.	UTILITY POLE
V.P.	VAPOR BARRIER
VERT.	VERTICAL
VEST.	VESTIBULE
V.C.T.	VINYL COMPOSITION
	TILE
V.W.C.	VINYL WALL
	COVERING
V.C.P.	VITRIFIED CLAY PIPE
W.C.	WATER CLOSET
W.W.F	WELDED WIRE FABRIC
W	WIDTH
WDW	WINDOW
W.G.	WIRE GLASS
vv.G.	WINE GLASS

TYP.

U.L.

WITH OUT

TREADS

UNDERWRITERS

TYPICAL

WOOD

LICENSE EXPIRES: 11/30/19

CONSTRUCTION DOCUMENT

PHASE **ISSUED FOR** CONSTRUCTION SSUE DATE: 1/17/2019 REVISIONS

PROJECT NUMBER: 5774


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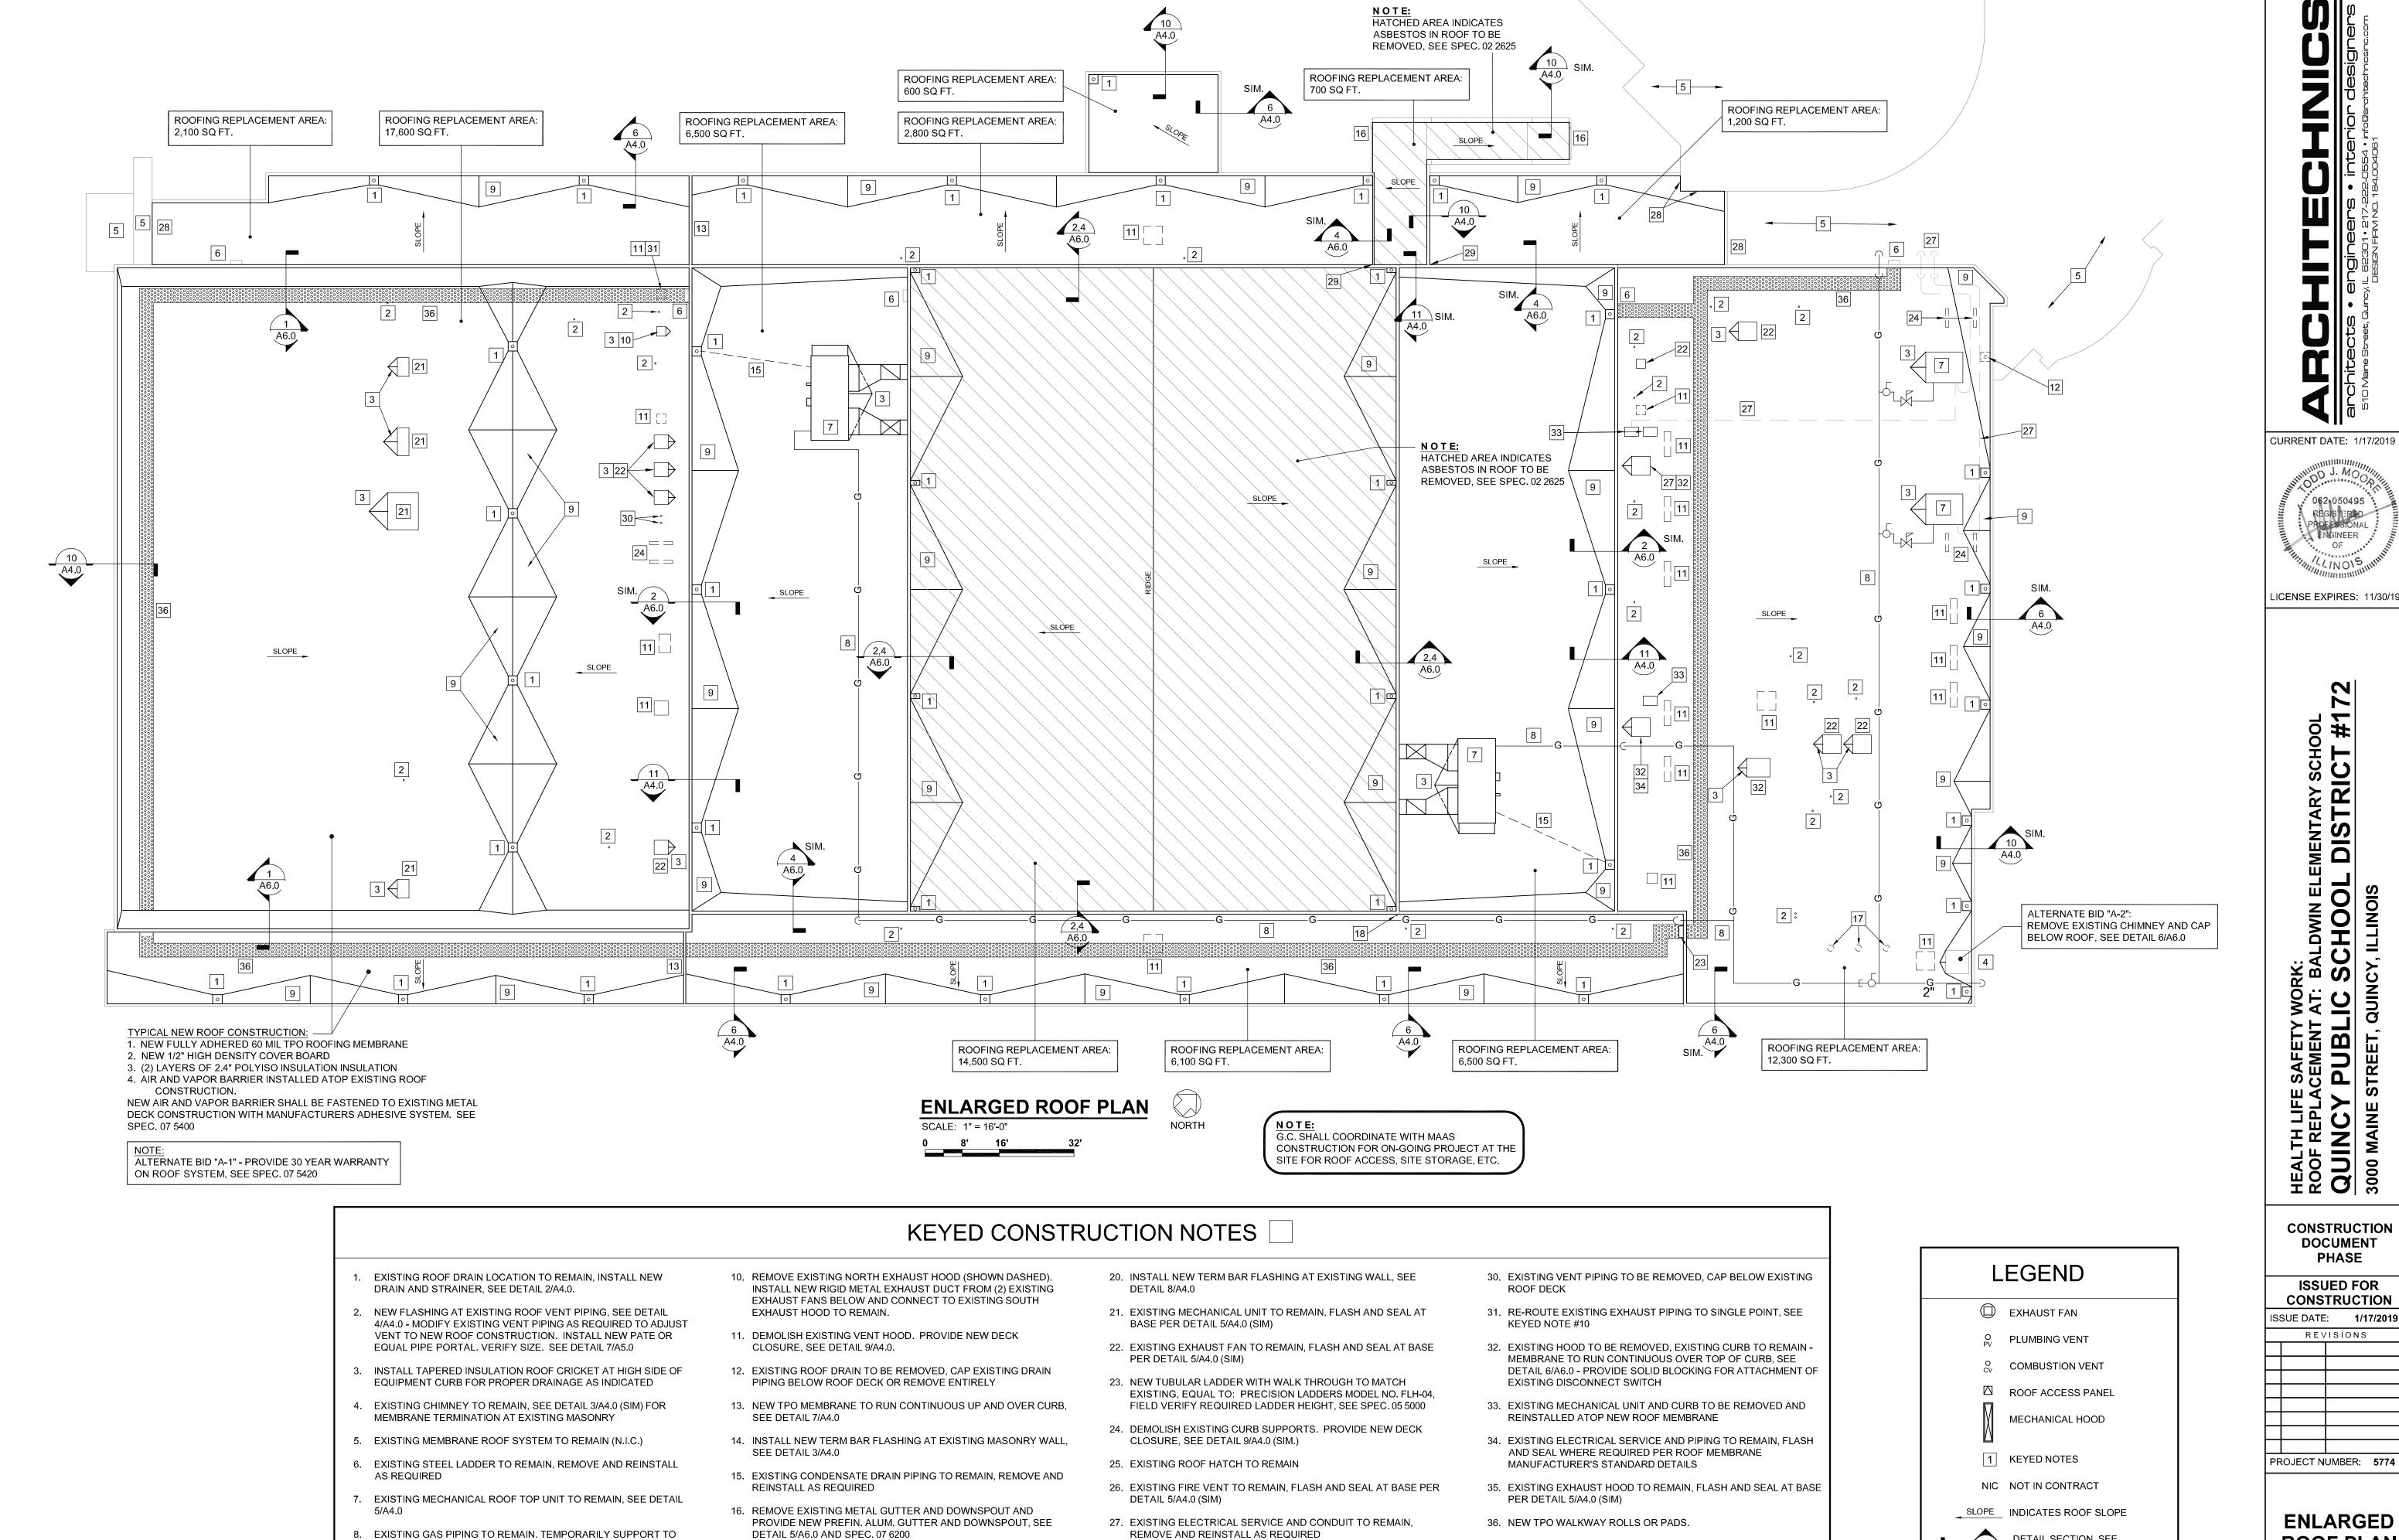
ISSUED FOR CONSTRUCTION
ISSUE DATE: 1/17/2019
REVISIONS

PROJECT NUMBER: 5774

OVERALL ROOF PLAN

DWG. NO. **A1.0**



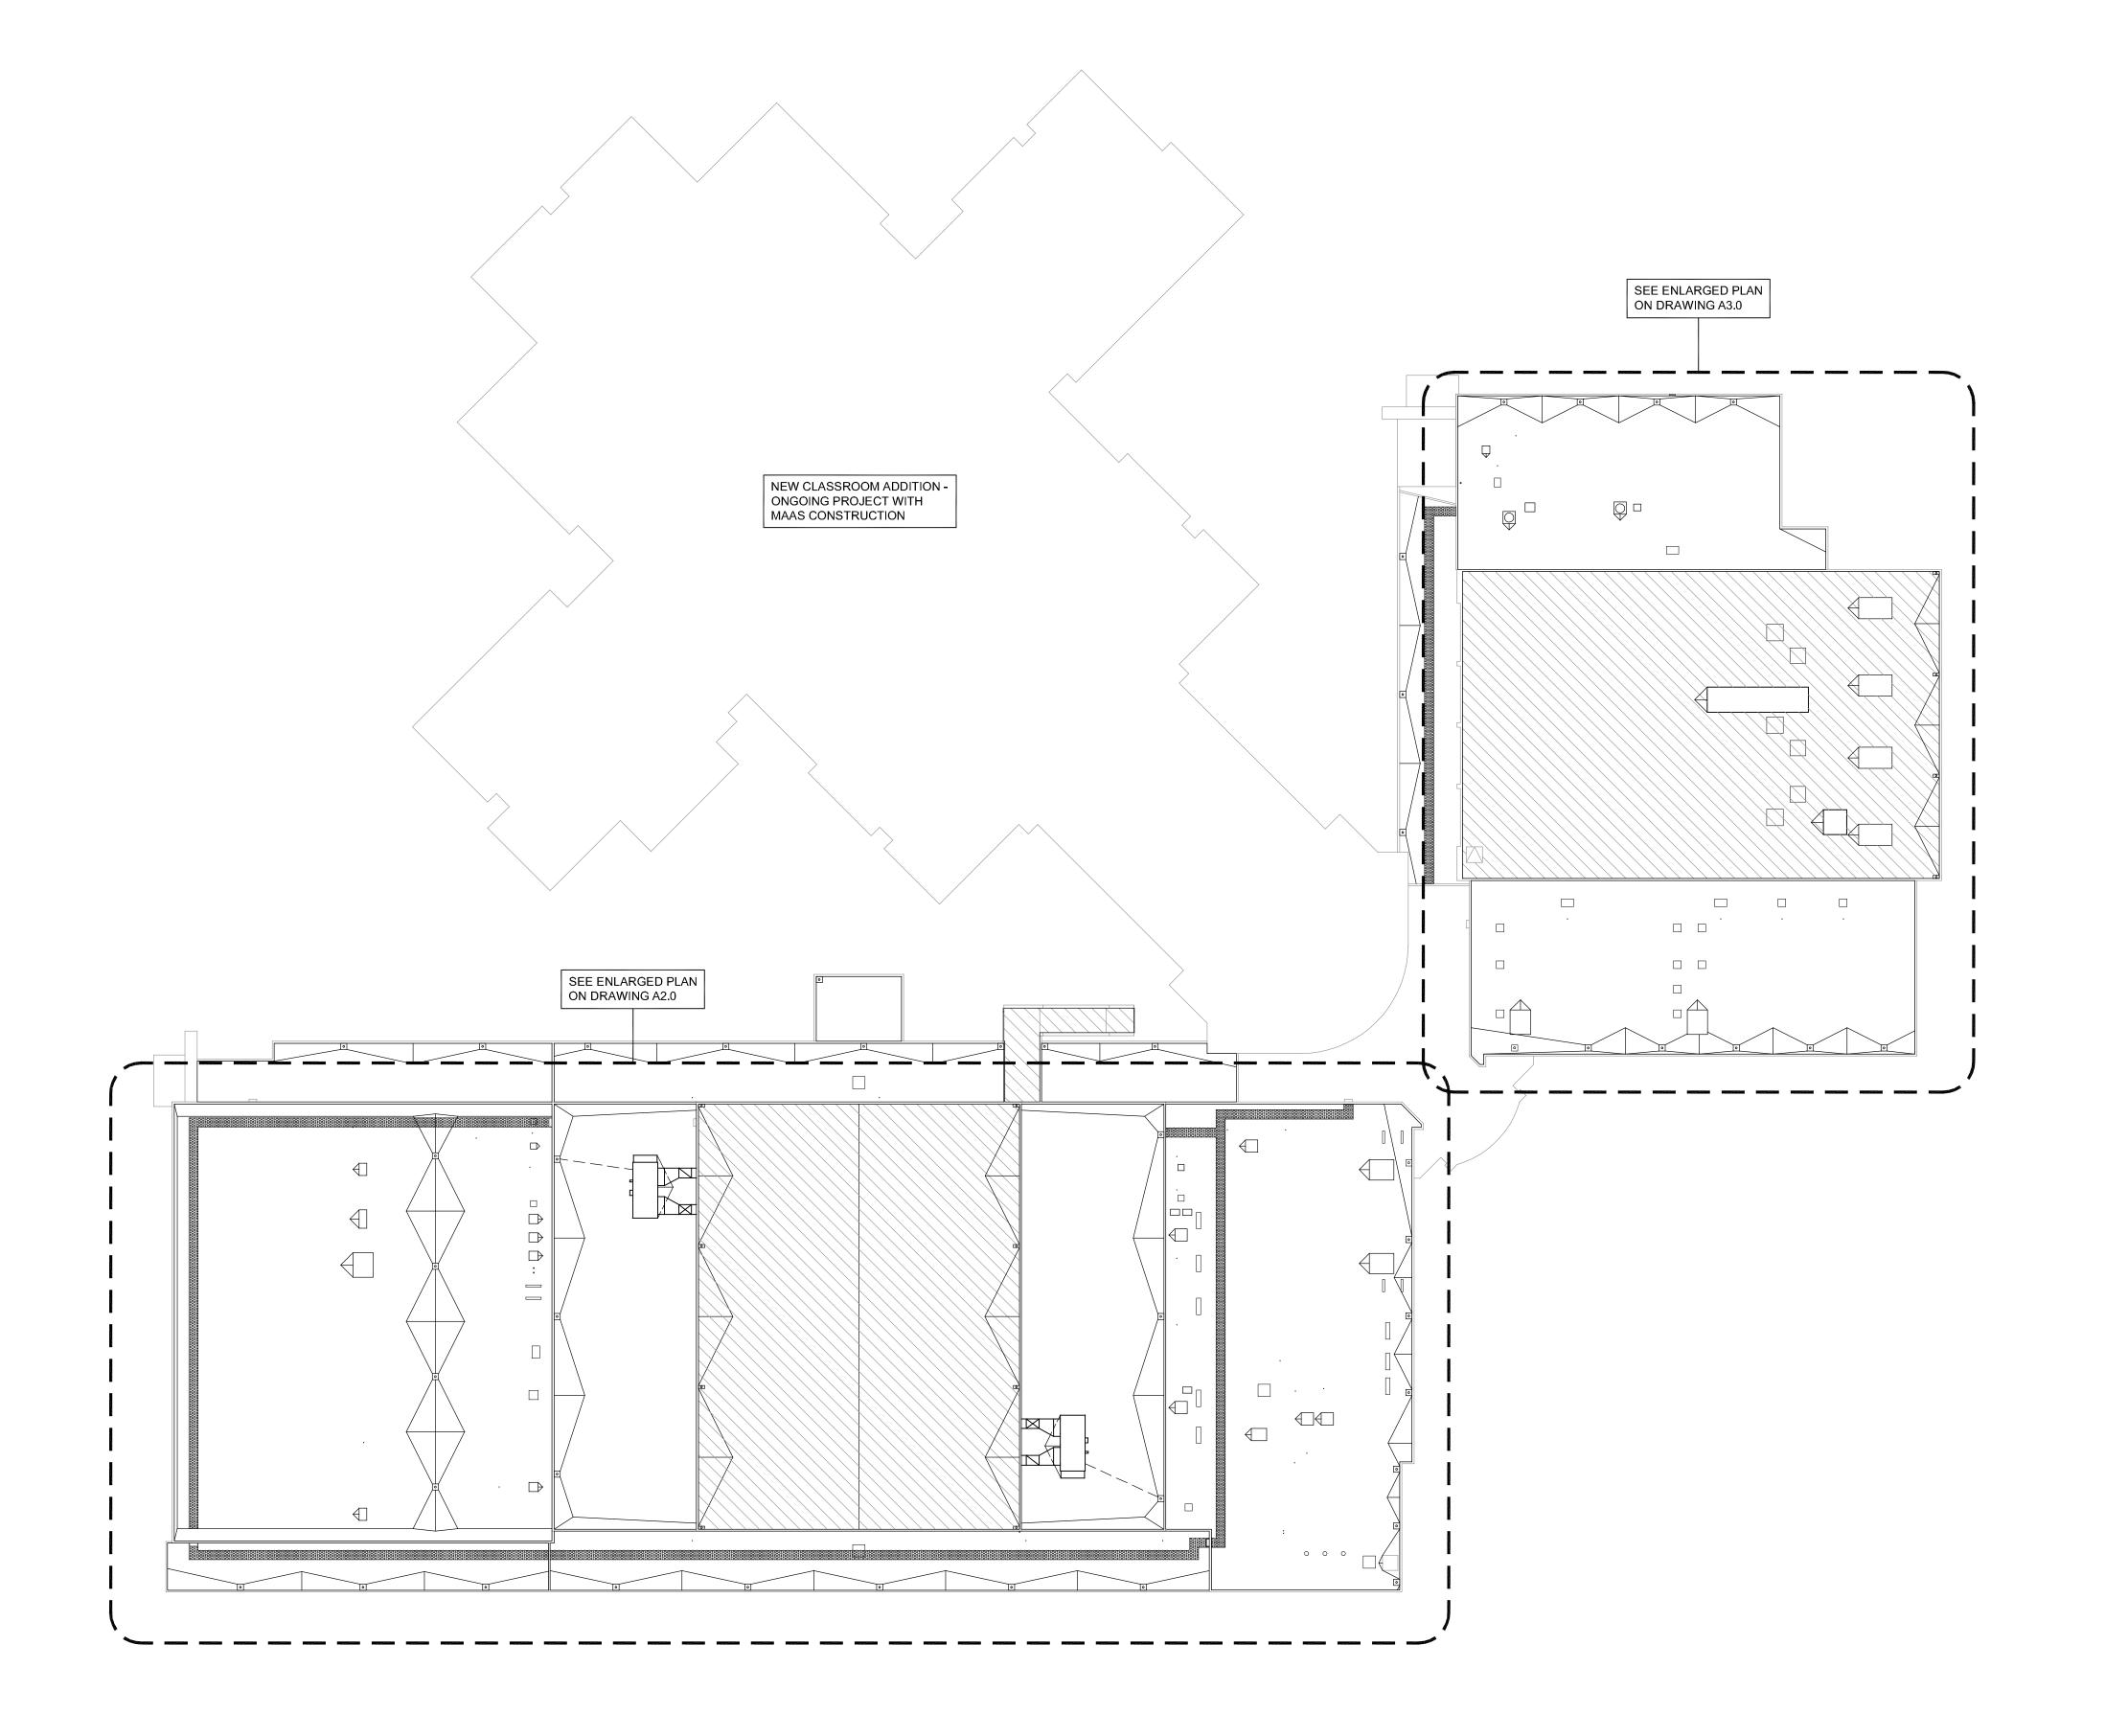

28. SPLICE NEW MEMBRANE TO EXISTING, SEE DETAIL 5/A5.0

"EXPAND-O-FLASH"

29. EXISTING EXPANSION JOINT TO BE REMOVED, PROVIDE NEW

JOINT FILLER AND COVER EQUAL TO: JOHNS MANSVILLE

ALLOW FOR NEW ROOF INSTALLATION. REINSTALL PIPE STANDS AFTER NEW ROOF IS INSTALLED. PROVIDE NEW PIPE STANDS AS

9. ROOF INSULATION CRICKET, PROVIDE ADDITIONAL INSULATION

AS REQUIRED AND SLOPE PER ROOF MEMBRANE

MANUFACTURER'S TYPICAL DETAILS.

17. EXISTING EXHAUST PIPING TO BE REMOVED

18. EXISTING ANTENNA AND ASSOCIATED WIRING TO BE REMOVED

19. REMOVE EXISTING WEATHER VANE AND WOOD SUPPORT

CURRENT DATE: 1/17/2019



LICENSE EXPIRES: 11/30/19

TRICT # HOOL ILLINOIS


> CONSTRUCTION DOCUMENT

ISSUED FOR CONSTRUCTION SSUE DATE: 1/17/2019 REVISIONS

ENLARGED ROOF PLAN

DETAIL SECTION, SEE
DETAILS SHEETS A4.0-A6.0

DWG. NO.

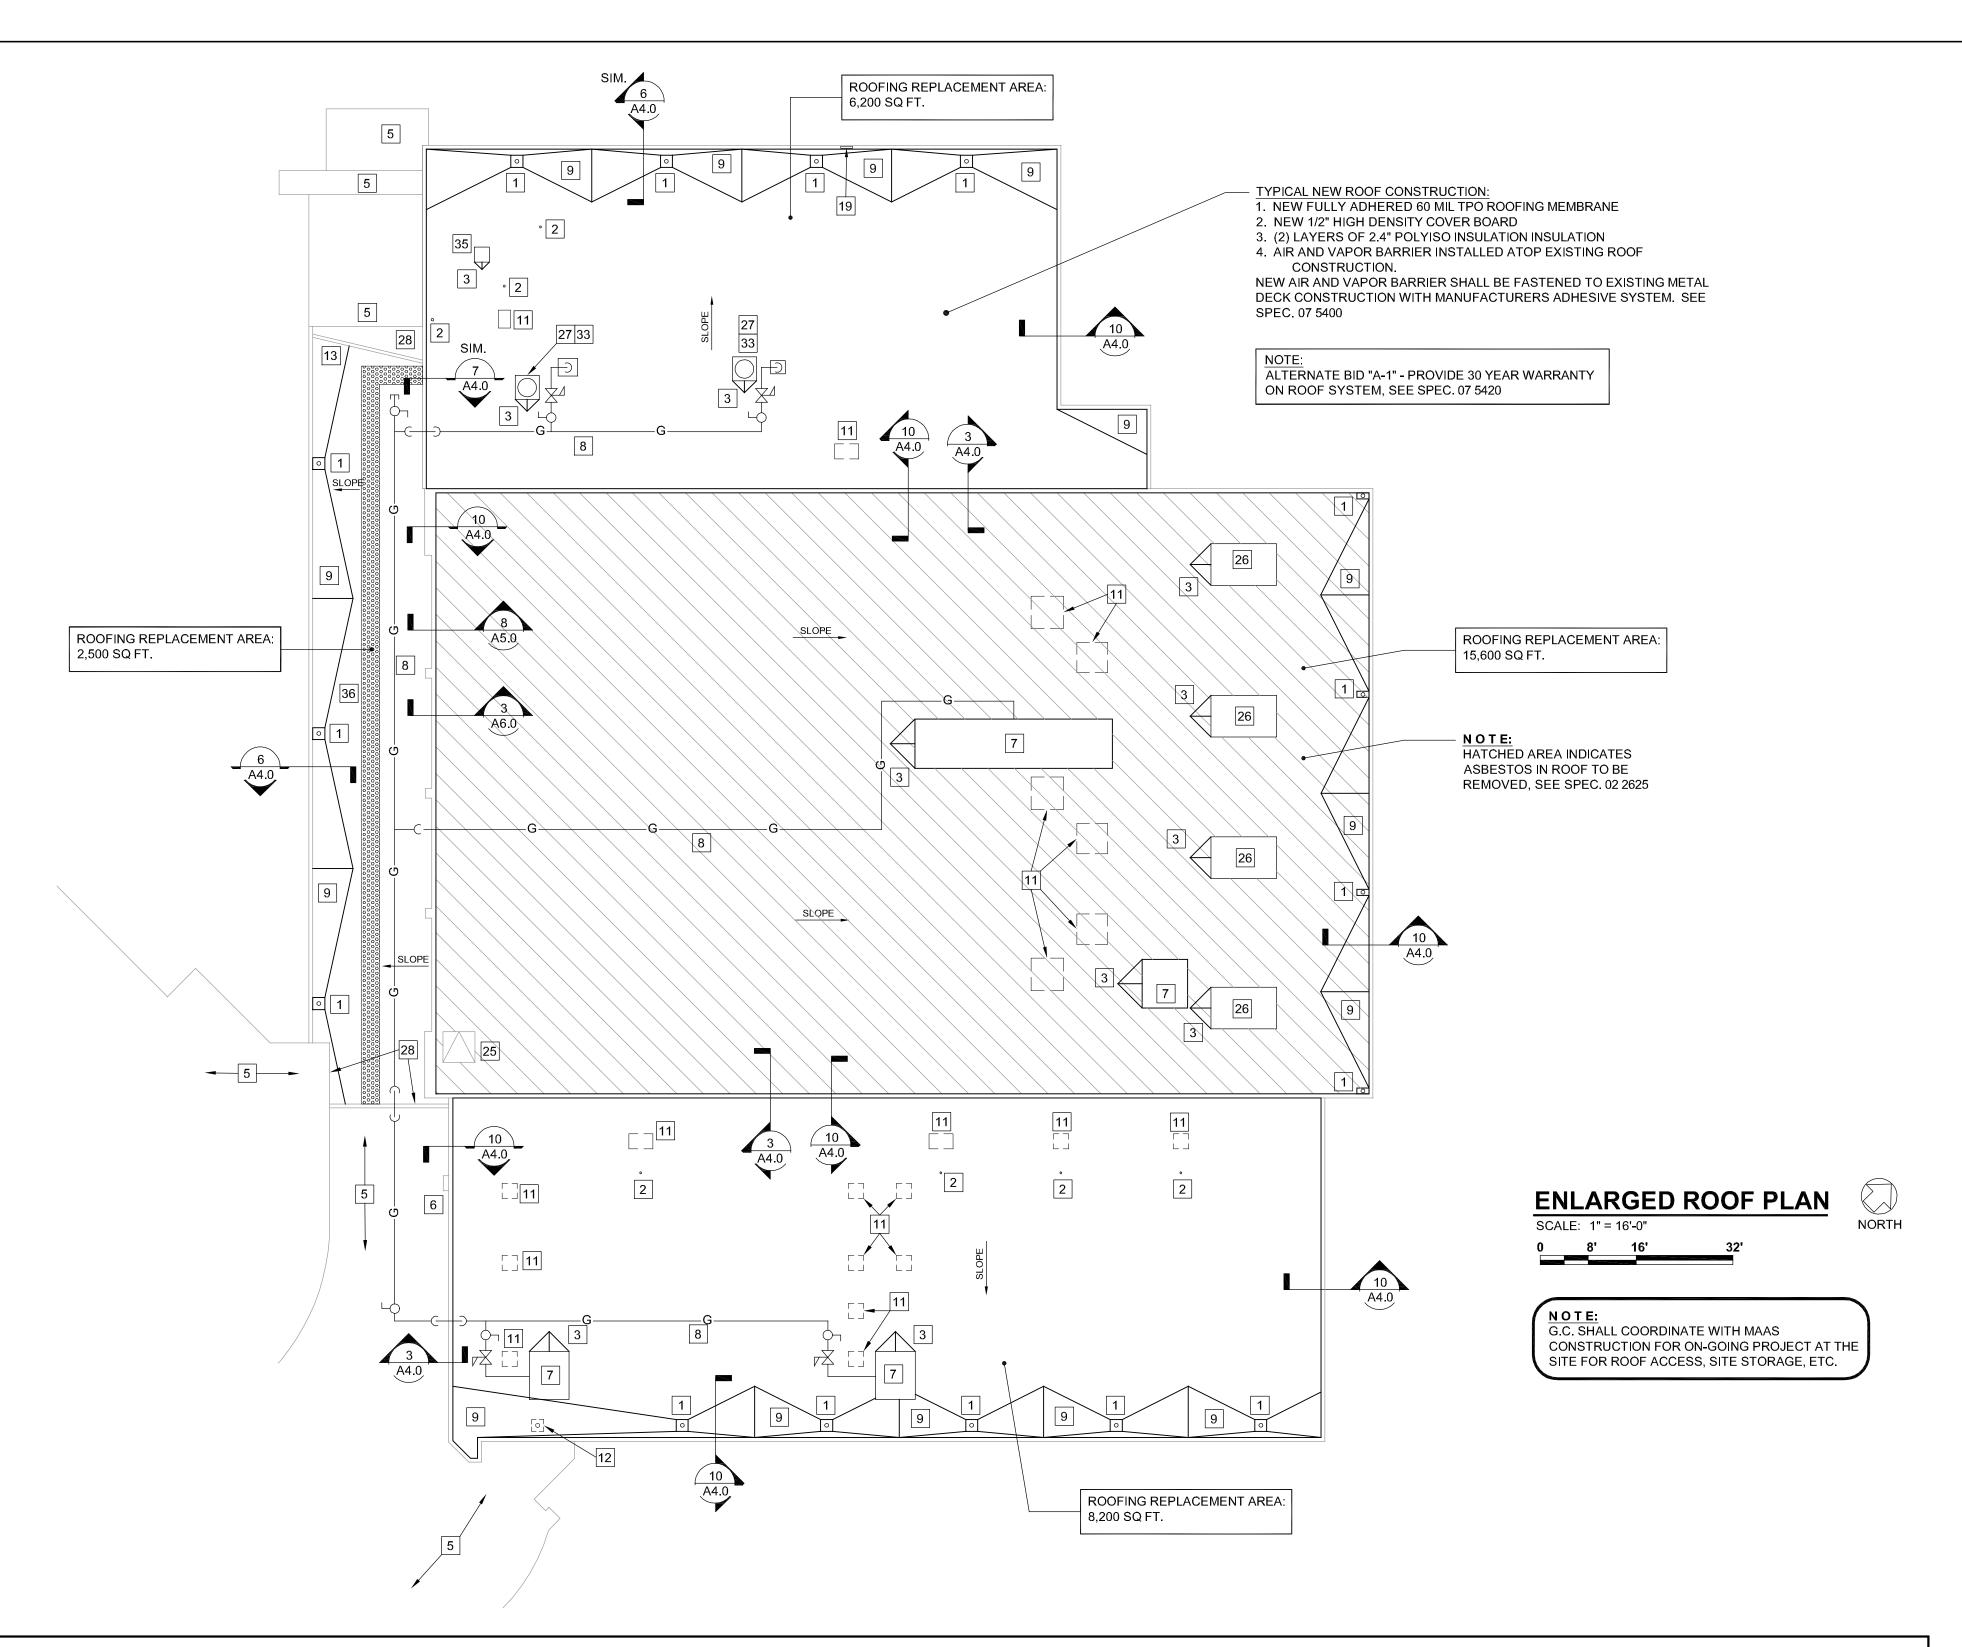

KEYED CONSTRUCTION NOTES

- 1. EXISTING ROOF DRAIN LOCATION TO REMAIN, INSTALL NEW DRAIN AND STRAINER, SEE DETAIL 2/A4.0.
- 2. NEW FLASHING AT EXISTING ROOF VENT PIPING, SEE DETAIL 4/A4.0 - MODIFY EXISTING VENT PIPING AS REQUIRED TO ADJUST VENT TO NEW ROOF CONSTRUCTION. INSTALL NEW PATE OR EQUAL PIPE PORTAL. VERIFY SIZE. SEE DETAIL 7/A5.0
- INSTALL TAPERED INSULATION ROOF CRICKET AT HIGH SIDE OF EQUIPMENT CURB FOR PROPER DRAINAGE AS INDICATED
- 4. EXISTING CHIMNEY TO REMAIN, SEE DETAIL 3/A4.0 (SIM) FOR
- MEMBRANE TERMINATION AT EXISTING MASONRY 5. EXISTING MEMBRANE ROOF SYSTEM TO REMAIN (N.I.C.)
- 6. EXISTING STEEL LADDER TO REMAIN, REMOVE AND REINSTALL
- AS REQUIRED
- 7. EXISTING MECHANICAL ROOF TOP UNIT TO REMAIN, SEE DETAIL
- 8. EXISTING GAS PIPING TO REMAIN. TEMPORARILY SUPPORT TO ALLOW FOR NEW ROOF INSTALLATION. REINSTALL PIPE STANDS AFTER NEW ROOF IS INSTALLED. PROVIDE NEW PIPE STANDS AS REQUIRED
- 9. ROOF INSULATION CRICKET, PROVIDE ADDITIONAL INSULATION AS REQUIRED AND SLOPE PER ROOF MEMBRANE MANUFACTURER'S TYPICAL DETAILS.

- 10. REMOVE EXISTING NORTH EXHAUST HOOD (SHOWN DASHED). INSTALL NEW RIGID METAL EXHAUST DUCT FROM (2) EXISTING EXHAUST FANS BELOW AND CONNECT TO EXISTING SOUTH EXHAUST HOOD TO REMAIN.
- 11. DEMOLISH EXISTING VENT HOOD. PROVIDE NEW DECK CLOSURE, SEE DETAIL 9/A4.0.
- 12. EXISTING ROOF DRAIN TO BE REMOVED, CAP EXISTING DRAIN PIPING BELOW ROOF DECK OR REMOVE ENTIRELY
- 13. NEW TPO MEMBRANE TO RUN CONTINUOUS UP AND OVER CURB, SEE DETAIL 7/A4.0
- 14. INSTALL NEW TERM BAR FLASHING AT EXISTING MASONRY WALL, SEE DETAIL 3/A4.0
- 15. EXISTING CONDENSATE DRAIN PIPING TO REMAIN, REMOVE AND
- 16. REMOVE EXISTING METAL GUTTER AND DOWNSPOUT AND PROVIDE NEW PREFIN. ALUM. GUTTER AND DOWNSPOUT, SEE DETAIL 5/A6.0 AND SPEC. 07 6200
- 17. EXISTING EXHAUST PIPING TO BE REMOVED

REINSTALL AS REQUIRED

- 18. EXISTING ANTENNA AND ASSOCIATED WIRING TO BE REMOVED
- 19. REMOVE EXISTING WEATHER VANE AND WOOD SUPPORT

- 20. INSTALL NEW TERM BAR FLASHING AT EXISTING WALL, SEE DETAIL 8/A4.0
- 21. EXISTING MECHANICAL UNIT TO REMAIN, FLASH AND SEAL AT BASE PER DETAIL 5/A4.0 (SIM)
- 22. EXISTING EXHAUST FAN TO REMAIN, FLASH AND SEAL AT BASE PER DETAIL 5/A4.0 (SIM)
- 23. NEW TUBULAR LADDER WITH WALK THROUGH TO MATCH EXISTING, EQUAL TO: PRECISION LADDERS MODEL NO. FLH-04, FIELD VERIFY REQUIRED LADDER HEIGHT, SEE SPEC. 05 5000
- 24. DEMOLISH EXISTING CURB SUPPORTS. PROVIDE NEW DECK CLOSURE, SEE DETAIL 9/A4.0 (SIM.)
- 25. EXISTING ROOF HATCH TO REMAIN
- 26. EXISTING FIRE VENT TO REMAIN, FLASH AND SEAL AT BASE PER DETAIL 5/A4.0 (SIM)
- 27. EXISTING ELECTRICAL SERVICE AND CONDUIT TO REMAIN, REMOVE AND REINSTALL AS REQUIRED
- 28. SPLICE NEW MEMBRANE TO EXISTING, SEE DETAIL 5/A5.0
- 29. EXISTING EXPANSION JOINT TO BE REMOVED, PROVIDE NEW JOINT FILLER AND COVER EQUAL TO: JOHNS MANSVILLE "EXPAND-O-FLASH"

- 30. EXISTING VENT PIPING TO BE REMOVED, CAP BELOW EXISTING ROOF DECK
- 31. RE-ROUTE EXISTING EXHAUST PIPING TO SINGLE POINT, SEE **KEYED NOTE #10**
- 32. EXISTING HOOD TO BE REMOVED, EXISTING CURB TO REMAIN -MEMBRANE TO RUN CONTINUOUS OVER TOP OF CURB, SEE DETAIL 6/A6.0 - PROVIDE SOLID BLOCKING FOR ATTACHMENT OF EXISTING DISCONNECT SWITCH
- 33. EXISTING MECHANICAL UNIT AND CURB TO BE REMOVED AND REINSTALLED ATOP NEW ROOF MEMBRANE
- 34. EXISTING ELECTRICAL SERVICE AND PIPING TO REMAIN, FLASH AND SEAL WHERE REQUIRED PER ROOF MEMBRANE MANUFACTURER'S STANDARD DETAILS
- 35. EXISTING EXHAUST HOOD TO REMAIN, FLASH AND SEAL AT BASE PER DETAIL 5/A4.0 (SIM)
- 36. NEW TPO WALKWAY ROLLS OR PADS.

LEGEND

EXHAUST FAN

PLUMBING VENT


O COMBUSTION VENT

☐ ROOF ACCESS PANEL MECHANICAL HOOD

1 KEYED NOTES

NIC NOT IN CONTRACT

SLOPE INDICATES ROOF SLOPE

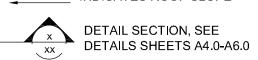

CURRENT DATE: 1/17/2019

LICENSE EXPIRES: 11/30/19

DWIN ELE


CONSTRUCTION DOCUMENT


PHASE **ISSUED FOR** CONSTRUCTION SSUE DATE: 1/17/2019 REVISIONS

PROJECT NUMBER: 5774

ENLARGED ROOF PLAN

DWG. NO.

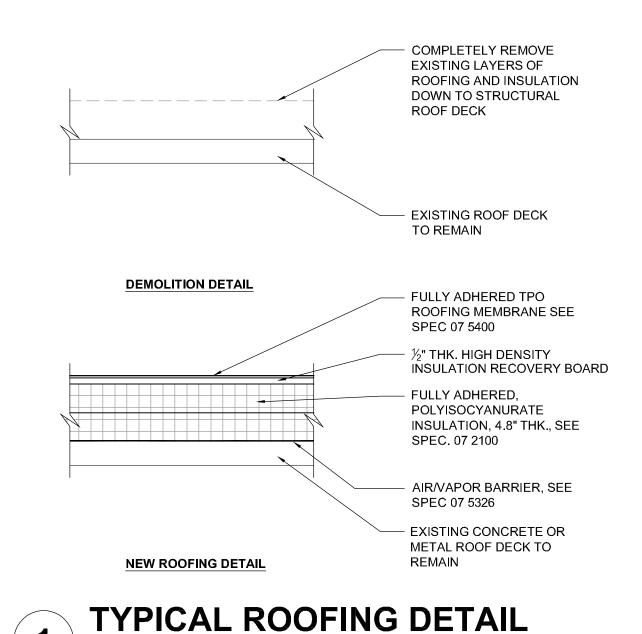

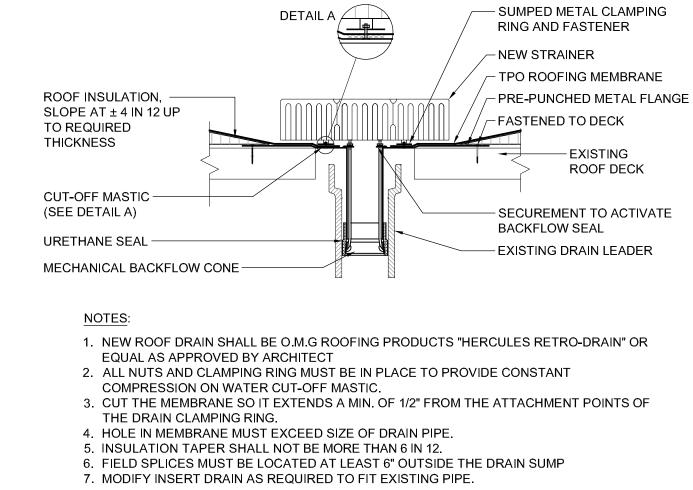

ROOF DRAIN DETAIL

2x TREATED NAILERS

- WATER CUT-OFF MASTIC

— FASTENERS @ 12"o.c.

AS REQUIRED

TPO MEMBRANE UP OVER


TOP AND DOWN 4" (MIN.)—

BOARD FOR MEMBRANE


SUPPORT AS REQUIRED

PROVIDE ADD'L. RECOVERY-

ON FACE

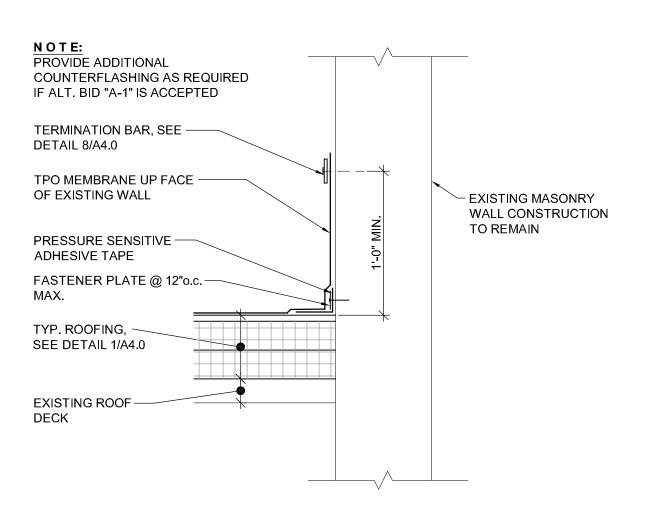

EDGE FLASHING DETAIL

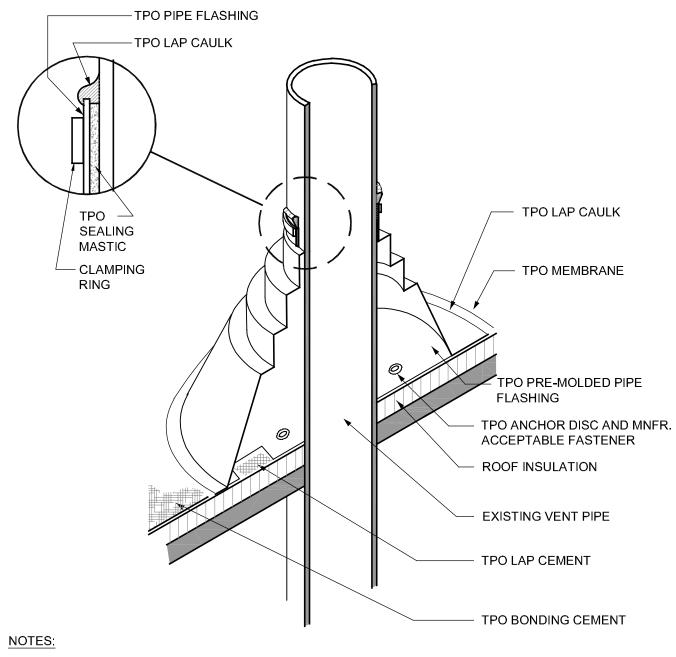


(1) DO NOT OVERLAP THE FLANGES FROM ADJACENT PIPE FLASHINGS. (2) ANY SEAM UNDER BOOT FLANGE TO BE TREATED AS T-JOINT.




GENERAL NOTES:

TOUCH-UP PAINT ON EXISTING SURFACES NEXT TO NEW WORK AS REQ'D.

DETAILS SHOWN ARE FOR CONTRACTORS INFORMATION AND TO COMMUNICATE DESIGN INTENT. DETAILS SHOWN ARE BASED UPON BEST INFORMATION AVAILABLE AT TIME, CONTRACTOR SHALL FIELD VERIFY ALL EXISTING CONDITIONS. IN ORDER TO ACHIEVE MANUFACTURER'S WARRANTY, DETAILS MAY ALSO VARY BASED UPON MANUFACTURER'S SYSTEM AND DESIGN RECOMMENDATIONS. SHOP DRAWING SUBMITTALS REQUIRED.

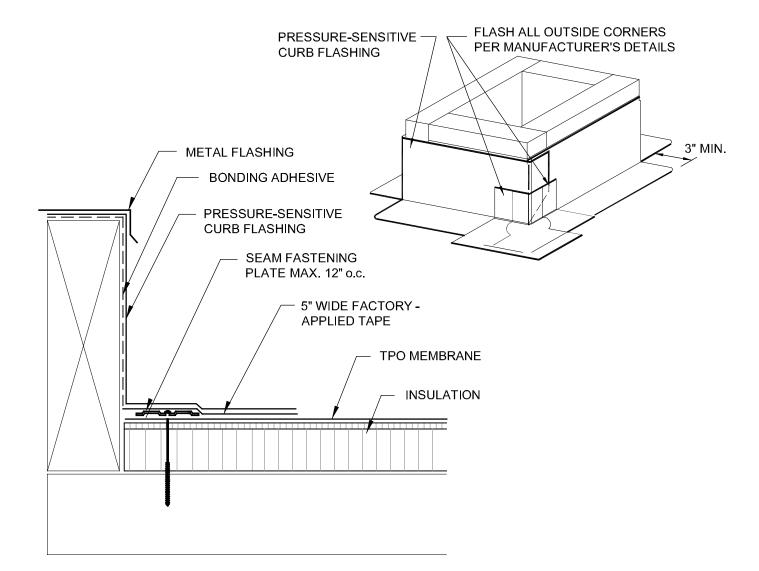

ROOF CURB DETAIL

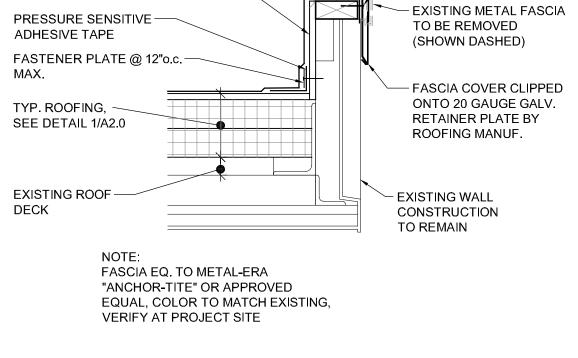

EDGE FLASHING DETAIL



DECK

TPO MEMBRANE, COVER

BOARD, AND INSULATION TO RUN CONTINUOUS UP

AND OVER TOP OF WALL

2x NAILER AS REQUIRED -

PRESSURE SENSITIVE -

ADHESIVE TAPE (TYP)


MAX. (TYP)


TYP. ROOFING,

EXISTING ROOF


SEE DETAIL 1/A4.0


FASTENER PLATE @ 12"o.c.

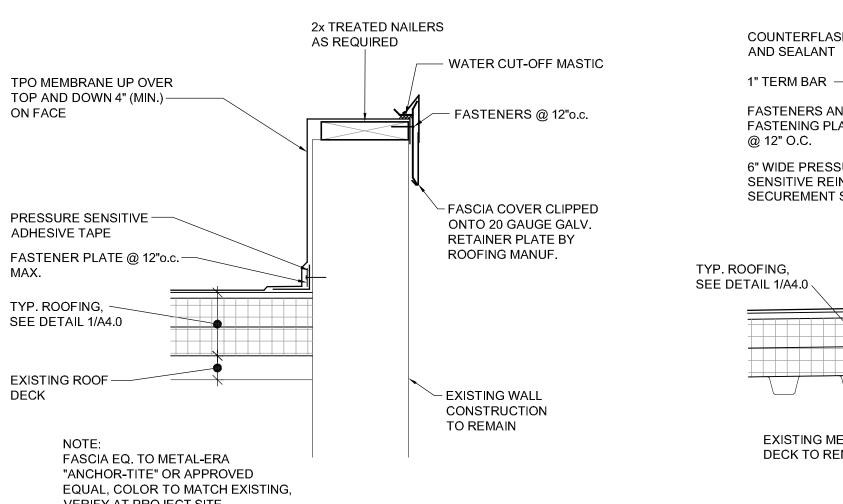

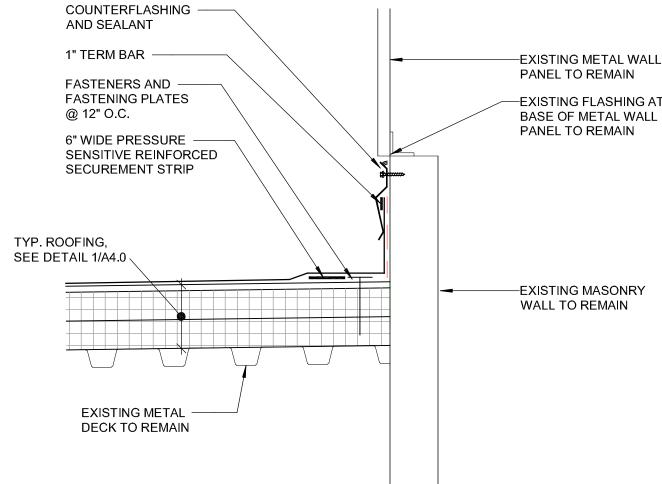



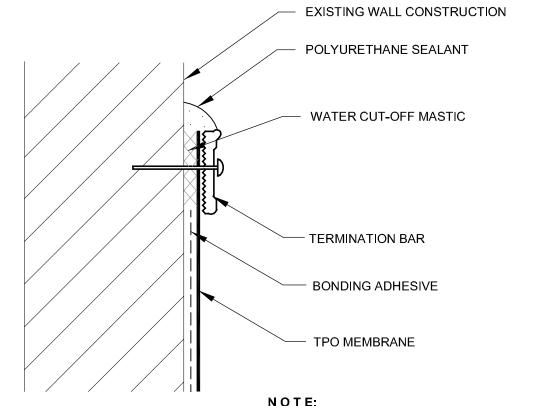


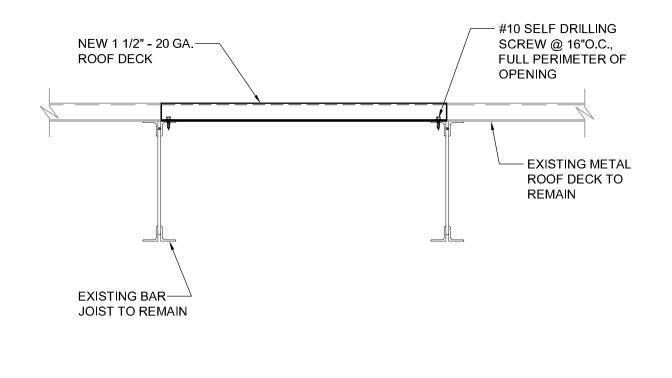

EXISTING ROOF PENETRATION INFILL DETAIL

TERMINATION BAR DETAIL



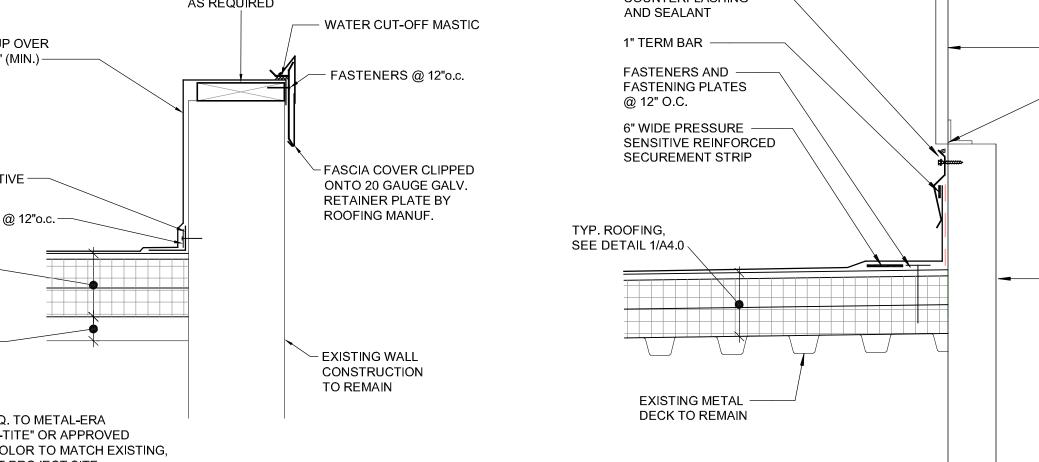

- EXISTING CURB

TO REMAIN

CONSTRUCTION

EDGE FLASHING DETAIL

DWG. NO. **A4.0**

CURRENT DATE: 1/17/2019

LICENSE EXPIRES: 11/30/19

Y WORK:
T AT: BALDWIN ELE

LIC SCHOOL

QUINCY, ILLINOIS

HEALTH LIFE SAFETY W ROOF REPLACEMENT A QUINCY PUBLI

CONSTRUCTION

DOCUMENT

PHASE

ISSUED FOR

CONSTRUCTION


SSUE DATE: 1/17/2019

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ROOF


DETAILS





NOTE:
PROVIDE ADDITIONAL
COUNTERFLASHING AS REQUIRED IF ALT. BID "A-1" IS ACCEPTED

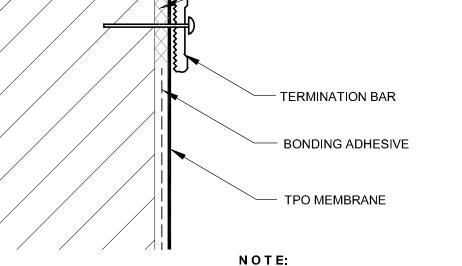TPO MEMBRANE UP OVER TOP AND DOWN 4" (MIN.) ON FACE PRESSURE SENSITIVE — ADHESIVE TAPE FASTENER PLATE @ 12"o.c. TYP. ROOFING, SEE DETAIL 1/A4.0


VERIFY AT PROJECT SITE

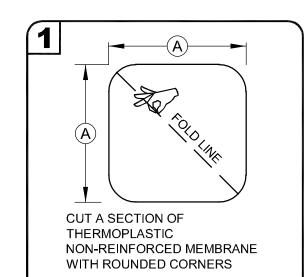


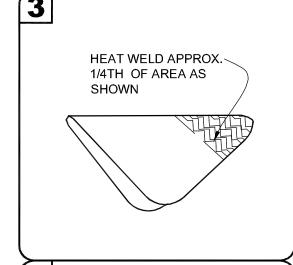


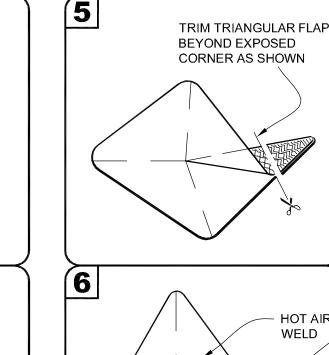

DIMENS	SIONS	·mm				1
A 6'	•	152	APPROX.			
B 6'	'-9"	152-229		J		
						FLAS HE
		REINFOF	RCED MEMBRA	ANE		
		REINFOR	RCED MEMBRA	ANE)	(A)
/	/	REINFOF		ANE)	
		REINFOF	RCED MEMBRA	ANE)	

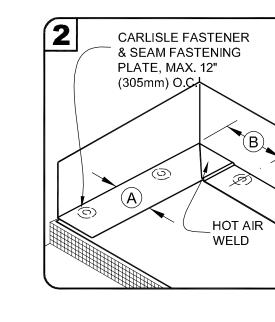

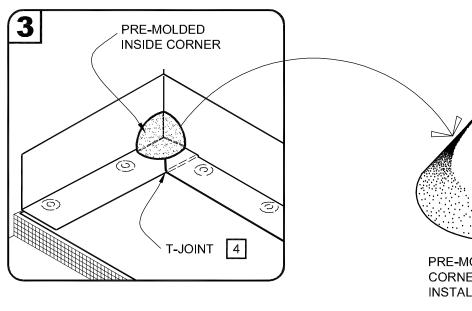


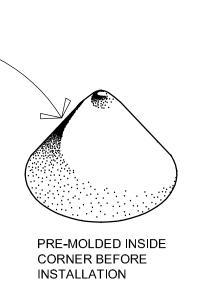


-MEMBRANE UNDERSIDE

MEMBRANE TOP

SURFACE

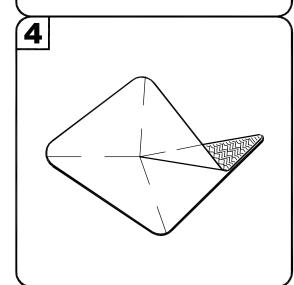

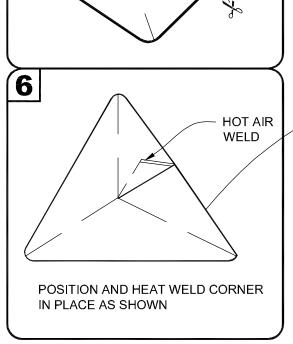

A HOT AIR WELD T-JOINT 1
NOTE:
WHEN USING 60 OR 80-MIL MEMBRANE, APPLY A 4 1/2" (114mm) DIAMETER "T-JOINT" COVER AT ALL FIELD SPLICE INTERSECTIONS.

POSITION FASTENING PLATES 6" TO 9" (152 TO 229mm) FROM THE CORNER AND 1/2" TO 1" (13 TO 25mm) FROM EDGE OF MEMBRANE.

THERMOPLASTIC

CUT ALONG LINES

SCALE: 3" = 1'-0"

REINFORCED MEMBRANE


- CREASE LINE


- APPROXIMATELY 1/8" (3mm) DIAMETER BEAD OF CUT-EDGE SEALANT IS REQUIRED ON CUT EDGES OF REINFORCED TPO MEMBRANE AND RECOMMENDED ON CUT EDGES OF SURE-FLEX PVC MEMBRANE.
- REFER TO CARLISLE SPECIFICATIONS FOR ACCEPTABLE CARLISLE FASTENERS AND PLATES.
- WHEN USING 60 OR 80-MIL MEMBRANE, APPLY A 4-1/2" (114mm) DIAMETER "T-JOINT" COVER AT ALL FIELD SPLICE INTERSECTIONS.


DIMENSIONS		mm	
A	6"	152	APPROX.
B	6"-9"	152-229	
$\overline{\mathbb{C}}$	45-DEGREES APPROX.		




FIELD FABRICATED INSIDE CORNER FLASHING - BASE BID "A"

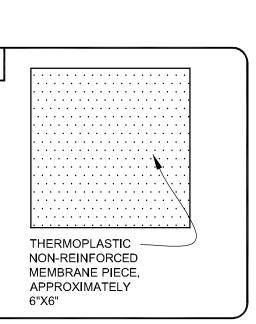

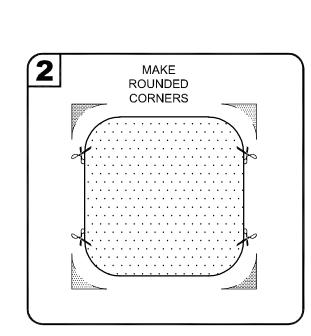

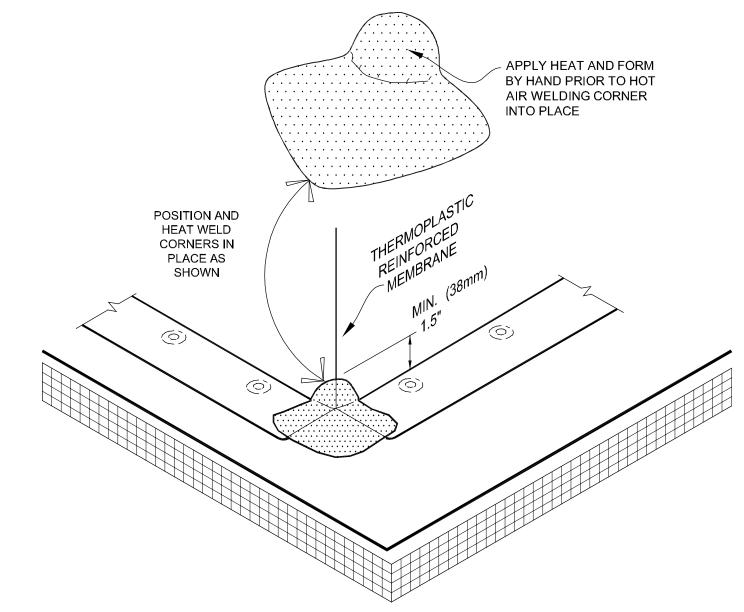

PRE-MOLDED INSIDE CORNER FLASHING - ALTERNATE BID "A-1"

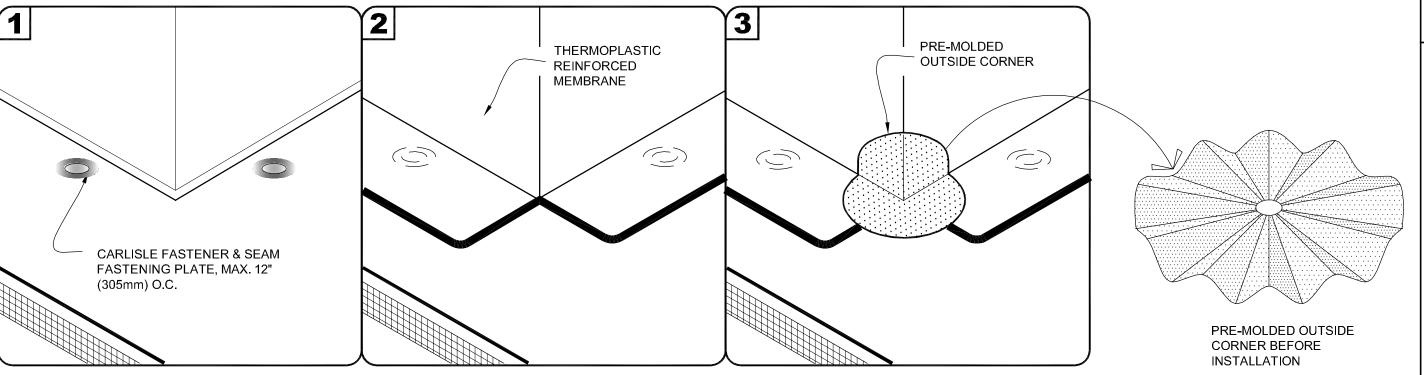

PRE-MOLDED OUTSIDE CORNER FLASHING - ALTERNATE BID "A-1"

PIPING BOOT FLASHING

NOT SHOWN FOR CLARITY

- EXISTING ROOF DECK

TO REMAIN

WATER CUT-OFF MASTIC —

NOTES:

NEW VENT PIPE

SIZE

EXTENSION, MATCH

EXISTING VENT PIPE

FERNCO TYPE PIPE-

EXISTING VENT PIPE

(TO REMAIN)

(PROVIDE (2) CLAMPS,


COUPLING UNIT

NOT SHOWN)


- 1. POSITION FASTENING PLATES 6"(152mm) FROM THE CORNER AND 1/2" TO 1" (13 TO 25mm) FROM EDGE OF
- APPROXIMATELY 1/8" (3mm) DIAMETER BEAD OF CUT-EDGE SEALANT IS REQUIRED ON CUT EDGES OF REINFORCED TPO MEMBRANE AND RECOMMENDED ON CUT EDGES OF SURE-FLEX PVC MEMBRANE.
- 3. REFER TO CARLISLE SPECIFICATIONS FOR ACCEPTABLE CARLISLE FASTENERS AND PLATES.

NOTES:

FIELD FABRICATED OUTSIDE CORNER FLASHING - BASE BID "A"

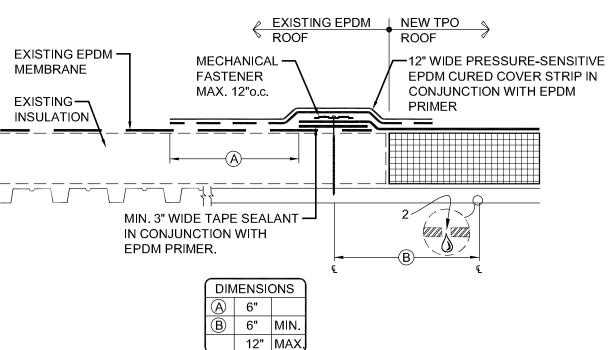


HOT AIR WELD, 1-1/2" (38mm) MIN.

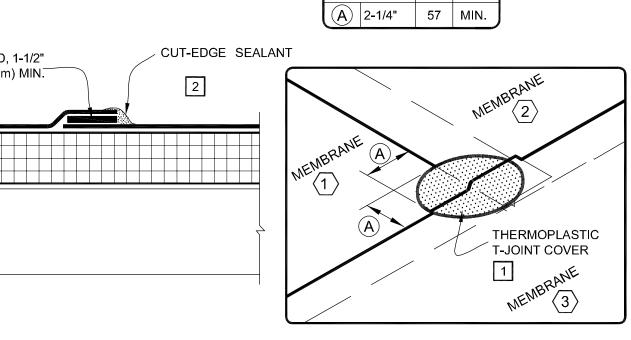


- 1. WHEN USING 60 OR 80-MIL MEMBRANE, APPLY A 4-1/2" (114mm) DIAMETER "T-JOINT" COVER AT ALL FIELD SPLICE INTERSECTIONS.
- 2. APPROXIMATELY 1/8" (3mm) DIAMETER BEAD OF CUT-EDGE SEALANT IS REQUIRED ON CUT EDGES OF REINFORCED TPO MEMBRANE AND RECOMMENDED ON CUT EDGES OF SURE-FLEX PVC MEMBRANE.

3. ALL SPLICE INTERSECTIONS MUST BE OVERLAID WITH PRESSURE-SENSITIVE T-JOINT COVERS.

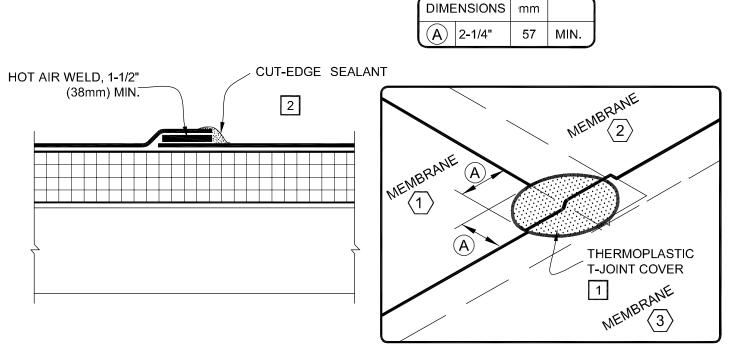

TPO MEMBRANE SPLICE DETAIL

PLUMBING VENT EXTENSION

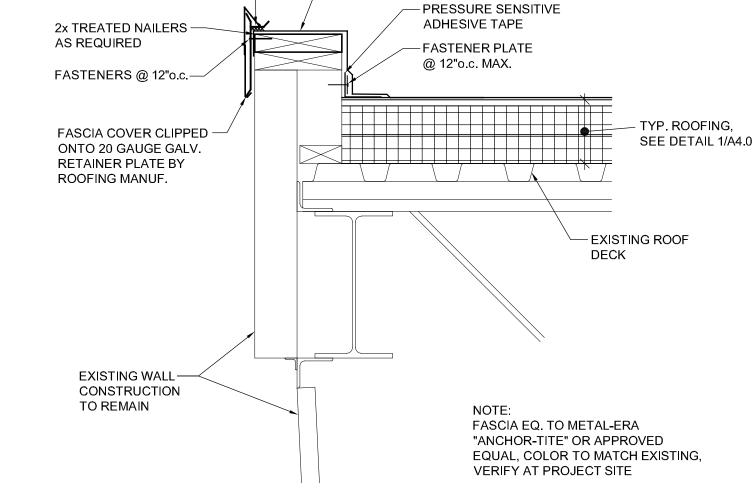

- TPO MEMBRANE UP OVER

TOP AND DOWN 4" (MIN.)

ON FACE



CURRENT DATE: 1/17/2019

LICENSE EXPIRES: 11/30/19

CONSTRUCTION DOCUMENT

PHASE **ISSUED FOR** CONSTRUCTION SUE DATE: 1/17/2019 REVISIONS PROJECT NUMBER: 5774

> **ROOF DETAILS**

DWG. NO. A5.0

1. PRIOR TO SPLICING, CLEAN EXISTING EPDM MEMBRANE BY SCRUBBING THE


2. DRILL A 3/8" (10mm) DIAMETER WEEP HOLE INTO THE BOTTOM FLUTES OF

TO 12" (305mm) MAXIMUM FROM THE SEAM FASTENING PLATE.

SPLICE AREA WITH WEATHERED MEMBRANE CLEANER AND ALLOW TO DRY.


THE STEEL DECK ALONG THE PERIMETER OF THE TIE-IN 6" (152mm) MINIMUM

ROOF FLASHING DETAIL SCALE: 1" = 1'-0"

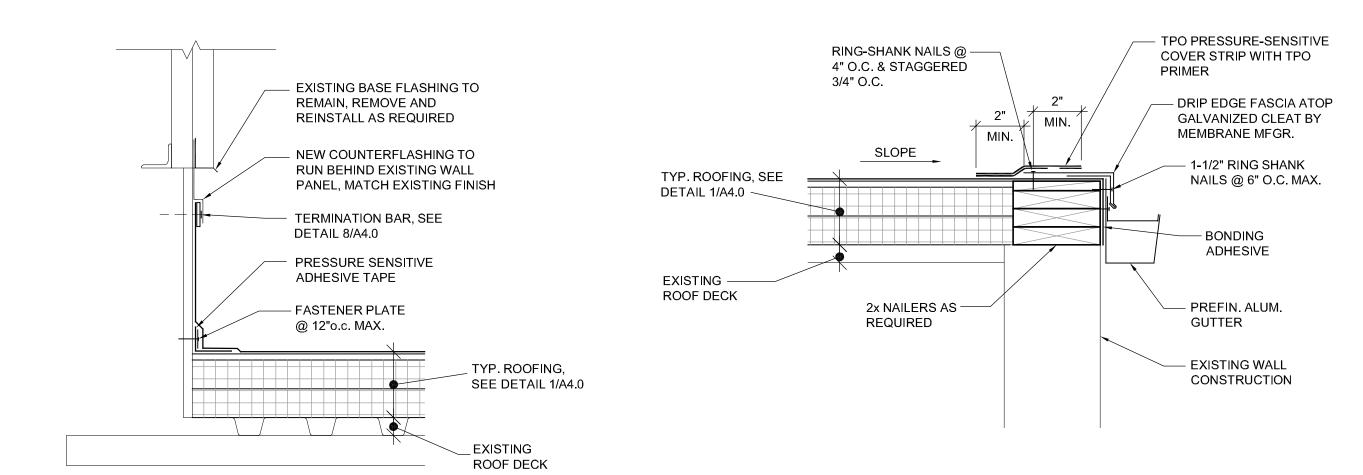


ROOF FLASHING DETAIL SCALE: 1 1/2" = 1'-0"



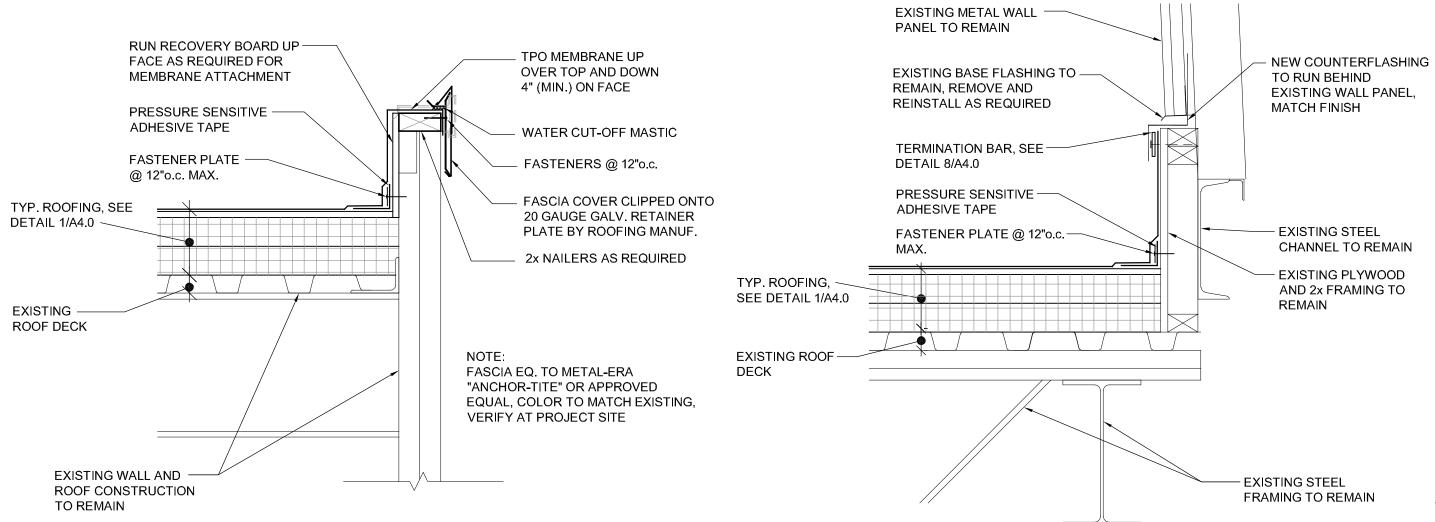

ROOF FLASHING DETAIL SCALE: 1 1/2" = 1'-0"

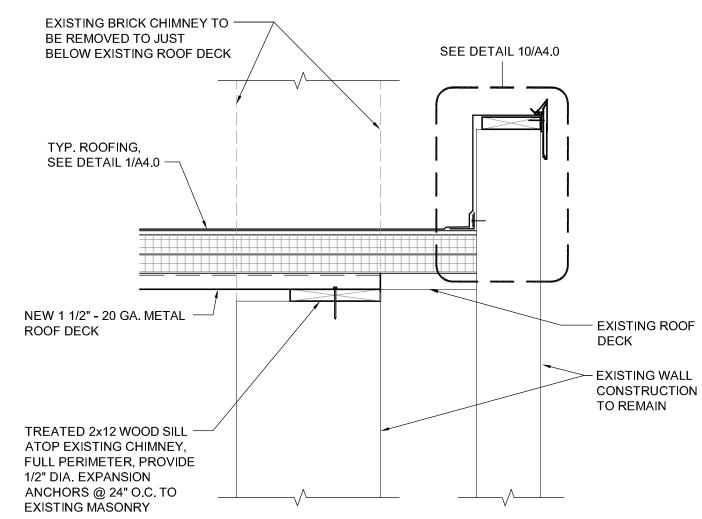

ALTERNATE BID "A-2" CHIMNEY DETAIL

FLASHING DETAIL

CURRENT DATE: 1/17/2019

LICENSE EXPIRES: 11/30/19

CONSTRUCTION DOCUMENT PHASE

ISSUED FOR CONSTRUCTION SSUE DATE: 1/17/2019 REVISIONS

PROJECT NUMBER: 5774

ROOF DETAILS

DWG NO

A6.0